

AJOR SUBCONTRACTORS AND/OR SUPPLIERS	JOR SUBCONTRACTORS AND/OR SUPPLIERS	LL CONSTRUCTION PERFORMED UNDER THIS CONTRACT HAS EEN COMPLETED IN FULL CONFORMITY WITH THE DRAWINGS, DTES AND SPECIFICATIONS CONTAINED IN THESE PLANS ALL HANGES FROM PLANS AS BID, HAVE BEEN NOTED.		CONSTRUCTION DATA	
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	EN COMPLETED IN FULL CONFORMITY WITH THE DRAWINGS, TES AND SPECIFICATIONS CONTAINED IN THESE PLANS ALL	EEN COMPLETED IN FULL CONFORMITY WITH THE DRAWINGS, DTES AND SPECIFICATIONS CONTAINED IN THESE PLANS ALL HANGES FROM PLANS AS BID, HAVE BEEN NOTED.			
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certified)			(Certified)	PROJECT ENGINEER	DATE
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	remenum 42	remenum 42			
PROJECT ENGINEER DATE				NAGON TSPT	

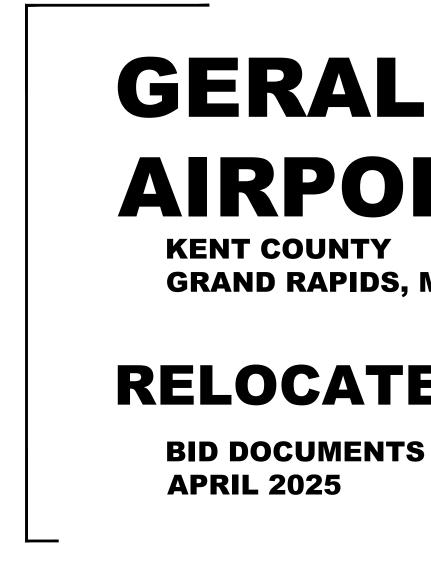

22 DELTA DELTA 49 COMPRENA 55 " 40 20 68 10 TRAVERS 51 57 72 65 83 35 53 67 18 43 26 32 37 64 62 54 56 79 74 saginaw 73 AIRPORT LOCATION -\ 61 59 29 50 47 23 80 39 13 38 81 82 berrien cass st. joseph branch Hillsdale lenawee 11 14 78 12 30 46 MONROE



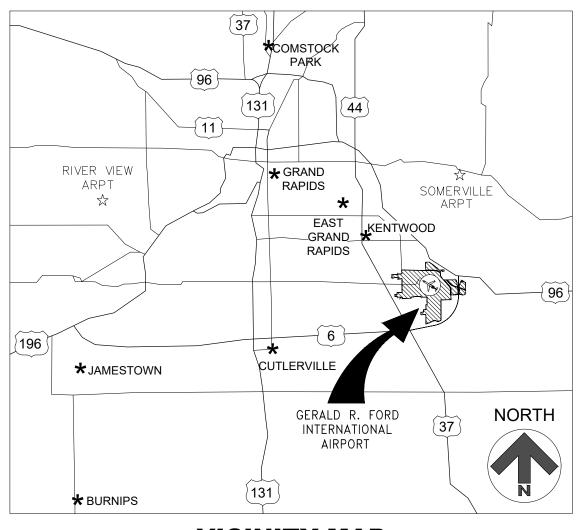

GERALD R. FORD INTERNATIONAL AIRPORT


GRAND RAPIDS, MICHIGAN

RELOCATE CELL PHONE LOT


VICINITY MAP

DATE

SHEI NUME G00 G01 G02 G03 G04 G04 G05 G06 G06 C10 C20 C21 C22 C70 C71

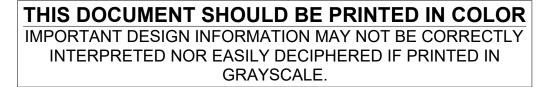


EET /IBER	INDEX OF SHEETS	LATEST REVISION DATE
001	COVER SHEET	
010	SUMMARY OF QUANTITIES	
020	CONTRACT LAYOUT PLAN	
030	SAFETY AND SECURITY NOTES AND DETAILS	
040	CONSTRUCTION SAFETY AND PHASING PLAN	
041	MAINTENANCE OF TRAFFIC PLAN	
050	HORIZONTAL AND VERTICAL CONTROL PLAN	
060	SOIL EROSION AND SEDIMENTATION CONTROL PLAN	
061	SOIL EROSION AND SEDIMENTATION CONTROL NOTES AND DETAILS	
101	DEMOLITION PLAN	
201	SITE PLAN	
210	TYPICAL PAVEMENT SECTION AND JUNCTURE DETAILS	
220	TYPICAL JOINTING DETAILS	
701	PAVEMENT MARKING & SIGNAGE PLAN	
710	PAVEMENT MARKING & SIGNAGE DETAILS	

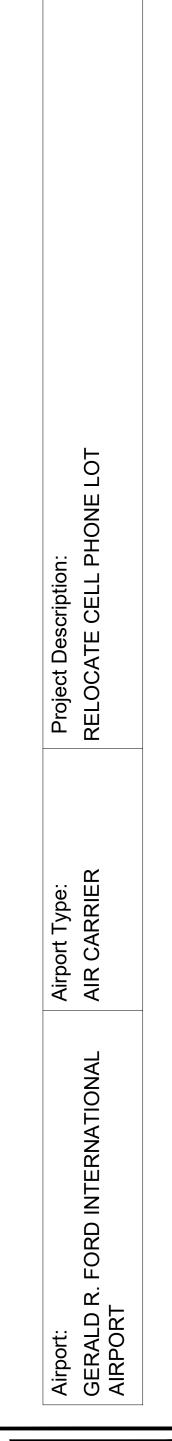

ITEM NUMBER	1 7
SP-01	Contractor Quality Con
SP-02	Reimbursed Utility Moc
110-1	Mobilization, Max (10%
204-1	Curb and Gutter, Rem
204-2	Pavt, Rem
204-3	Sidewalk, Rem
204-4	Fence, Rem
205-1	Subgrade Undercutting
208-1	Erosion Control, Silt Fe
208-2	Erosion Control, Inlet P
308-1	Geotextile, Separator,
801-1	Driveway, Reinf. Conc.
802-1	Curb and Gutter, Conc
810-1	Post-Mounted Road Sig
811-1	Pavt Mrkg, Rem.
812-1	Project Safety & Mainte
816-1	Misc. Hydroseed, Mixtu
824-1	Contractor Survey and
L	,

CONSTRUCTION ITEMS					
ITEM DESCRIPTION	UNIT	BID	CHANGE ORDERS		FINAL
		QUANTITY	1	2	QUANTITY
ractor Quality Control Plan (CQCP)	LSUM	1			
bursed Utility Modifications	ALLOW	1			
lization, Max (10%)	LSUM	1			
and Gutter, Rem	LFT	110			
Rem	SYD	25			
walk, Rem	SFT	250			
e, Rem	LFT	55			
rade Undercutting, Type IV	CYD	50			
on Control, Silt Fence	LFT	55			
on Control, Inlet Protection, Fabric Drop	EACH	8			
extile, Separator, Non-Woven	SYD	140			
way, Reinf. Conc., 6-inch, Including Aggregate Base	SYD	110			
and Gutter, Conc., Integral, Det F4, including Aggregate Base	LFT	100			
Mounted Road Sign, Type IIIA, 24-inch x 24-inch, including Supports	EACH	1			
Mrkg, Rem.	SFT	750			
ct Safety & Maintenance of Traffic	LSUM	1			
Hydroseed, Mixture Turf with Fertilizer, Wood Fiber Mulch, Topsoil	ACRE	0.25			
ractor Survey and Stakeout	LSUM	1			

RS&H Michigan, Inc. 436 S. MAIN STREET PLYMOUTH, MICHIGAN 48170 PH: 734-456-7060 FAX: 1-800-464-4358 www.rsandh.com
GERALD R. FORDInternational Airport
GERALD R. FORD INTERNATIONAL AIRPORT
RELOCATE CELL PHONE LOT
MISS DIG System, Ing. 1-800-482-7171 EEVISIONS
NO. DESCRIPTION DATE
DATE ISSUED: APRIL 2025
REVIEWED BY: APD DRAWN BY: MJD DESIGNED BY: MJD RS&H PROJECT NUMBER
DRAWN BY: MJD DESIGNED BY: MJD RS&H PROJECT NUMBER 1010-0085-003 GFIAA REQUEST NUMBER
DRAWN BY: MJD DESIGNED BY: MJD RS&H PROJECT NUMBER 1010-0085-003 GFIAA REQUEST NUMBER 2510 © 2025 RS&H, INC.
DRAWN BY: MJD DESIGNED BY: MJD RS&H PROJECT NUMBER 1010-0085-003 GFIAA REQUEST NUMBER 2510
DRAWN BY: MJD DESIGNED BY: MJD RS&H PROJECT NUMBER 1010-0085-003 GFIAA REQUEST NUMBER 2510 © 2025 RS&H, INC. SHEET TITLE SUMMARY OF

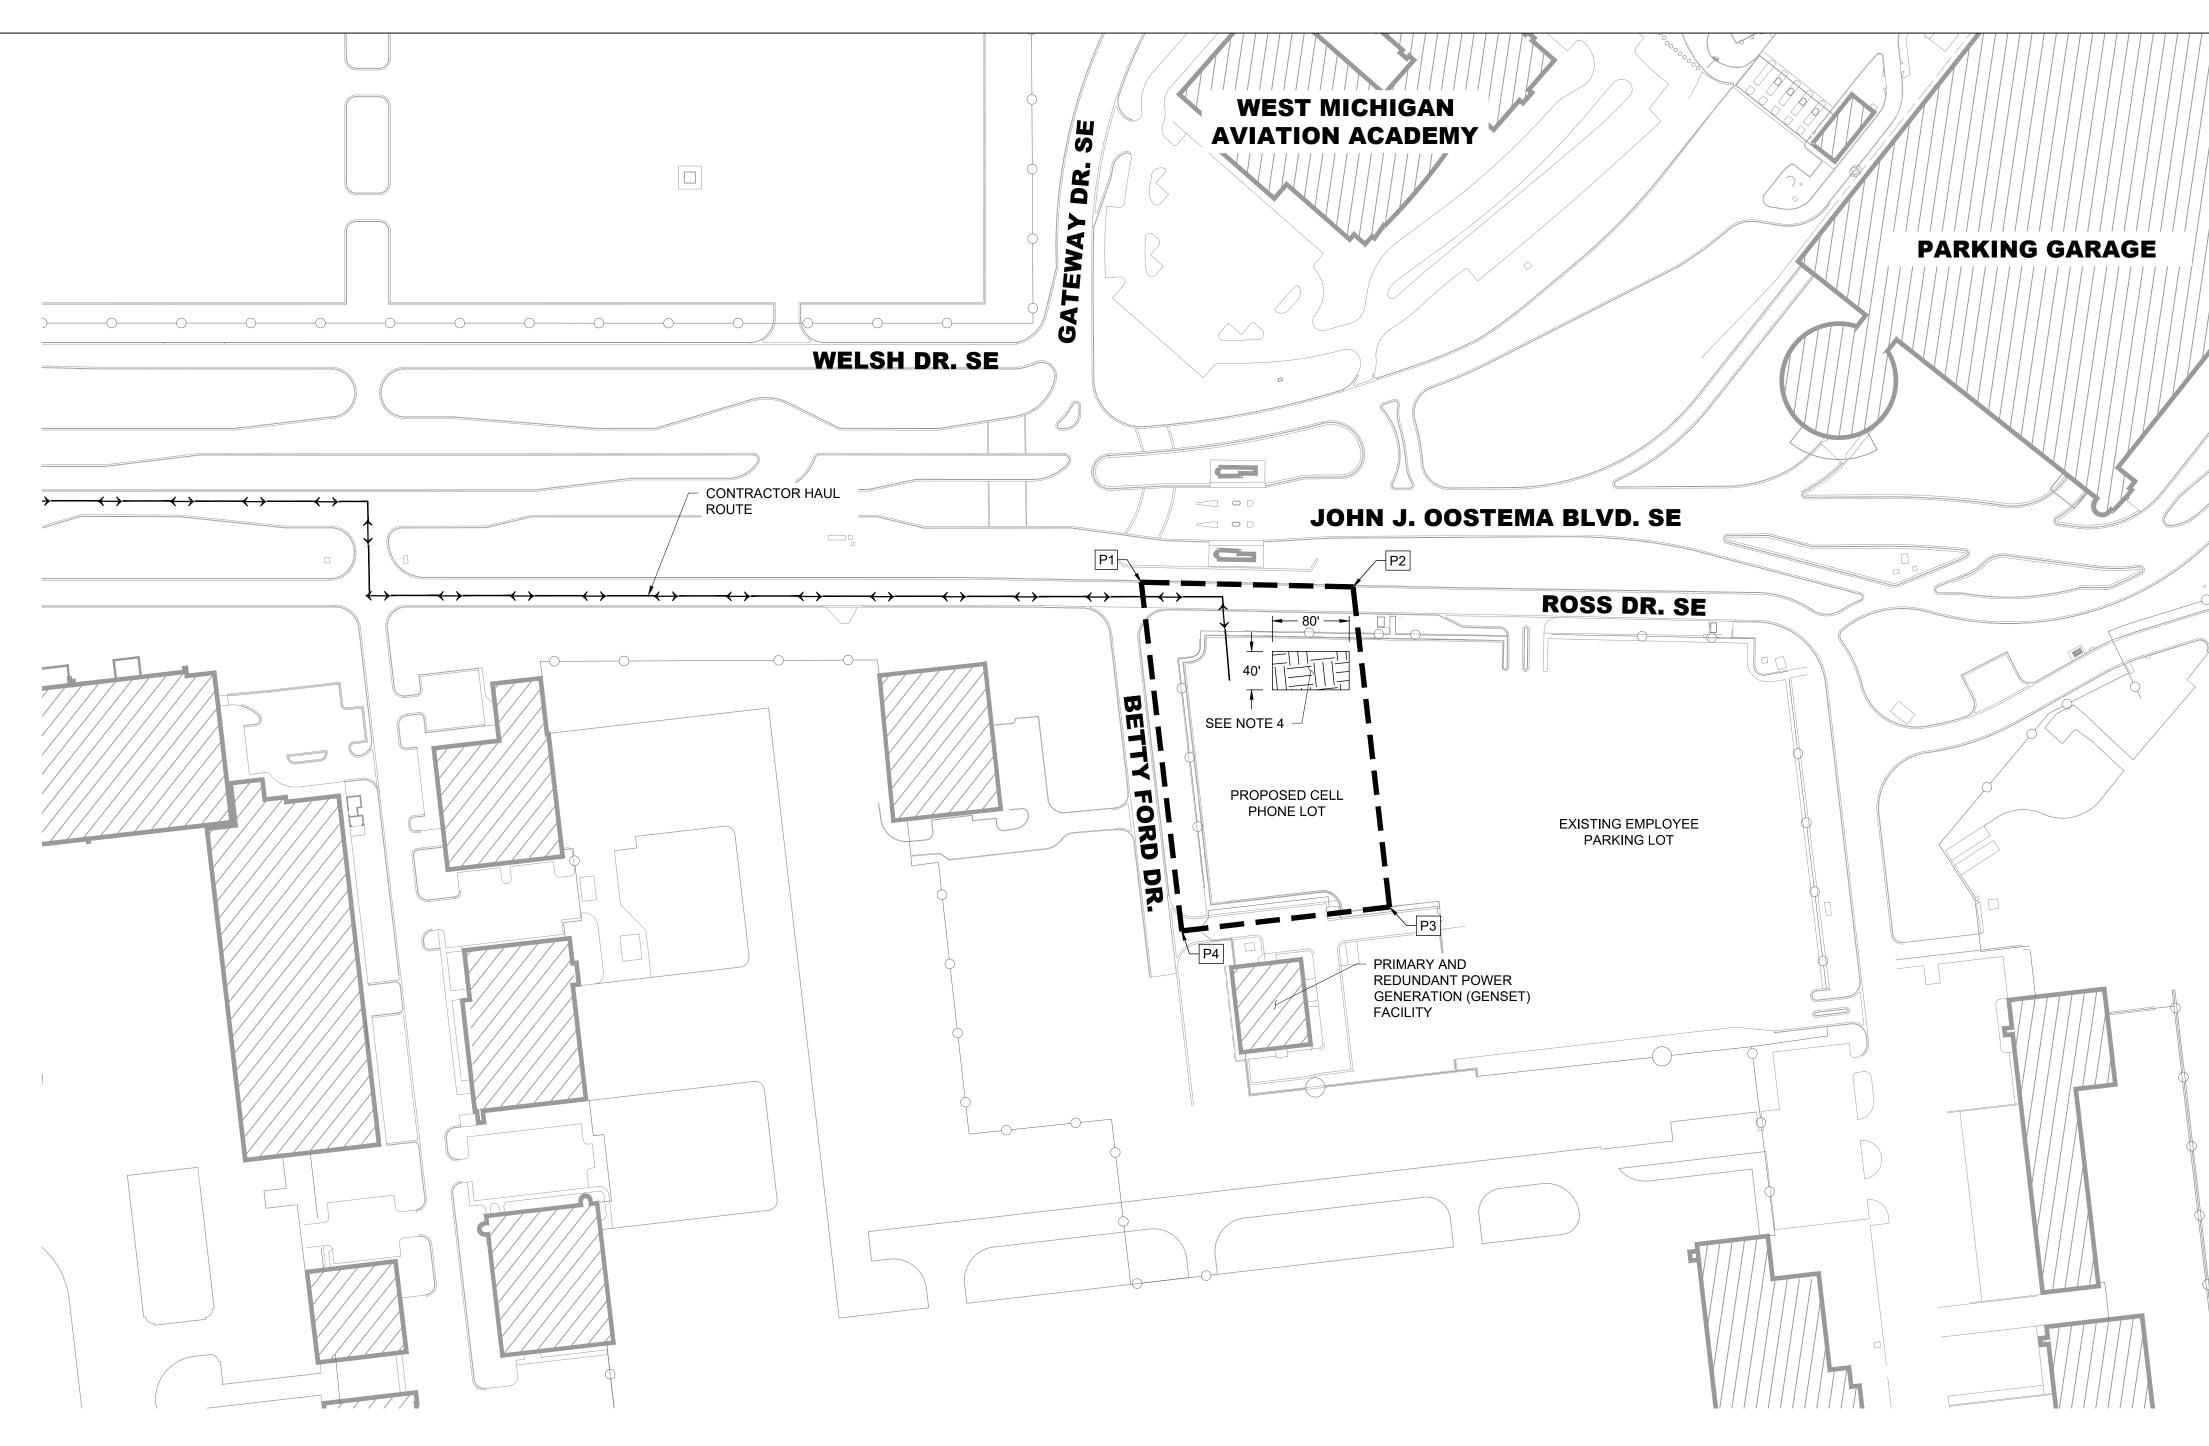

GENERAL CONTRACT NOTES:

1. HAUL ROUTES: LOCATION OF HAUL ROUTES ON THE AIRPORT SITE MUST BE AS SPECIFIED ON THE PLANS OR AS APPROVED BY THE RESIDENT PROJECT REPRESENTATIVE (RPR) AND COORDINATED WITH THE AIRPORT. IT SHALL BE THE CONTRACTOR'S RESPONSIBILITY TO COORDINATE OFF-SITE HAUL ROUTES (STATE HIGHWAYS, COUNTY ROADS OR CITY STREETS) WITH THE APPROPRIATE OWNER WHO HAS JURISDICTION OVER THE AFFECTED ROUTE.

ON-SITE HAUL ROUTES MUST BE MAINTAINED BY THE CONTRACTOR AND WILL BE RESTORED TO THEIR ORIGINAL CONDITION UPON COMPLETION OF BEING USED AS A HAUL ROUTE. THE BEFORE AND AFTER CONDITION OF ON-SITE HAUL ROUTE AREAS WILL BE JOINTLY INSPECTED AND BY THE CONTRACTOR AND THE RPR. ALL COSTS RELATED TO THE MAINTENANCE, AND RESTORATION OF HAUL ROUTE AREAS SHALL BE INCIDENTAL TO THE MOBILIZATION PAY ITEM.

- 2. WASTE DISPOSAL: ALL PAVEMENT MILLINGS, RUBBLE, AND ALL OTHER DEBRIS MUST BE DISPOSED OF OFF AIRPORT PROPERTY IN CONFORMANCE WITH ALL LOCAL AND STATE LAWS. SEE SOIL AND SEDIMENTATION CONTROL NOTES (G061) FOR DISPOSAL INFORMATION OF EXCESS SOIL.
- 3. CONTRACTOR UTILITIES: STAGING AREAS DO NOT HAVE UTILITIES. ANY UTILITIES REQUIRED BY THE CONTRACTOR, MUST BE COORDINATED WITH THE UTILITY COMPANIES AND SHALL BE THE SOLE RESPONSIBILITY OF THE CONTRACTOR.


THE CONTRACTOR WILL BE RESPONSIBLE FOR TEMPORARY RESTROOM FACILITIES FOR ALL CONTRACTOR AND SUBCONTRACTOR PERSONNEL. AT NO TIME WILL THE CONTRACTOR BE ALLOWED TO UTILIZE AIRPORT OR TENANT RESTROOM FACILITIES. TEMPORARY RESTROOM FACILITIES MUST BE LOCATED IN THE CONTRACTOR STAGING AREA, UNLESS OTHERWISE APPROVED BY THE AIRPORT.


- 4. <u>CONTRACTOR STAGING AREAS</u>: THE CONTRACTOR MAY USE THE PROPOSED CELL PHONE LOT AREA AS A STAGING AND PARKING AREA. STAGING AND PARKING AREAS ARE SUBJECT TO ALL AIRPORT SAFETY AND SECURITY REQUIREMENTS, SEE SHEET G030. THE CONTRACTOR SHALL PROTECT ALL EXISTING PAVEMENT WITHIN THE STAGING AREA. ANY DAMAGE CAUSED TO THE EXISTING PAVEMENT NOT CALLED TO BE IMPACTED SHALL BE RESTORED TO ITS PREVIOUS CONDITION AT NO ADDITIONAL COST TO THE OWNER.
- 5. CONTRACT LAYOUT PLAN: THIS PLAN IS INTENDED ONLY AS A GENERAL DESCRIPTION OF WORK ITEMS AND APPROXIMATE LOCATIONS AND LIMITS FOR THE PURPOSE OF UNDERSTANDING THE SCOPE OF THE WORK. IT MUST NOT BE USED AS A CONSTRUCTION PLAN. REFER TO PLAN SHEETS WHICH FOLLOW FOR DETAILED CONSTRUCTION REQUIREMENTS, LOCATIONS, AND ITEMS OF WORK.
- 6. <u>SAFETY AND PHASING</u>: THE CONTRACTOR MUST COMPLY WITH THE SAFETY AND PHASING PLAN (SHEET G040), THE AIRPORT SAFETY REQUIREMENTS SECTIONS ON SHEET G030, AND THE SPECIFICATIONS. THESE WILL BE STRICTLY ENFORCED.

- 7. COMPLETION OF WORK: UPON COMPLETION OF THE WORK, THE CONTRACTOR SHALL REMOVE FROM THE SITE ALL TEMPORARY FACILITIES, SURPLUS MATERIAL, AND EQUIPMENT BELONGING TO THEM OR THEIR SUBCONTRACTOR'S FORCES. PRIOR TO REMOVAL FROM AIRPORT PROPERTY OF SURPLUS MATERIALS, THE CONTRACTOR MUST OBTAIN WRITTEN PERMISSION OF THE OWNER.
- 8. PRE-CONSTRUCTION CONFERENCE: THE CONTRACTOR MUST ATTEND A PRE-CONSTRUCTION CONFERENCE PRIOR TO BEGINNING WORK TO COORDINATE WORK PROCEDURES WITH ALL INTERESTED PARTIES. THE CONTRACTOR MUST ALSO ATTEND ANY JOB MEETINGS CALLED BY THE OWNER.
- 9. PERMITS: IT IS THE RESPONSIBILITY OF THE CONTRACTOR TO PREPARE, OBTAIN, AND PAY FOR ALL APPLICABLE PERMITS FOR CONSTRUCTION AND EQUIPMENT. THIS SHALL INCLUDE ALL COSTS RELATED TO PERMITS REQUIRED FOR SOIL EROSION AND SEDIMENTATION CONTROL, NPDES, DEMOLITION, ETC. ALL FEES SHALL BE INCLUDED IN ITEM 110-1 "MOBILIZATION".

PROJ	PROJECT LIMITS - COORDINATE TABLE			
POINT	LATITUDE	LONGITUDE		
P1	N042° 53' 00.83"	W085° 32' 06.87"		
P2	N042° 53' 00.86"	W085° 32' 03.91"		
P3	N042° 52' 57.58"	W085° 32' 03.23"		
P4	N042° 52' 57.26"	W085° 32' 06.13"		

	N	ORTH		
SCALE IN FEET				
100'	50'	Q	100'	

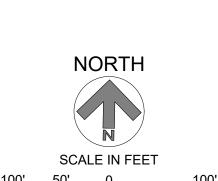

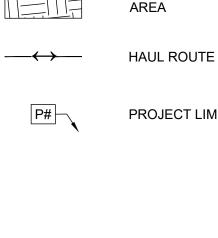

LEGEND:

PROPOSED WORK LIMITS

EXISTING BUILDING

CONTRACTOR STAGING AND PARKING

PROJECT LIMIT COORDINATE POINT

RELOCATE CELL PHONE LOT

MISS DIG System. Inc.

1-800-482-7171

NO. DESCRIPTION DATE

DATE ISSUED: APRIL 2025

MJD

RS&H PROJECT NUMBER 1010-0085-003

GFIAA REQUEST NUMBER

2510

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SHEET TITLE

CONTRACT

LAYOUT PLAN

SHEET NUMBER

G020

BID DOCUMENTS

REVIEWED BY: APD

DESIGNED BY: MJD

DRAWN BY:

REVISIONS

GERALD R. FORD INTERNATIONAL

AIRPORT





RSEH

RS&H Michigan, Inc.

436 S. MAIN STREET PLYMOUTH, MICHIGAN 48170

AIRPORT'S	SAFETY	AND	SECURI

S	AFETY:	S	ECU
1.	THE CONTRACTOR MUST ACQUAINT HIS SUPERVISORS AND EMPLOYEES WITH THE AIRPORT ACTIVITY AND OPERATIONS THAT ARE INHERENT TO THIS AIRPORT AND CONDUCT THE CONSTRUCTION ACTIVITIES TO CONFORM TO ALL ROUTINE AND EMERGENCY REQUIREMENTS AND GUIDELINES ON SAFETY AS SPECIFIED IN NOTE NO. 4 BELOW. ALL CONTRACTOR CONSTRUCTION COMMUNICATIONS WITH GERALD R. FORD INTERNATIONAL AIRPORT AUTHORITY (GFIAA) OPERATIONS OR ADMINISTRATION MUST BE VIA AIRPORT COMMUNICATIONS, 616-233-6000 OR AS DIRECTED BY GFIAA STAFF. THIS NUMBER SHOULD BE USED IN CASE OF EMERGENCIES AS WELL. CONTRACTOR MUST PROVIDE GFIAA AND THE ENGINEER WITH A CONTACT NUMBER FOR THE ON-SITE SUPERVISOR THAT CAN BE REACHED 24 HOURS A DAY, SEVEN DAYS A WEEK. THE SUPERVISOR SHALL HAVE AUTHORITY TO MAKE DECISIONS IN RESOLVING ANY EMERGENCY OR OTHER ISSUES.	1.	ACCESS POINTS BE EXP TRAFFIN SECURI COORD THE CO POINTS
2.	OPEN FLAME WELDING OR TORCH CUTTING OPERATIONS ARE PROHIBITED UNLESS ADEQUATE FIRE AND SAFETY PRECAUTIONS HAVE BEEN TAKEN AND THE PROCEDURE IS APPROVED AND A HOT WORK PERMIT IS OBTAINED FROM GFIAA.		GATE C MUST M APPRO
3.	DEBRIS, WASTE AND LOOSE MATERIAL CAPABLE OF CAUSING DAMAGE TO AIRCRAFT ARE NOT ALLOWED ON ACTIVE AIRCRAFT OPERATING SURFACES. IF THESE MATERIALS ARE OBSERVED TO BE ON ACTIVE AIRCRAFT OPERATING SURFACES, THE CONTRACTOR MUST INFORM GFIAA OPERATIONS IMMEDIATELY. DEBRIS, WASTE AND LOOSE MATERIAL WILL BE REMOVED IMMEDIATELY AND/OR CONTINUOUSLY DURING CONSTRUCTION BY USE OF VACUUM TRUCK (SEE SAFETY NOTE 5 BELOW).		THE CO
4.	CONSTRUCTION DURING THE PROJECT MAY BE HALTED AT ANY TIME BY THE RPR OR ENGINEER IF IT IS DETERMINED TO BE IN THE BEST INTEREST OF AIRPORT OPERATIONS OR SAFETY. THE CONTRACTOR MAY BE DIRECTED TO REMOVE EQUIPMENT AND/OR EVACUATE THE SITE. NECESSARY EXTENSIONS IN CONTRACT TIME WILL BE GRANTED OR A STOP WORK ORDER WILL BE ISSUED DUE TO THESE DELAYS. HOWEVER, THERE WILL BE NO ADJUSTMENTS IN CONTRACT COST DUE TO THESE DELAYS.	2.	ROUTE <u>MATERI</u> A DELIV
5.	THE CONTRACTOR SHALL PROVIDE A FULLY OPERATIONAL, SELF-CONTAINING VACUUM TRUCK . THE VACUUM TRUCK MUST BE AVAILABLE FOR THE DURATION OF THE PROJECT AND WITH AN OPERATOR AT THE DISCRETION OF THE ENGINEER TO VACUUM PAVEMENT AREAS ADJACENT TO THE CONSTRUCTION AREAS TO ENSURE NO FOREIGN OBJECT DEBRIS IS PRESENT ON PAVEMENTS WITHIN 500 FEET OF ANY CONSTRUCTION AREA. THE COST OF THE VACUUM TRUCK MUST BE INCLUDED IN THE SAFETY AND SECURITY BID ITEM.	3.	AIRPOR WILL BE CONSTI PARKIN CONSTI
6.	FAILURE TO COMPLY WITH ANY OF THE SAFETY AND SECURITY REQUIREMENTS MAY RESULT IN ANY OR ALL OF THE. FOLLOWING ACTIONS: -PROJECT SHUT DOWN -REMOVAL FROM AIRPORT (PERSONNEL AND/OR EQUIPMENT)		PERIME TEMPO TYPE O REPRES
	-FINES, IN ACCORDANCE WITH AIRPORT RULES AND REGULATIONS	4.	SUPER SUBCO
7.	THE CONTRACTOR'S EQUIPMENT STORAGE AREA MUST BE WITHIN THE CONSTRUCTION SITE OR WITHIN THE STAGING AREA AS SHOWN ON THE CONTRACT LAYOUT. THE CONTRACTOR'S EQUIPMENT AND CONSTRUCTION VEHICLES ARE RESTRICTED TO THE CONSTRUCTION SITE OR STORAGE AREAS DURING CONSTRUCTION AND PARKED IN THE STAGING AREA DURING NON-WORKING PERIODS. EQUIPMENT HEIGHT MUST NOT EXCEED 25 FEET; EQUIPMENT USED DURING PAVER ASSEMBLY CAN NOT EXCEED 25 FEET IN HEIGHT.	5.	

ITY REQUIREMENTS

IRITY:

S TO THE SITE: CONTRACTOR'S ACCESS TO THE SITE MUST BE AS SHOWN ON THE PLANS. NO OTHER ACCESS S ARE ALLOWED UNLESS APPROVED BY GFIAA. ALL CONTRACTOR TRAFFIC AUTHORIZED TO ENTER THE SITE MUST ERIENCED IN THE ROUTE OR GUIDED BY CONTRACTOR PERSONNEL. THE CONTRACTOR IS RESPONSIBLE FOR IC CONTROL TO AND FROM THE VARIOUS CONSTRUCTION AREAS ON THE SITE, AND FOR THE OPERATION AND RITY OF ACCESS TO THE SITE. A CONTRACTOR'S FLAGPERSON OR TRAFFIC CONTROL PERSON MUST MONITOR AND DINATE ALL CONTRACTOR TRAFFIC AT THE ACCESS POINT.

ONTRACTOR MUST NOT PERMIT ANY UNAUTHORIZED CONSTRUCTION PERSONNEL OR TRAFFIC ON THE SITE. ACCESS S TO THE SITE MUST BE SECURED AND LOCKED AT ALL TIMES WHEN NOT ATTENDED BY THE CONTRACTOR. THE OR GATE ARM MUST BE CLOSED AFTER EACH ACCESS. THE GATE GUARD MUST BE PROFESSIONALLY TRAINED AND MAINTAIN A CONTRACTOR VEHICLE "ACTIVITY LOG" AS SUPPLIED BY THE OWNER. GATE GUARDS MUST HAVE AN PRIATE MEANS OF COMMUNICATION TO CONTACT ADDITIONAL GATE MONITORS TO PROVIDE FOR BATHROOM, AND OTHER BREAK PERIODS. AT NO TIME CAN THE GATE GUARD LEAVE THE UNSECURED GATE UNATTENDED UT AN APPROPRIATELY TRAINED SUBSTITUTE GUARD.

ONTRACTOR IS RESPONSIBLE FOR THE IMMEDIATE CLEANUP OF ANY DEBRIS DEPOSITED ALONG THE ACCESS ROUTE ESULT OF HIS CONSTRUCTION TRAFFIC. DIRECTIONAL SIGNING FROM THE ACCESS POINT ALONG THE DELIVERY TO THE STORAGE AREA OR WORK SITE ARE AS DIRECTED BY GFIAA.

IAL DELIVERY TO THE SITE: ALL CONTRACTOR'S MATERIAL ORDERS FOR DELIVERY TO THE WORK SITE WILL USE AS VERY ADDRESS, THE STREET NAME ASSIGNED TO THE ACCESS POINT AT THE CONTRACTOR'S STAGING SITE AT THE RT. DELIVERIES MUST REFERENCE THE PROJECT NAME AND CONTRACTOR'S NAME. THIS CONSTRUCTION ADDRESS E DETERMINED AT THE PRE-CONSTRUCTION MEETING.

RUCTION AREA LIMITS: THE LIMITS OF CONSTRUCTION, MATERIAL STORAGE AREAS, EQUIPMENT STORAGE AREA, IG AREA AND OTHER AREAS DEFINED AS REQUIRED FOR THE CONTRACTOR'S EXCLUSIVE USE DURING RUCTION MUST BE MARKED BY THE CONTRACTOR. THE CONTRACTOR MUST ERECT AND MAINTAIN AROUND THE ETER OF THESE AREAS SUITABLE FENCING, MARKING AND/OR WARNING DEVICES VISIBLE FOR DAY/NIGHT USE. DRARY BARRICADES. FLAGGING AND FLASHING WARNING LIGHTS WILL BE REQUIRED AT CRITICAL ACCESS POINTS. OF MARKING AND WARNING DEVICES MUST BE APPROVED BY THE GFIAA, THROUGH THE RESIDENT PROJECT SENTATIVE (RPR).

VISION: CONTRACTOR MUST, AT ALL TIMES, HAVE A SUPERVISOR ON SITE DURING ALL OPERATIONS INCLUDING ALL NTRACTOR OPERATIONS.

FICATION VEHICLES: THE CONTRACTOR MUST ESTABLISH AND MAINTAIN A LIST OF CONTRACTOR AND INTRACTOR VEHICLES AUTHORIZED TO OPERATE ON THE SITE WHICH MUST BE MADE AVAILABLE UPON DEMAND BY PR OR GFIAA. EACH VEHICLE MUST DISPLAY A LARGE COMPANY SIGN ON BOTH SIDES OF THE VEHICLE. THE ACTOR MUST PROVIDE THE GFIAA THROUGH THE RPR, WITH A CURRENT LIST OF COMPANIES AUTHORIZED TO AND CONDUCT WORK ON THE AIRPORT. CONTRACTOR EMPLOYEE VEHICLES WILL BE RESTRICTED TO THE ACTOR'S EMPLOYEE PARKING AREA AS DESIGNATED ON THE PLANS.

6. FINES: PAYMENT OF ALL FINES ASSESSED TO GFIAA DUE TO FAA OR TSA VIOLATIONS BY THE CONTRACTOR WILL BE THE SOLE RESPONSIBILITY OF THE CONTRACTOR. SUCH FINES WILL BE DEDUCTED FROM THE CONTRACT VIA CHANGE ORDER.

PROJECT SAFETY NARRATIVE:

- INSTALLATION OF PAVEMENT MARKINGS, AND SITE RESTORATION.
- CLOSURES ARE NEEDED.
- 3. BASIS FOR DEVIATING FROM STANDARDS: NOT APPLICABLE.
- 4. HEIGHT OF CONSTRUCTION EQUIPMENT: 25 FEET (ANY TYPE)* EQUIPMENT IS ALLOWED ON THE CONSTRUCTION SITE.
- 5. DATES FOR START AND COMPLETION:


ESTIMATED START:	MAY 2025
ESTIMATED COMPLETE:	MAY 2025
TOTAL CONTRACT TIME:	REFER TO

1. THIS PROJECT INCLUDES APPROXIMATELY 110 SYD OF CONCRETE PAVEMENT, CURB & GUTTER INSTALLATION,


2. THERE IS NO CONSTRUCTION ACTIVITY ANTICIPATED WITHIN THE AIRPORT OPERATIONS AREA (AOA). NO AIRFIELD

*- FAA APPROVAL MUST BE OBTAINED FOR ANY CONSTRUCTION EQUIPMENT EXPECTED TO EXCEED 25 FEET, BEFORE THE

REFER TO SHEET G040 - CONSTRUCTION SAFETY AND PHASING PLAN

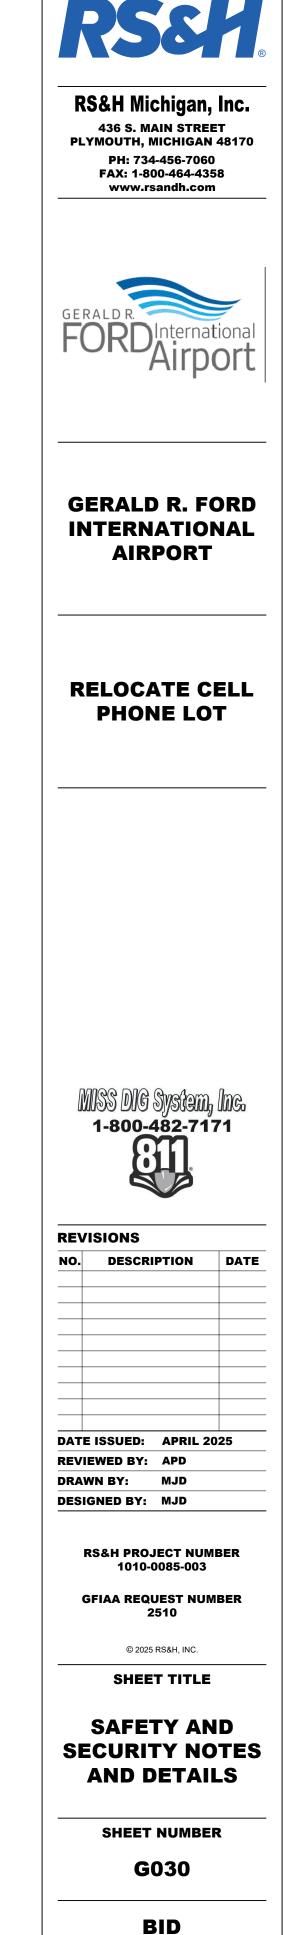


DOCUMENTS

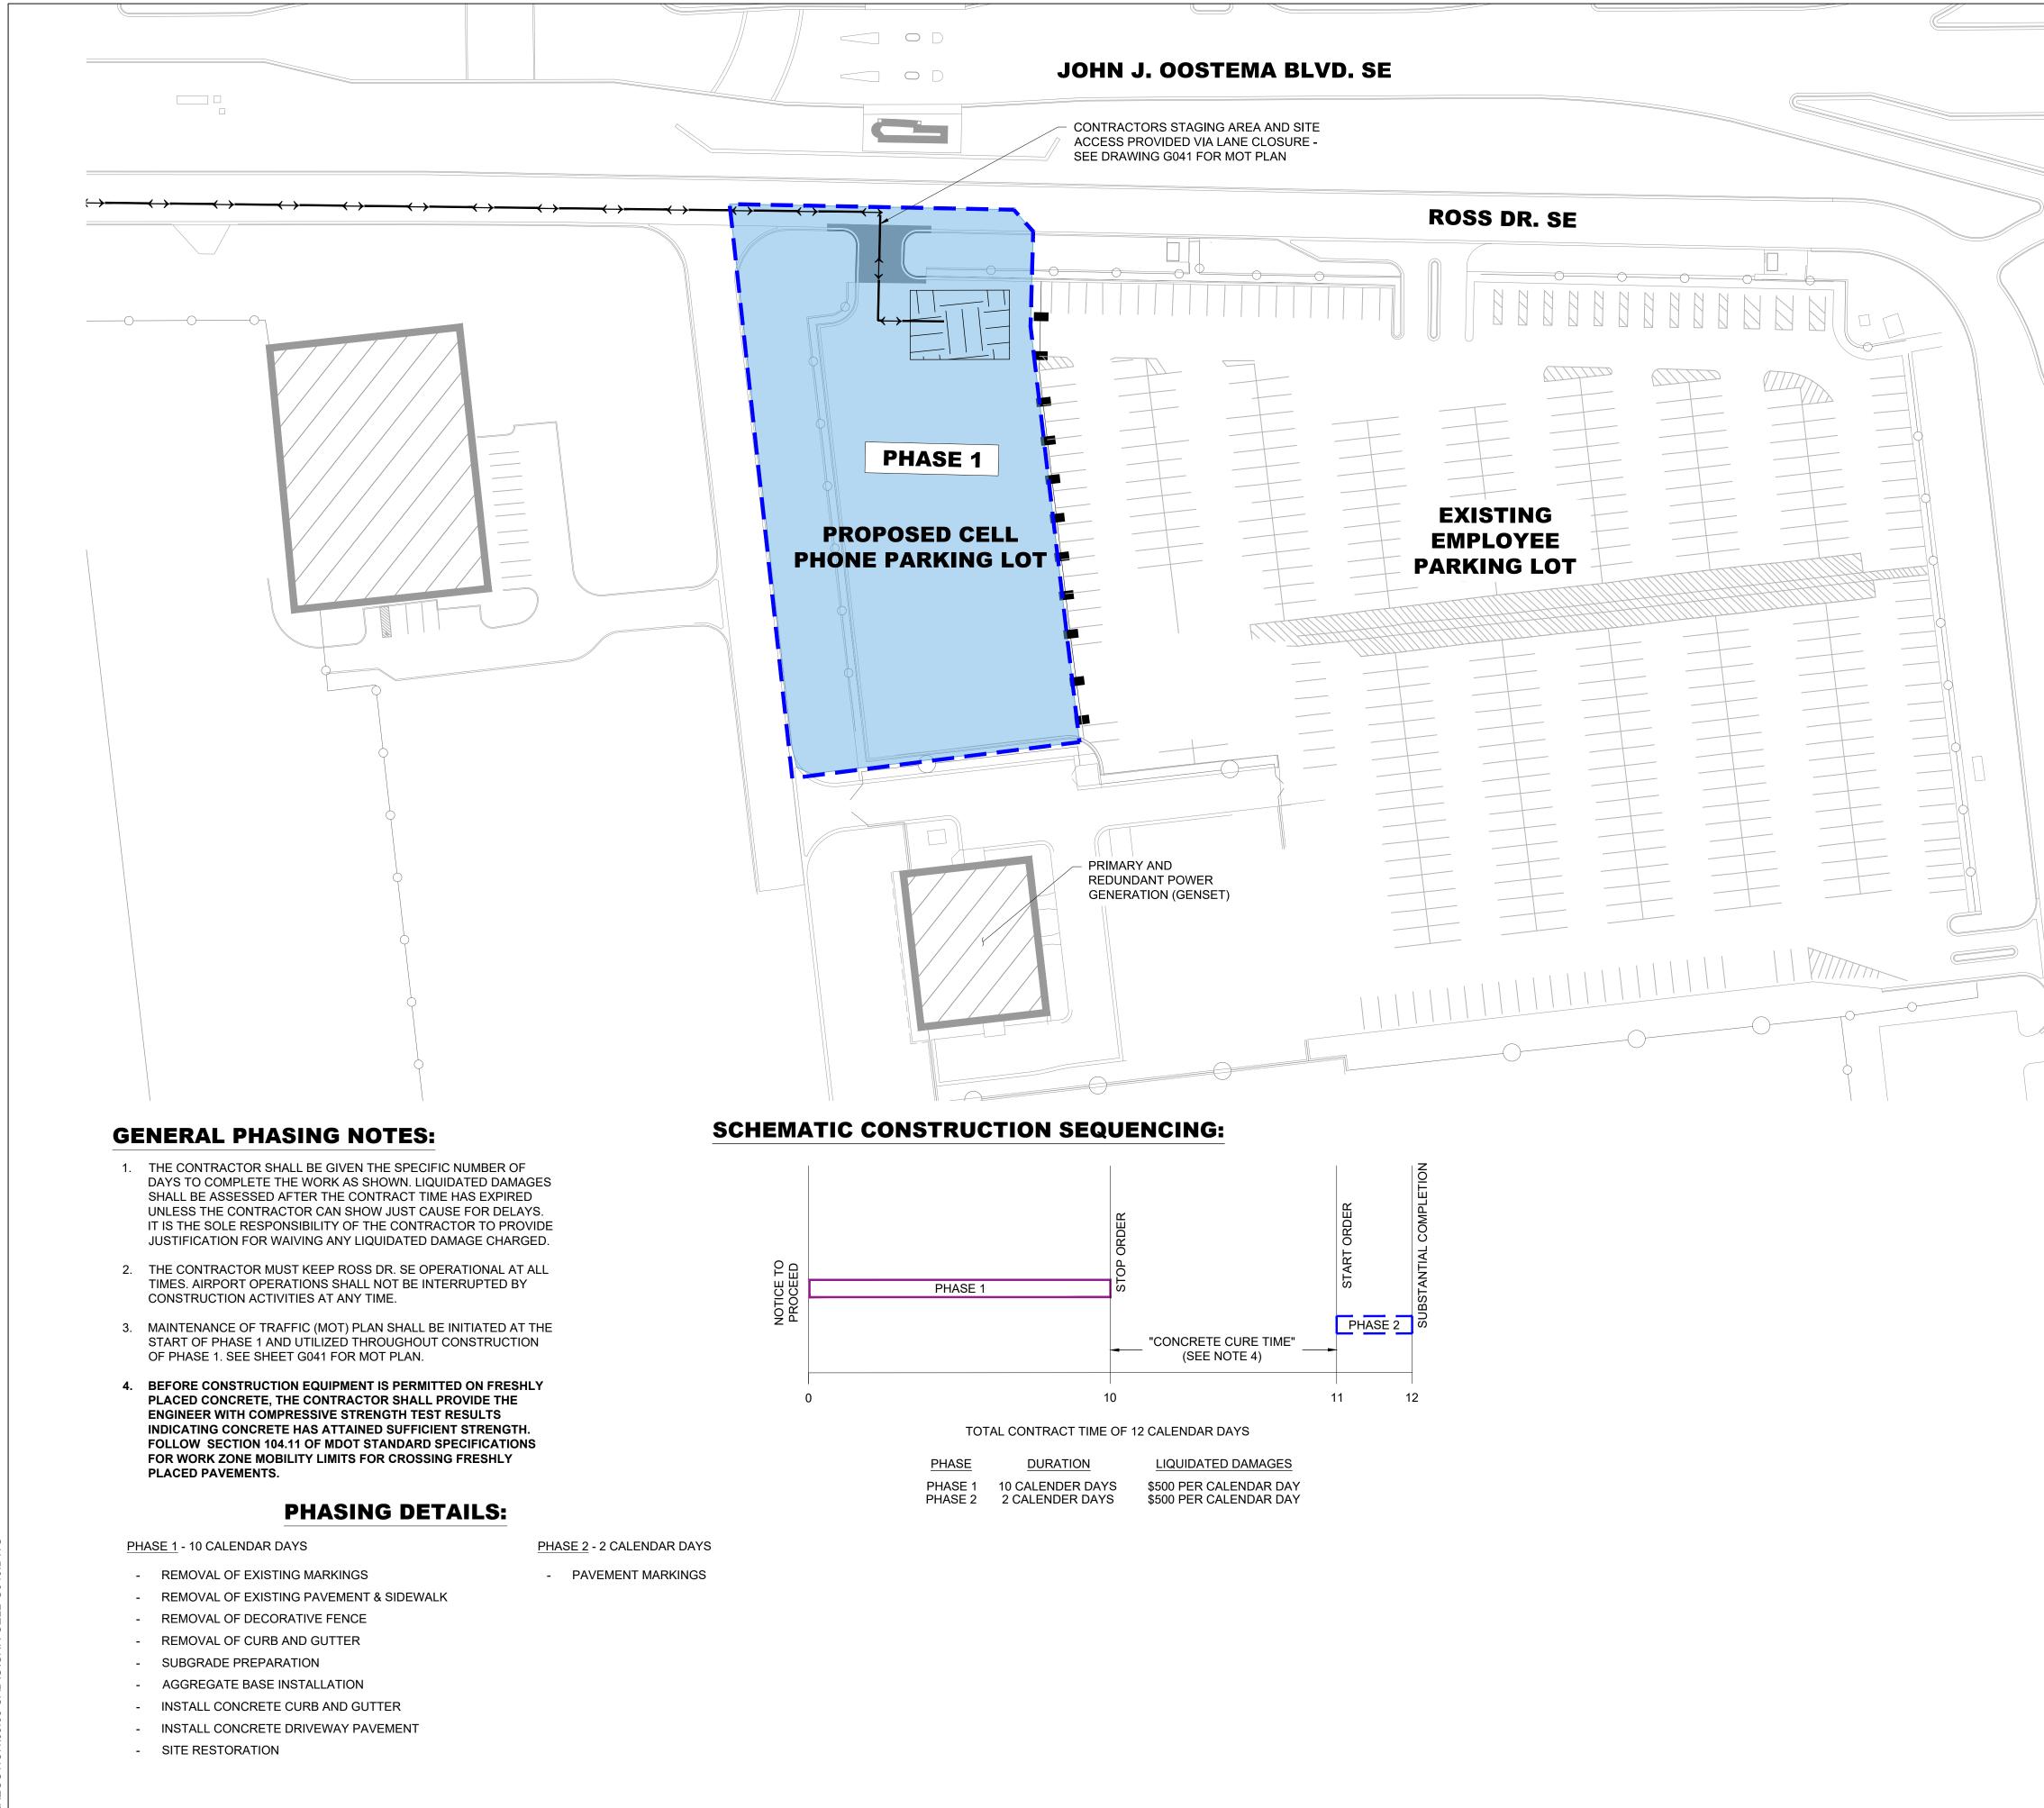

3/2023 .IBERM 2/13 DIL

LEGEND:

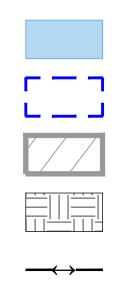

PHASE 1 LIMITS


PHASE 2 LIMITS


EXISTING BUILDING


CONSTRUCTION STAGING AND PARKING AREA

CONSTRUCTION HAUL ROUTE

REFLECTIVE TRAFFIC DRUM - BY OWNER

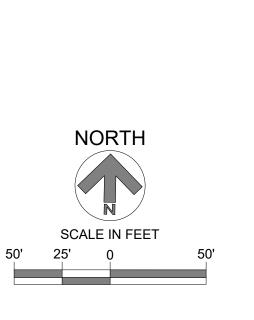

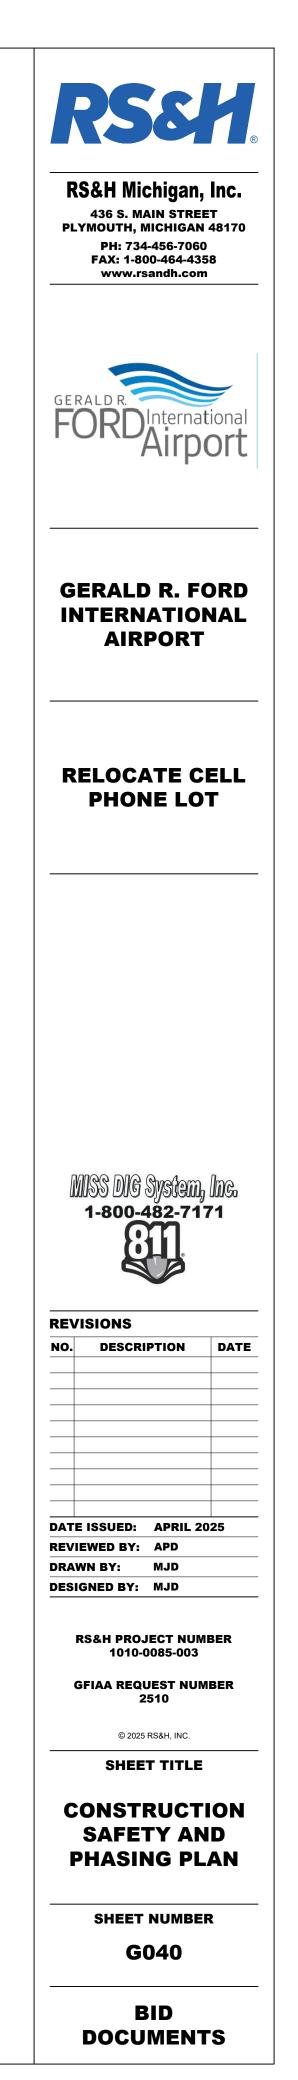

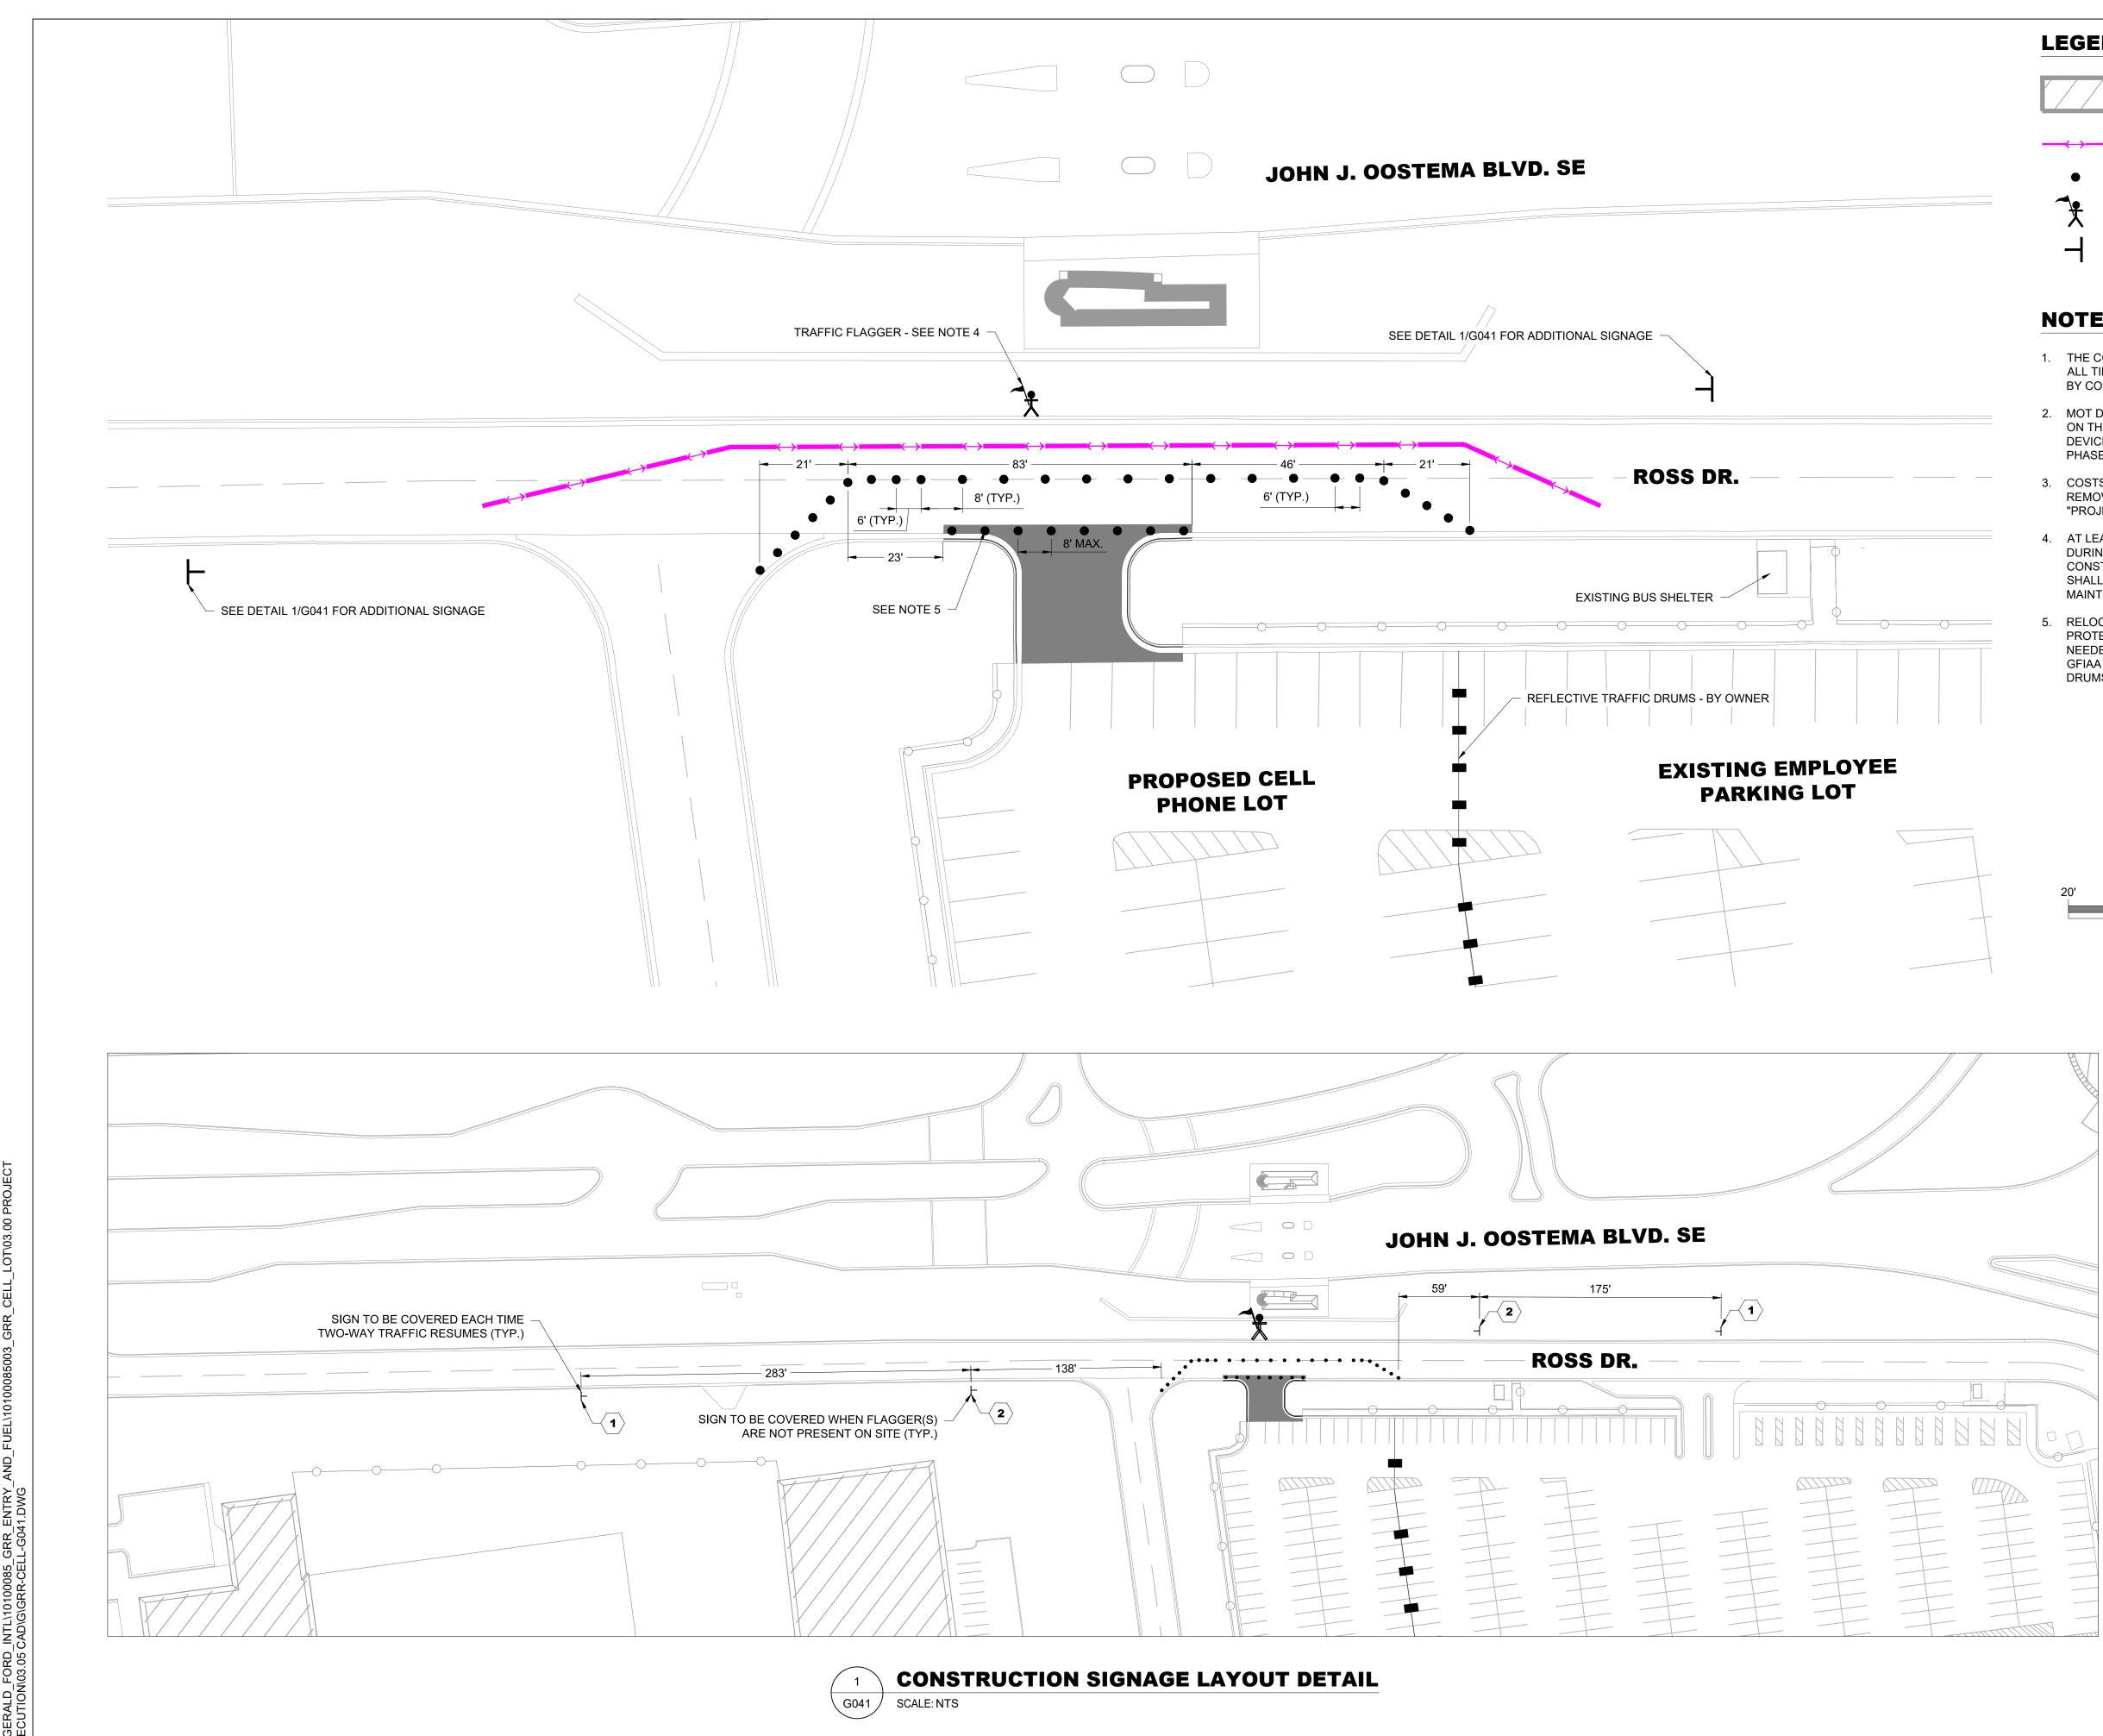

2/13/2023 DILIBERM

LEGEND:



EXISTING BUILDING

PHASE 1 GENERAL PUBLIC TRAFFIC ROUTE


REFLECTIVE TRAFFIC DRUM

TRAFFIC FLAGGER

MAINTENANCE OF TRAFFIC SIGN

NOTES:

- 1. THE CONTRACTOR MUST KEEP ROSS DR. SE OPERATIONAL AT ALL TIMES. AIRPORT OPERATIONS SHALL NOT BE INTERRUPTED BY CONSTRUCTION ACTIVITIES AT ANY TIME.
- 2. MOT DEVICES MUST BE INSTALLED AT THE LOCATIONS SHOWN ON THE PLAN THROUGH COORDINATION WITH GFIAA. MOT DEVICES MUST BE INSTALLAED AT THE BEGINNING OF EACH PHASE AND REMAIN IN PLACE THROUGHOUT THE PHASE.
- COSTS FOR INSTALLING, MAINTAINING, RELOCATING, AND REMOVING MOT DEVICES WILL BE INCLUDED IN PAY ITEM 812-1 "PROJECT SAFETY & MAINTENANCE OF TRAFFIC".
- 4. AT LEAST ONE (1) TRAFFIC FLAGGER SHALL BE PROVIDED DURING DAYTIME HOURS AND DURING ALL HOURS OF ACTIVE CONSTRUCTION. THE COST OF PROVIDING TRAFFIC FLAGGER(S) SHALL BE INCLUDED IN ITEM 812-1 "PROJECT SAFETY & MAINTENANCE OF TRAFFIC".
- RELOCATE REFLECTIVE TRAFFIC DRUMS AS NEEDED TO PROTECT CURING CONCRETE OR WHEN LANE CLOSURE IS NOT NEEDED. CONTRACTOR MUST REQUEST PERMISSION FROM GFIAA AND/OR THE ENGINEER BEFORE RELOCATING TRAFFIC DRUMS.

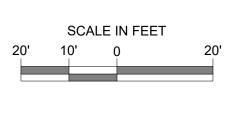


60' 30'



CONSTRUCTION SIGNAGE KEYED NOTE LEGEND:


"ONE LANE ROAD AHEAD" SIGN (MDOT W20-4) $\langle 1 \rangle$

 $\langle 2 \rangle$ "FLAGGER AHEAD" SIGN (MDOT W20-7A)

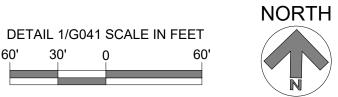

RS&H



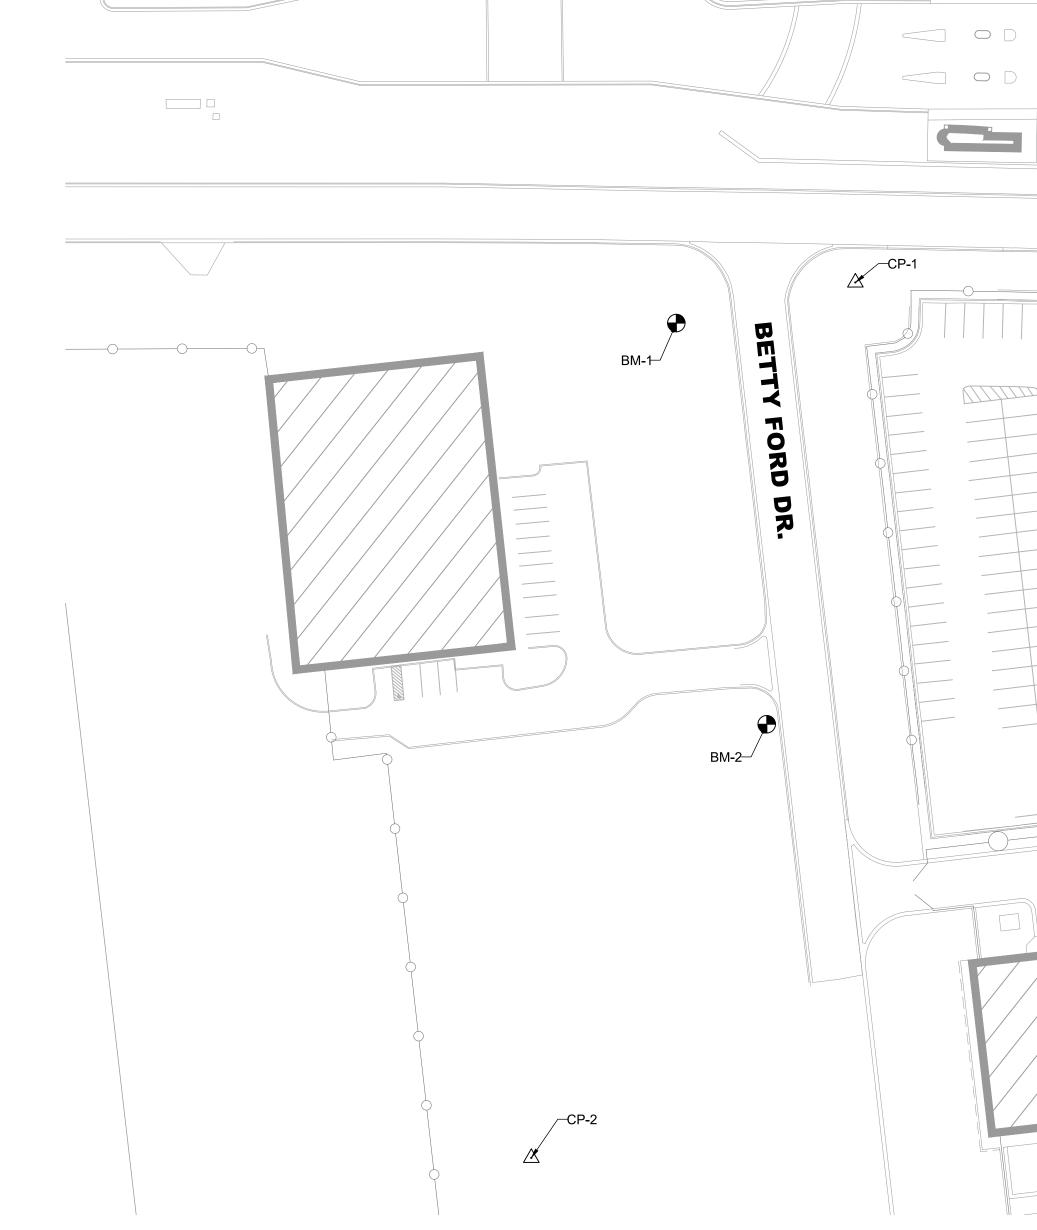


CON	CONTROL POINT INFORMATION TABLE				
POINT	NORTHING	EASTING	ELEVATION		
CP-1	506335.38	12810222.26	795.51'		
CP-2	505875.73	12810063.95	791.56'		

BENCHMARK INFORMATION TABLE			
POINT	DESCRIPTION	ELEVATION	
BM-1	"X" ON SW BOLT ON HYDRANT	795.59'	
BM-2	"X" ON NW BOLT ON HYDRANT	794.48'	
BM-3	TOP OF SILVER ANCHOR BOLT - SW CORNER OF BLUE METAL BUILDING	797.39'	

JOHN	J OOSTEMA BLVD. SE
ROSS DR. SE	
BM-3	
	EMPLOYEE

LEGEND:

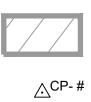

EXISTING BUILDING


CONTROL POINT LOCATION


●^{BM- #}


BENCHMARK POINT LOCATION

NOTES:


- 1. SURVEY INFORMATION PROVIDED BY HRC, INC. IN DECEMBER 2024.
- HORIZONTAL CONTROL: STATE PLANE COORDINATES, NAD83, MICHIGAN SOUTH ZONE, INTERNATIONAL FOOT (MI83-SIF).
- 3. VERTICAL DATUM FOR THIS SURVEY IS NAVD88.
- CONTRACTOR SHALL VERIFY SURVEY CONTROL PRIOR TO BEGINNING WORK AND SHALL IMMEDIATELY NOTIFY THE RPR OF ANY DISCREPANCY.

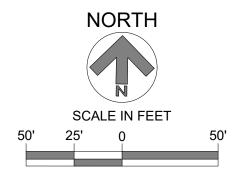

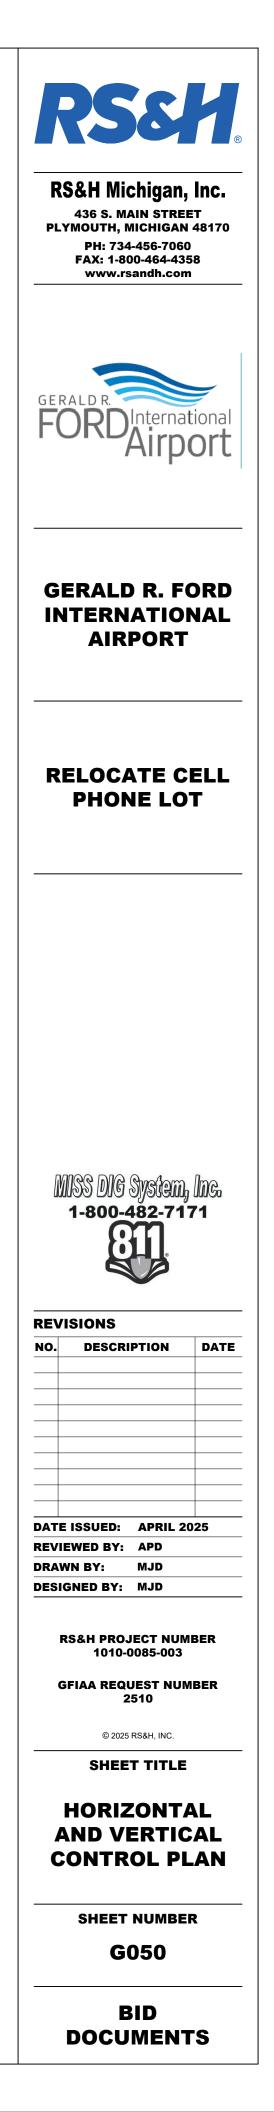

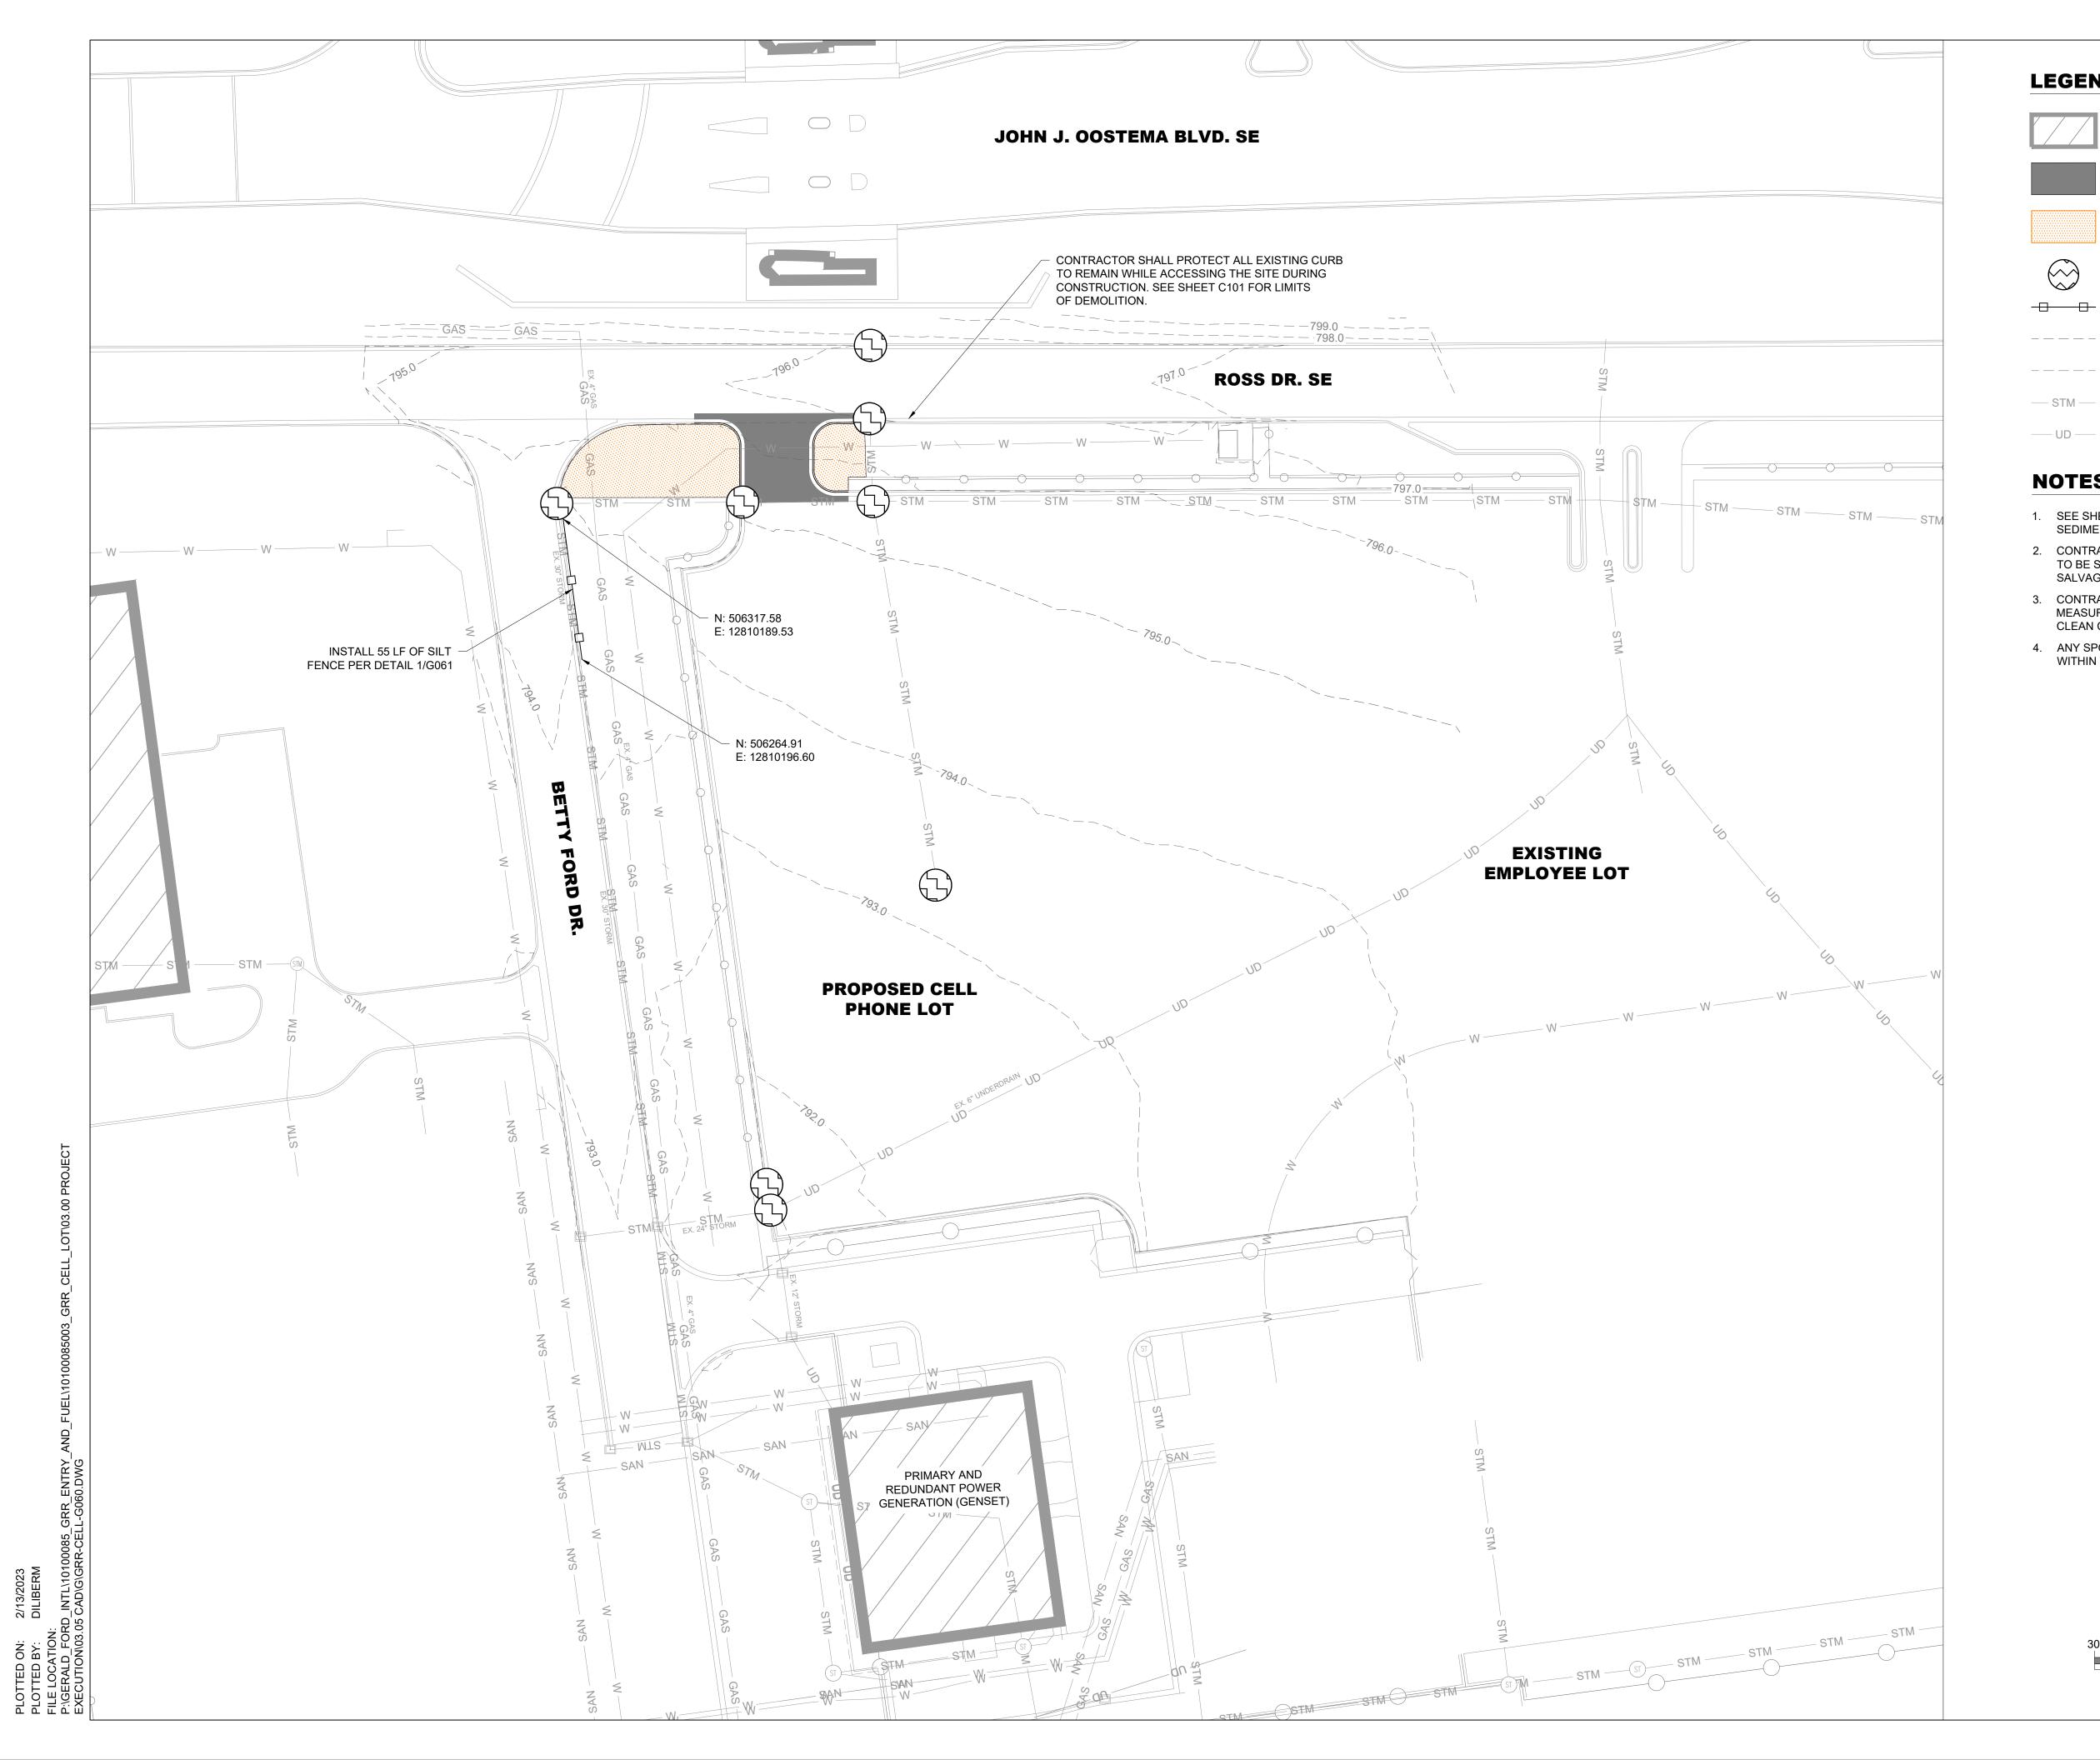

LEGEND:

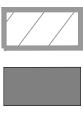

()

EXISTING BUILDING

PROPOSED CONCRETE PAVEMENT

PROPOSED TOPSOIL, HYDROSEED, AND MULCH LIMITS

PROPOSED INLET PROTECTION

PROPOSED SILT FENCE

EXISTING 5' CONTOUR _ _ _ _ _

- EXISTING 1' CONTOUR _ _ _ _ _
- STM EXISTING STORM PIPE
- EXISTING UNDERDRAIN —— UD ——

NOTES:

- 1. SEE SHEET G061 FOR SOIL EROSION AND SEDIMENTATION CONTROL NOTES AND DETAILS
- 2. CONTRACTOR SHALL PLACE 4" TOPSOIL AT ALL AREAS TO BE SEEDED AND MULCHED. TOPSOIL SHALL BE SALVAGED FROM EXISTING TOPSOIL ON SITE.
- 3. CONTRACTOR SHALL PROVIDE DUST CONTROL MEASURES DURING CONSTRUCTION AND SHALL KEEP CLEAN CONSTRUCTION ACCESS POINTS.
- 4. ANY SPOILS/STOCKPILES SHALL BE MAINTAINED WITHIN THE CONSTRUCTION OR STAGING AREA.



RS&H Michigan, Inc. 436 S. MAIN STREET PLYMOUTH, MICHIGAN 48170 PH: 734-456-7060 FAX: 1-800-464-4358 www.rsandh.com GERALDE **GERALD R. FORD** INTERNATIONAL AIRPORT **RELOCATE CELL** PHONE LOT MISS DIG System, Inc. 1-800-482-7171 REVISIONS NO. DESCRIPTION DATE DATE ISSUED: APRIL 2025 REVIEWED BY: APD DRAWN BY: MJD DESIGNED BY: MJD RS&H PROJECT NUMBER 1010-0085-003 GFIAA REQUEST NUMBER 2510 © 2025 RS&H, INC. SHEET TITLE SOIL EROSION AND SEDIMENTATION **CONTROL PLAN** SHEET NUMBER

G060

BID DOCUMENTS

	SCA	LE IN FEET	-
30'	15'	0	30'



1.	THE CONTRACTOR SHALL PROVIDE AND INSTALL SOIL EROSION AND SEDIMENTATION CONTROL (SESC) DEVICES, AS SHOWN, BEFORE PROCEEDING WITH ANY OTHER SITE WORK. CONTRACTOR SHALL MAINTAIN ALL SESC DEVICES FOR THE DURATION OF THE CONSTRUCTION. AT THE END OF CONSTRUCTION, THE CONTRACTOR SHALL RESTORE ALL DISTURBED AREAS. ONCE GRASS IS ESTABLISHED, CONTRACTOR SHALL REMOVE AND DISPOSE OF ALL TEMPORARY SESC DEVICES AND COLLECTED DEBRIS. ALL PERMITS SHALL BE INCIDENTAL TO ITEM 110 MOBILIZATION. MAINTENANCE OF SOIL EROSION MEASURES SHALL BE INCIDENTAL TO THE INDIVIDUAL ITEMS.
2.	THE CONTRACTOR SHALL INSPECT AND MAINTAIN SESC DEVICES ON A WEEKLY BASIS AND WITHIN 24 HOURS AFTER A STORM EVENT. THE CONTRACTOR SHALL REMOVE ACCUMULATED DEBRIS AND MAKE NECESSARY REPAIRS.
3.	THE CONTRACTOR SHALL MAINTAIN DRAINAGE OF THE SITE FOR THE DURATION OF THE CONSTRUCTION. DRAINAGE STRUCTURES SHALL BE CLEANED OF COLLECTED DEBRIS AT THE END OF CONSTRUCTION AND THE AREA RESTORED.
4.	ALL EXCESS EXCAVATED MATERIALS SHALL REMAIN ONSITE AT A LOCATION DESIGNATED BY GFIAA. THE OWNER SHALL BE INFORMED OF ANY EXCESS MATERIAL PRIOR TO DISPOSING, IF NEEDED.
5.	THE CONTRACTOR MUST CONTROL THE DUST ON THE SITE DURING THE LIFE OF THE CONTRACT AS REQUIRED IN THE CONSTRUCTION SAFETY AND PHASING PLAN.
6.	THE CONTRACTOR SHALL ACCESS THE SITE ONLY FROM GATES INDICATED ON THE CONSTRUCTION SAFETY AND PHASING PLAN. THE CONTRACTOR SHALL CONSTRUCT AND MAINTAIN A TEMPORARY GRAVEL ACCESS PER MICHIGAN SESC STANDARDS AT LOCATIONS WHERE THE CONTRACTOR'S ACCESS FROM THE SITE JOINS EXISTING PAVEMENT.
7.	ALL DISTURBED GROUND AREAS SHALL BE RESTORED WITH A MINIMUM OF 4 INCHES OF TOPSOIL, SEED AND/OR SOD.
8.	DURING CONSTRUCTION, ALL STORM DRAIN INLETS SHALL BE PROTECTED AS SHOWN ON THIS SHEET, MAINTAINED AND MODIFIED AS REQUIRED. ALL CONSTRUCTION DISCHARGE WATER SHALL BE ADEQUATELY FILTERED TO REMOVE SILT PRIOR TO DISCHARGE INTO WATERWAYS AND WETLANDS. PAYMENT FOR INLET PROTECTION SHALL BE MADE UNDER ITEM 208-2 EROSION CONTROL, INLET PROTECTION, FABRIC DROP.
	WOVEN WIRE FENCE (14-1/2 GA. MIN., WITH MAX 6" MESH SPACING) WITH FILTER CLOTH COVER
	36" MIN. WOOD FENCE POST —

FLOW -----Sembed Filter 🚽 CLOTH MIN. 6"

SECTION VIEW

INTO GROUND



SILT FENCE NOTES:

- SILT FENCE SHALL BE IN PLACE PRIOR TO GRADING. SILT FENCE AND FILTER FABRIC MUST BE ENTRENCHED.
- 2. ANY SEDIMENT DEPOSITS REMAINING IN PLACE AFTER THE SILT FENCE OR FILTER BARRIER IS NO LONGER REQUIRED SHALL BE DRESSED TO CONFORM WITH THE PROPOSED AND EXISTING GRADES, PREPARED AND SEEDED OR SODDED.
- 3. SILT FENCE SHALL BE REMOVED UPON COMPLETION OF THE PROJECT OR AT A TIME DIRECTED BY THE OWNER. IF THE OWNER FEELS IT IS NECESSARY FOR THE SILT FENCE TO REMAIN IN PLACE FOR SOME GIVEN TIME AFTER CONSTRUCTION IS COMPLETE, THE CONTRACTOR SHALL LEAVE IT IN PLACE, IN THE PROPLERLY INSTALLED WAY, AND WILL, AT THE DIRECTION OF THE OWNER, REMOVE IT AT NO ADDITIONAL COST TO THE OWNER WHEN THE OWNER DEEMS IT APPROPRIATE.

SEEDING NOTES:

- 1. ALL SEED SHALL BE APPLIED USING THE SEEDING METHOD AS DESCRIBED IN SECTION 816 OF MDOT STATE HIGHWAY SPECIFICATIONS, LATEST EDITION.
- 2. ANY DISTURBED AREA WHICH WILL NOT BE PAVED, SODDED OR BUILT UPON SHALL HAVE THE MINIMUM VEGETATIVE COVER, AND IN THE OPINION OF THE OWNER AND ENGINEER WILL BE MATURE ENOUGH TO CONTROL SOIL EROSION AND SURVIVE SEVERE WEATHER CONDITIONS. IF SEEDING OCCURS OUTSIDE OF THE SEASONAL LIMITATIONS INDICATED IN SECTION 816 OF THE SPECIFICATIONS, THE CONTRACTOR SHALL MAINTAIN THE NEWLY SEEDED AREAS, INCLUDING WATERING, AT NO ADDITIONAL COST TO THE OWNER.


CATCH BASIN INLET PROTECTION NOTES:

- 1. PRIOR TO ORDERING FOR CORRECT SIZING.
- 2. MANUFACTURER RECOMMENDATIONS.
- 3. CONSTRUCTION SITE.
- 4 UNDER WAY.

5.

9.

- 6. DRAINAGE MANHOLE.
- 7 APPROXIMATELY 50 PERCENT OR DIRECTED BY THE ENGINEER.
- 8

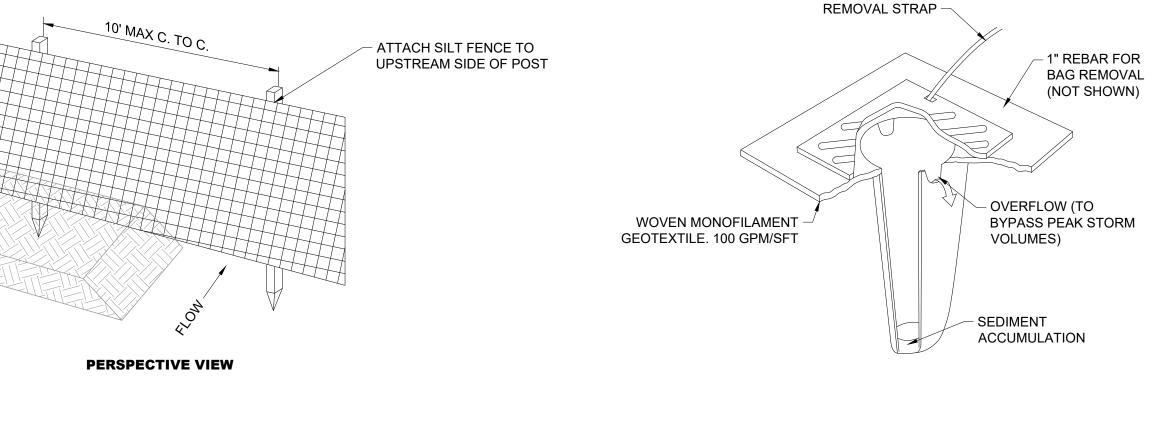



CATCH BASIN INSERT SHALL BE ULTRA-DRAIN GUARD®. REUSABLE MODEL OR APPROVED EQUAL. CONTRACTOR SHALL VERIFY DIMENSIONS OF STRUCTURES WITH MANUFACTURER

THE CATCH BASIN INSERT SHALL BE INSTALLED, MAINTAINED AND REMOVED PER

THE LOCATIONS SHOWN ON THE PLAN FOR PLACEMENT OF THIS DEVICE MAY VARY FROM WHERE THEY ARE ACTUALLY INSTALLED. THE DEVICES MUST BE PLACED IN CATCH BASINS DURING ALL CONSTRUCTION ACTIVITY THAT MAY CAUSE SILTATION DOWNSTREAM OF THE

THE CATCH BASIN INSERT INLET FILTER SHALL EITHER BE PLACED AT THE SAME TIME AS THE INLET FILTER FOR TURF OR DURING THE CONCRETE MAINTENANCE PAD CONSTRUCTION. INLET PROTECTION SHALL REMAIN IN PLACE UNTIL EITHER THE AREA IS STABILIZED OR CONSTRUCTION (CUT/CAP OR REMOVAL) OF THE DRAINAGE STRUCTURE IS

ALL STORM WATER THAT NEEDS TO BE PUMPED FROM THE SITE SHALL BE PUMPED INTO ONE OF THESE DEVICES. THE FLOW RATE PUMPED INTO THIS DEVICE SHALL NOT EXCEED THE MANUFACTURER'S RECOMMENDED TREATMENT FLOW RATE. DURING THE PUMPING PROCESS, THE DEVICE SHALL BE MONITORED IN ORDER TO DETERMINE THAT IT IS TREATING THE WATER. IF THE WATER IS UTILIZING THE BYPASS PORT AND IS NOT BEING CLEANED BY THE DEVICE, THE PUMPING SHALL BE STOPPED AND THE DEVICE SHALL BE CLEANED PER MANUFACTURER'S RECOMMENDATIONS AND THEN REINSTALLED.

ULTRA-DRAIN GUARD RETAINERS® OR APPROVED EQUAL MAY BE REQUIRED TO HOLD THE ULTRA-DRAIN GUARD®, REUSABLE MODEL OR APPROVED EQUAL IN-PLACE IF THE GRATING CANNOT BE INSTALLED, NEEDS TO BE REMOVED, OR THE INSERT IS INSTALLED ON A

MAINTENANCE SHALL BE PROVIDED BY THE CONTRACTOR WHEN THE CAPACITY IS REDUCED BY

THE MEASUREMENT OF THE CATCH BASIN INSERT INLET PROTECTION FOR INSTANCES OF A PROPOSED / MODIFIED STRUCTURE BEING INSTALLED IN THE SAME LOCATION AS AN EXISTING ONE SHALL BE CONSIDERED AS ONE DEVICE AND ANY ADDITIONAL COSTS SHALL BE CONSIDERED INCIDENTAL.

INLET PROTECTION DEVICES SHALL BE PAID FOR UNDER THE UNIT COST PER EACH FOR CATCH BASIN INLET PROTECTION. THIS COST SHALL INCLUDE ALL THE COSTS FOR INSTALLATION, MAINTENANCE, AND REMOVAL, AND ALL LABOR, EQUIPMENT AND TOOLS AND INCIDENTALS TO INSTALL PER THE MANUFACTURER'S RECOMMENDATIONS.





GERALD R. FORD INTERNATIONAL AIRPORT

RELOCATE CELL PHONE LOT

MISS DIG System, Inc. 1-800-482-7171



REV	SIONS		
NO.	DESCRI	PTION	DATE
DATE	ISSUED:	APRIL 2	2025
REVIE	EWED BY:	APD	

REVIEWED BY:	APD	
DRAWN BY:	MJD	
DESIGNED BY:	MJD	

RS&H PROJECT NUMBER 1010-0085-003

GFIAA REQUEST NUMBER 2510

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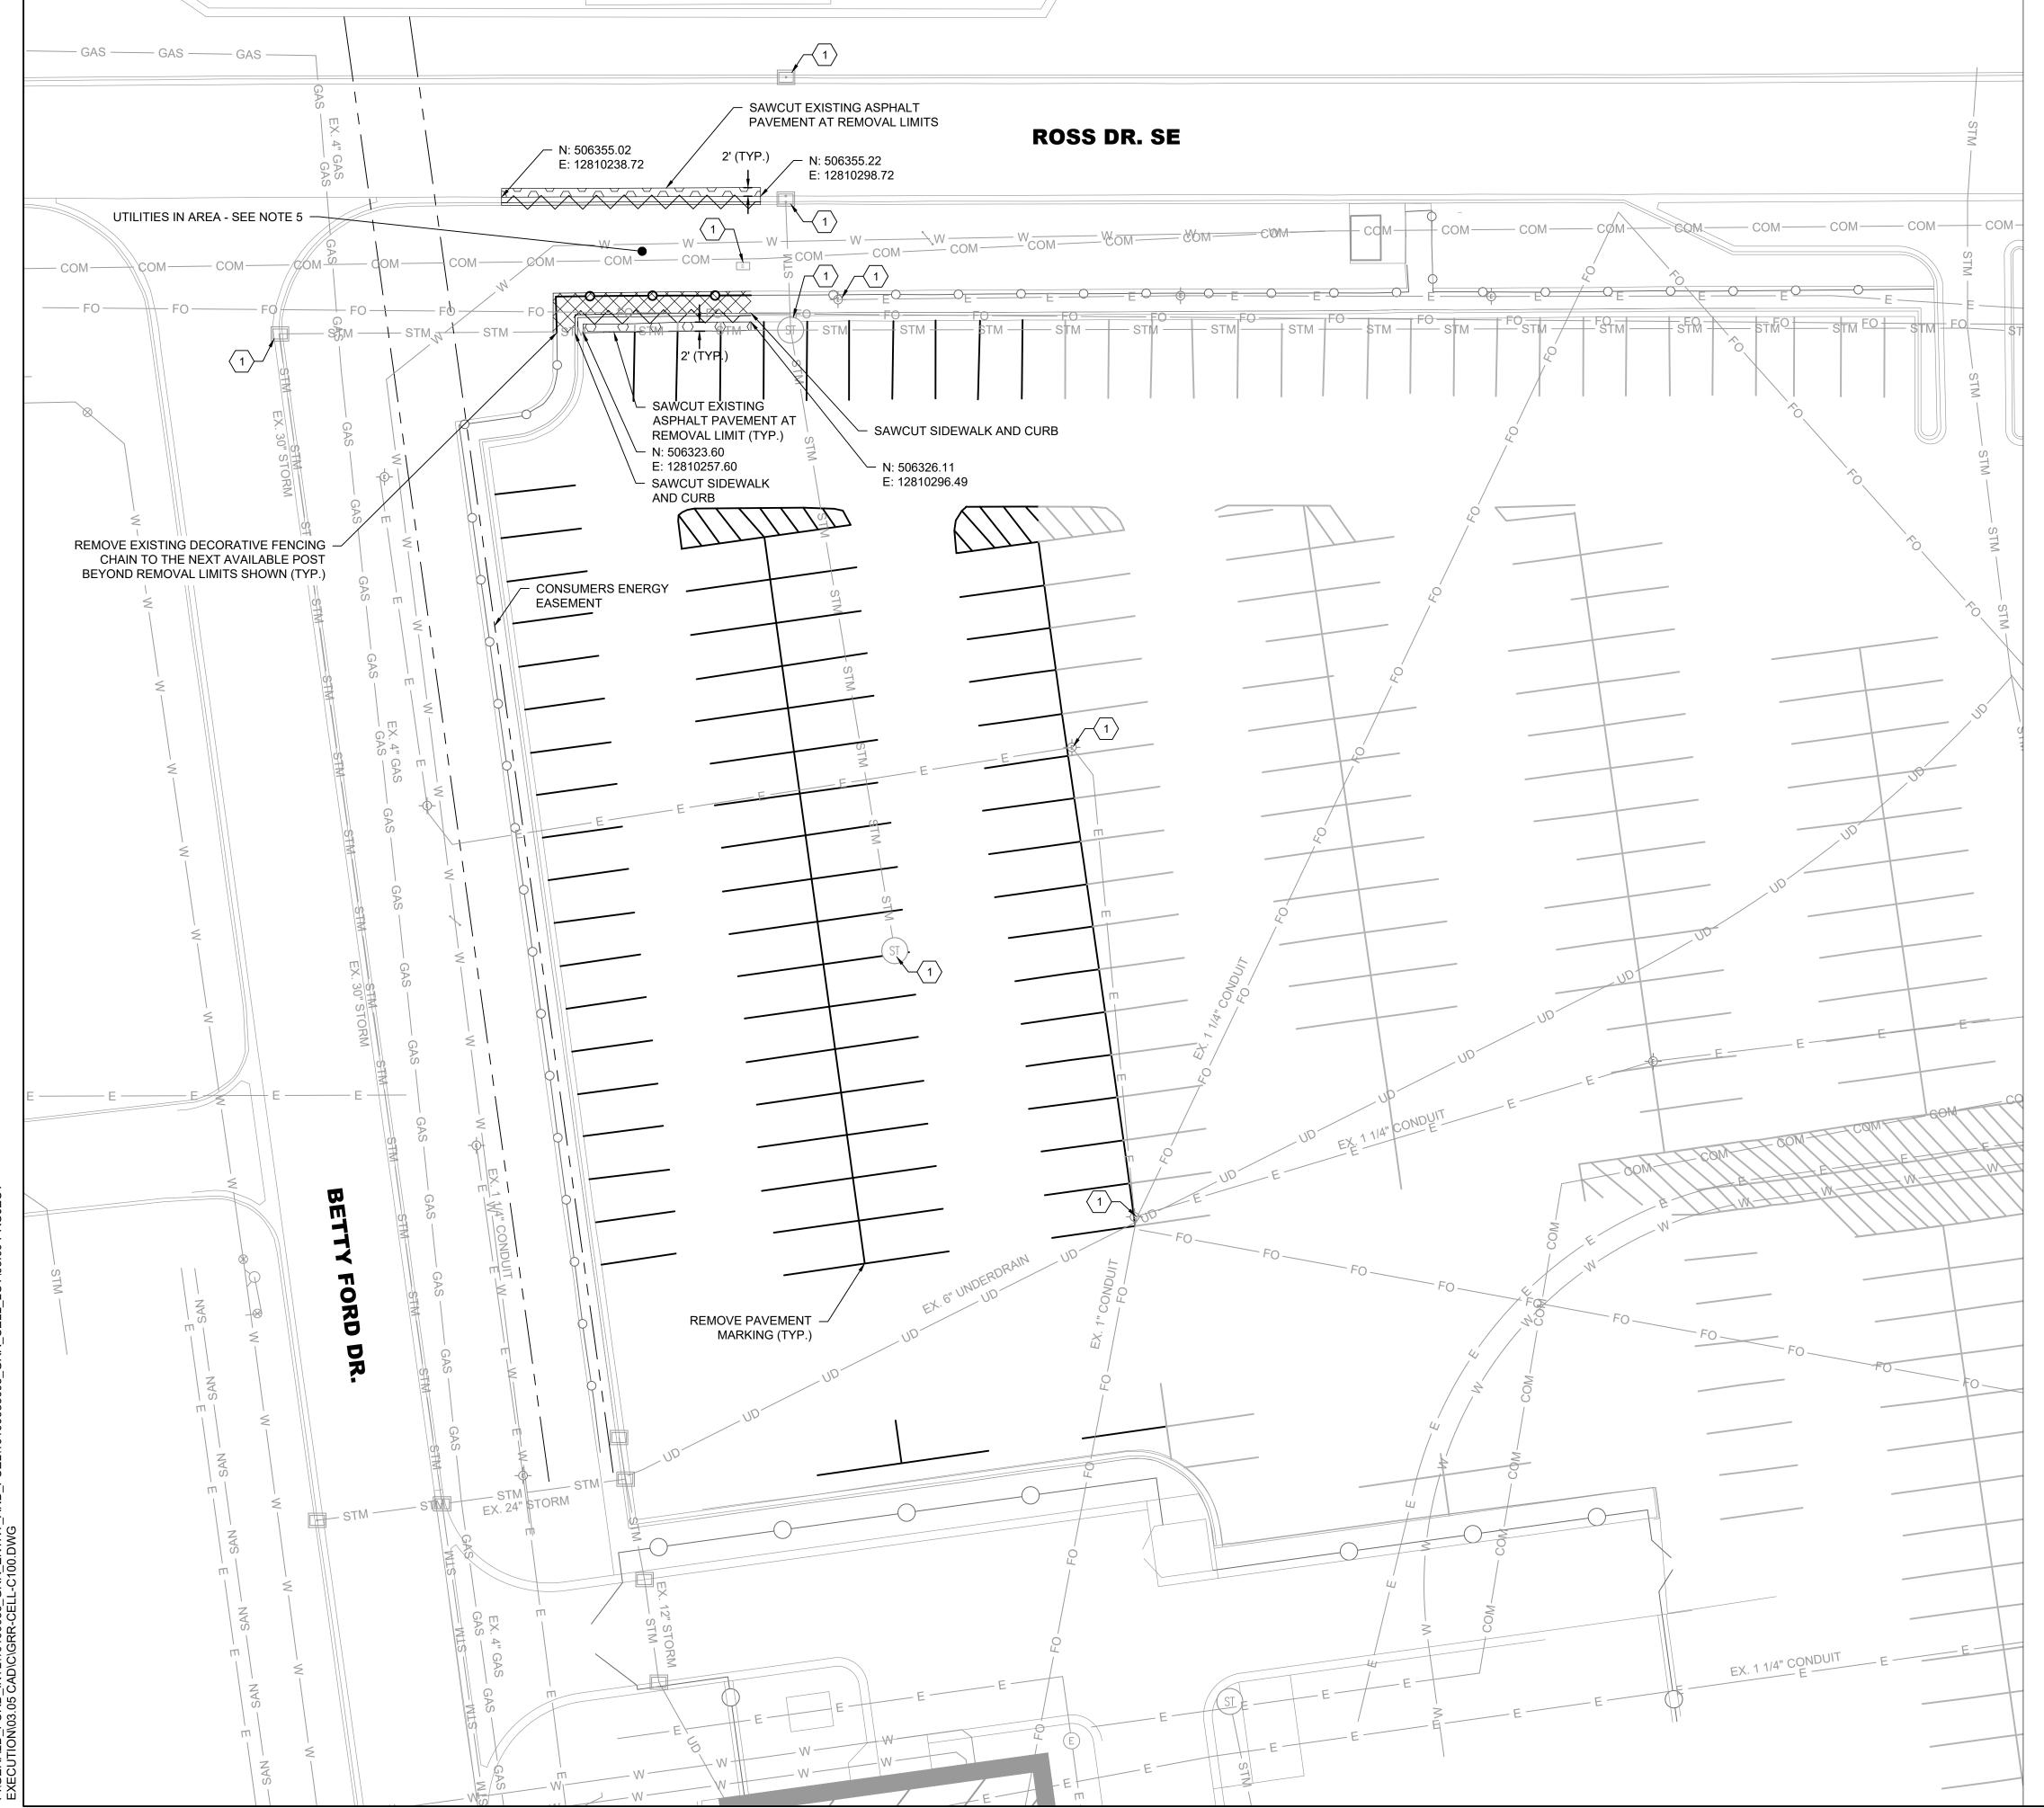
SHEET TITLE

SOIL EROSION AND SEDIMENTATION **CONTROL NOTES** AND DETAILS

SHEET NUMBER

G061

BID DOCUMENTS



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REMOVE ASPHALT PAVEMENT

REMOVE CONCRETE SIDEWALK

REMOVE CONCRETE CURB & GUTTER EXISTING SANITARY SEWER EXISTING STORM SEWER EXISTING UNDERDRAIN PIPE EXISTING GAS UTILITY EXISTING WATER UTILITY EXISTING ELECTRICAL UTILITY EXISTING FIBER OPTIC UTILITY EXISTING STORM INLET EXISTING STORM MANHOLE EXISTING OVERHEAD LIGHT POLE EXISTING ELECTRICAL STRUCTURE EXISTING FENCE LINE

REMOVE FENCE LINE EXISTING PAVEMENT MARKING

REMOVE PAVEMENT MARKING

KEYNOTE

 $\langle 1 \rangle$


PROTECT EXISTING STRUCTURE

NOTES

- 1. LIMITS OF DEMOLITION SHALL BE VERIFIED IN THE FIELD BY THE CONTRACTOR AND RPR PRIOR TO BEGINNING CONSTRUCTION. ANY DAMAGE TO EXISTING PAVEMENT TO REMAIN SHALL BE REPLACED BY THE CONTRACTOR AT NO ADDITIONAL COST TO THE OWNER.
- 2. ALL PAVEMENT MARKING REMOVALS SHALL BE DONE AT A LOW WATER PRESSURE TO PRESERVE THE EXISTING PAVEMENT. ANY DAMAGE TO EXISTING PAVEMENT MARKINGS MUST BE FIXED AT THE CONTRACTORS EXPENSE
- 3. CONTRACTOR SHALL PROTECT IN PLACE ALL UTILITIES UNLESS INDICATED OTHERWISE.
- 4. CURB AND GUTTER "EDGE OF METAL" IS USED AS A REFERENCE POINT FOR ALL REMOVAL LOCATIONS PROVIDED.
- 5. FOR UTILITIES CONFLICTING WITH THE INSTALLATION OF PROPOSED WORK ITEMS, THE CONTRACTOR WILL BE RESPONSIBLE FOR RELOCATING, MODIFYING, OR REMOVING SUCH UTILITIES AT THE DIRECTION OF THE ENGINEER AND/OR GFIAA. UTILITIES MODIFIED, RELOCATED, OR REMOVED WILL BE PAID FOR AS A PROJECT ALLOWANCE PER SP-02.

WARNING!

THERE ARE EXISTING UNDERGROUND UTILITIES IN THE PROJECT WORK AREAS. THE ENGINEER HAS MADE EVERY EFFORT TO SHOW THEIR APPROXIMATE LOCATIONS. IT SHALL BE THE RESPONSIBILITY OF THE CONTRACTOR TO HAVE EVERY CABLE, CONDUIT, AND PIPE LOCATED, FLAGGED, AND IDENTIFIED PRIOR TO CONSTRUCTION. ANY DAMAGE DONE TO FLAGGED OR OTHERWISE LOCATED UTILITIES SHALL BE REPLACED AT THE CONTRACTOR'S EXPENSE.

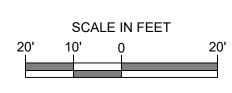





RS&H Michigan, Inc. 436 S. MAIN STREET PLYMOUTH, MICHIGAN 48170 PH: 734-456-7060 FAX: 1-800-464-4358 www.rsandh.com



GERALD R. FORD INTERNATIONAL AIRPORT

RELOCATE CELL PHONE LOT

MISS DIG System, Inc. 1-800-482-7171 2

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О.	DESCRIPTION	DATE

DATE ISSUED:	APRIL 2025
REVIEWED BY:	APD
DRAWN BY:	MJD
DESIGNED BY:	MJD

RS&H PROJECT NUMBER 1010-0085-003

GFIAA REQUEST NUMBER

2510

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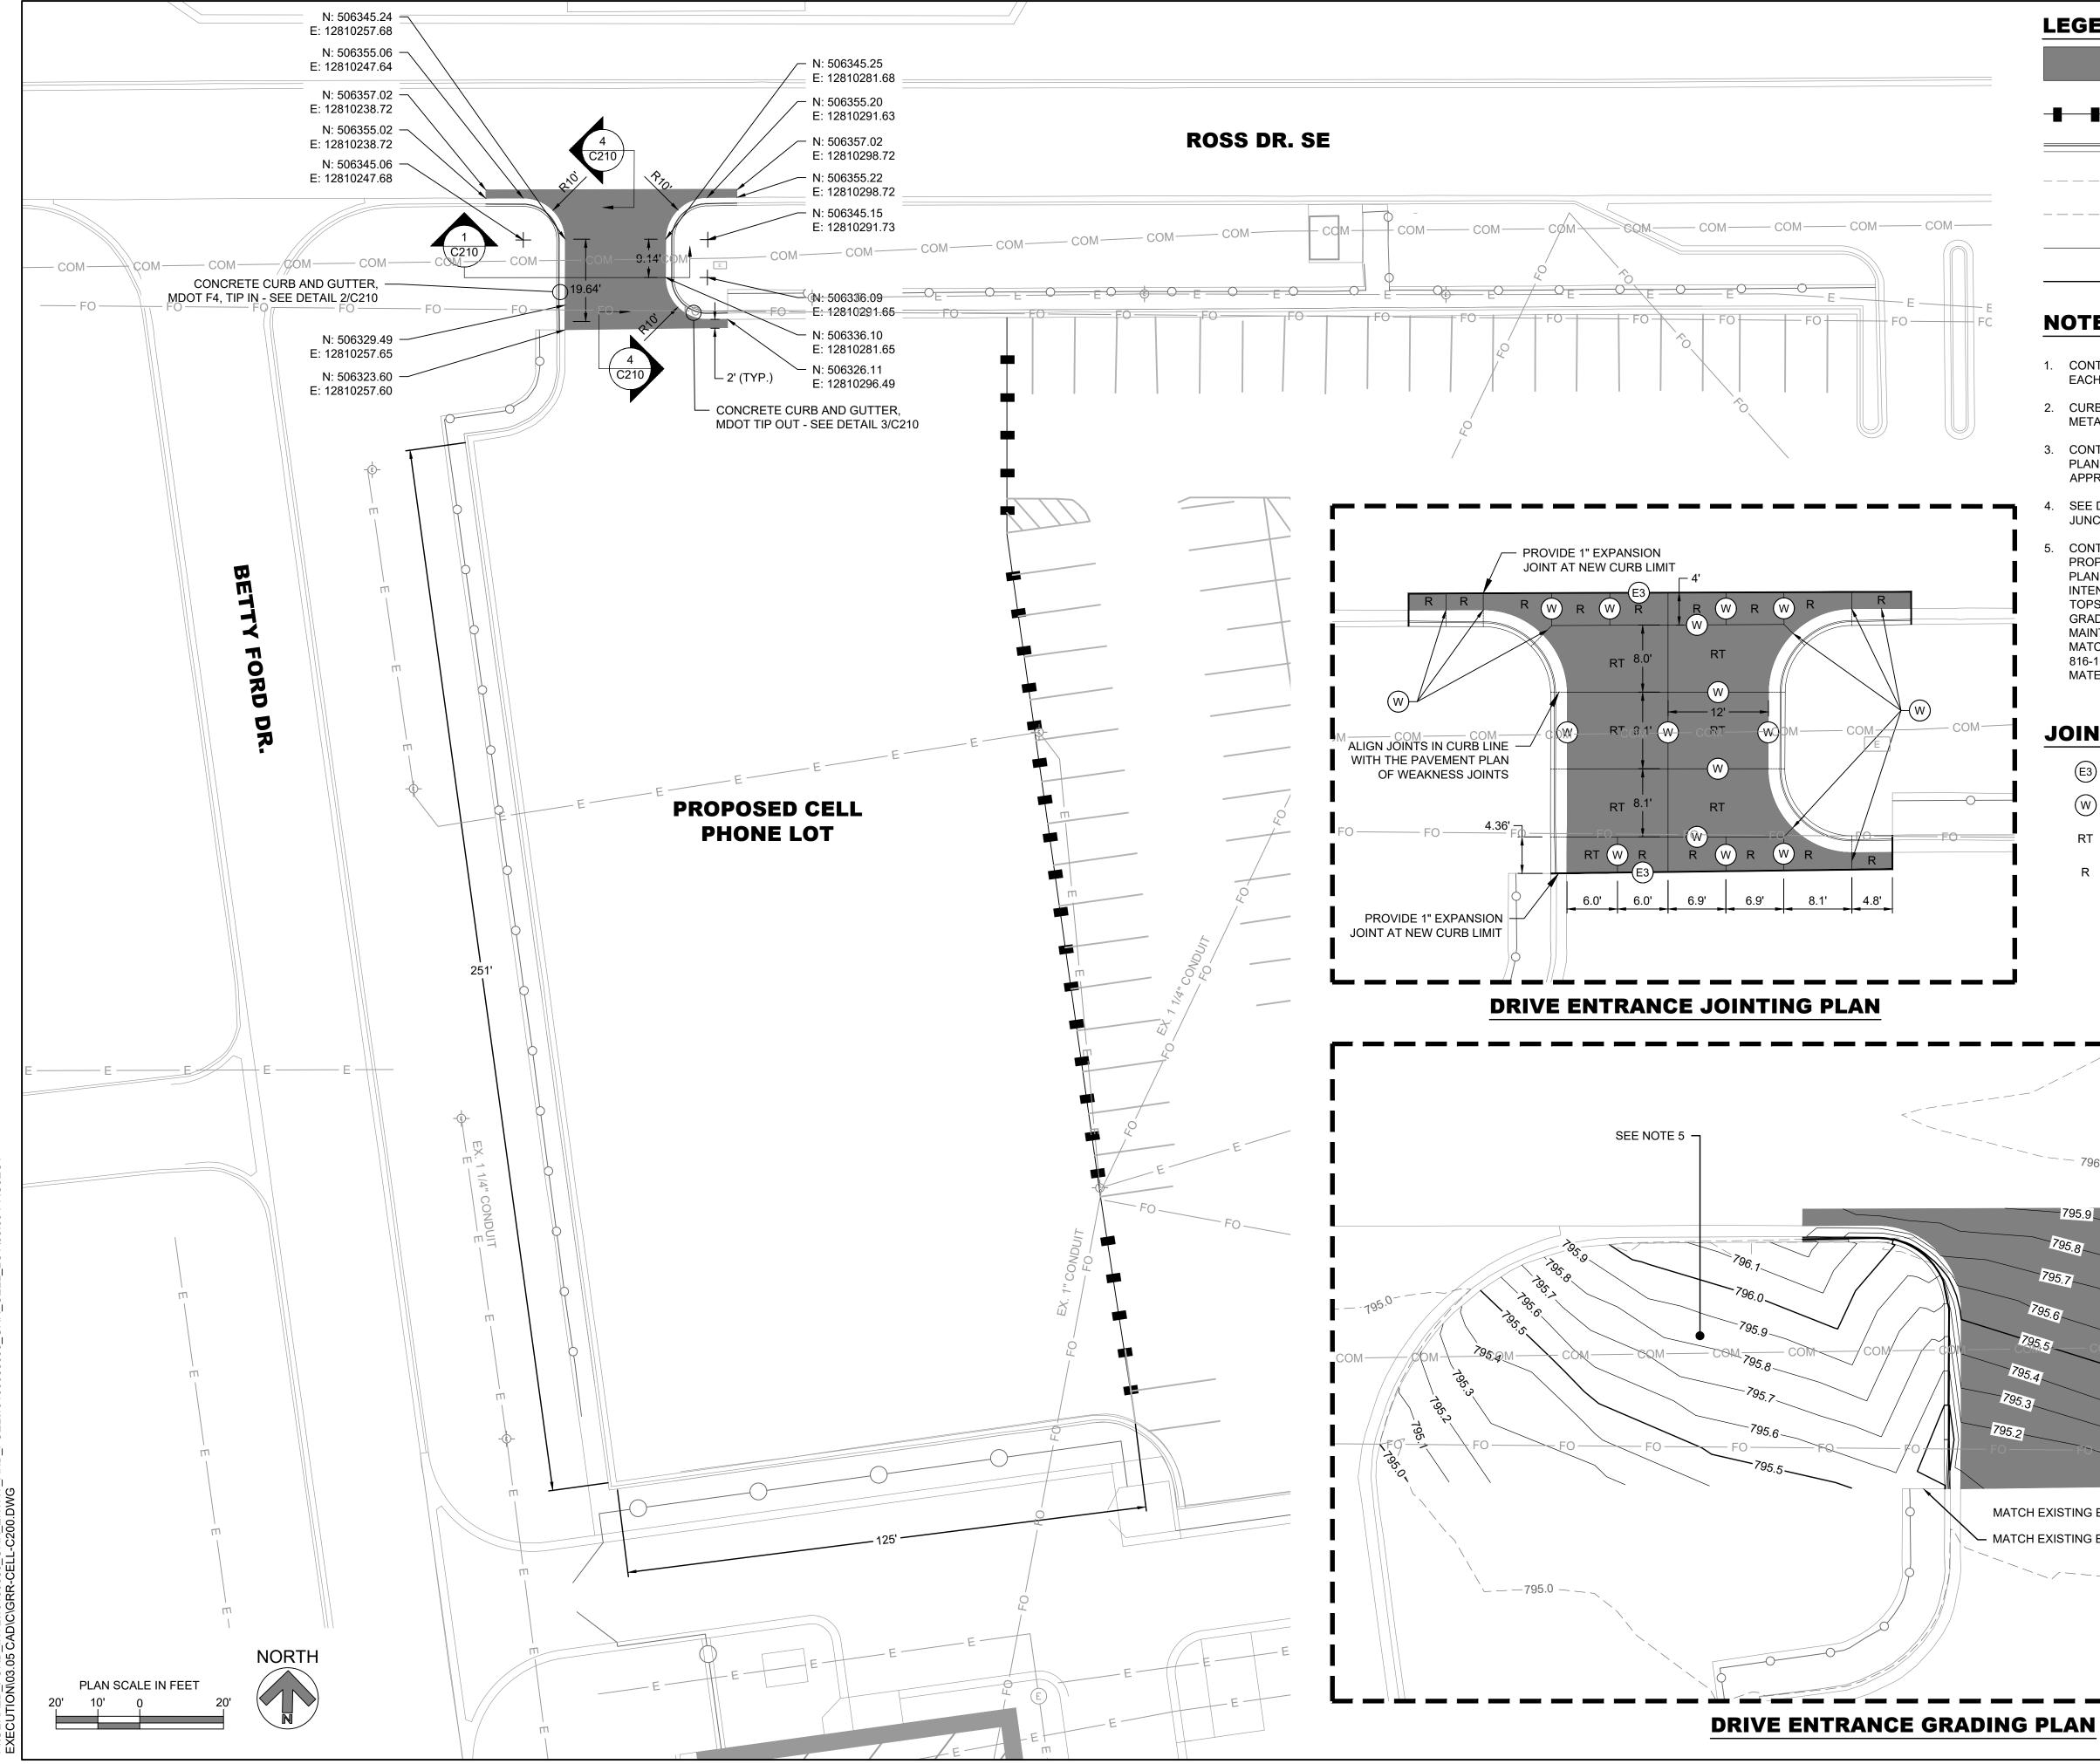
SHEET TITLE

DEMOLITION PLAN

SHEET NUMBER

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BID DOCUMENTS



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LEGEND	
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PROPOSED CONCRETE PAVEMENT

REFLECTIVE TRAFFIC DRUMS - BY OWNER PROPOSED CURB AND GUTTER EXISTING MINOR CONTOUR (0.5') EXISTING MAJOR CONTOUR (1.0') PROPOSED MINOR CONTOUR (0.1')

PROPOSED MAJOR CONTOUR (0.5')

NOTES


- 1. CONTRACTOR SHALL PROVIDE RPR A TOPOGRAPHICAL SURVEY OF EACH LAYER OF PAVING FOR VERIFICATION OF FINAL GRADES.
- 2. CURB AND GUTTER COORDINATES ARE SHOWN TO THE "EDGE OF METAL"
- 3. CONTRACTOR MAY SUBMIT AN ALTERNATE JOINT LAYOUT FOR PLANE OF WEAKNESS JOINTS FOR ENGINEER REVIEW AND APPROVAL.
- SEE DRAWING C210 FOR TYPICAL PAVEMENT SECTIONS AND JUNCTURE DETAILS.
- CONTRACTOR SHALL USE EXCAVATED MATERIAL TO CONSTRUCT PROPOSED OFF-PAVEMENT GRADES SHOWN ON THE GRADING PLAN. OFF PAVEMENT GRADES PROVIDED ARE SHOWN TO CLARIFY INTENDED DRAINAGE PATTERNS. CONTRACTOR MAY PLACE TOPSOIL WITHIN REASONABLY CLOSE CONFORMITY TO THE GRADING PLAN PROVIDED PROPOSED DRAINAGE PATTERNS ARE MAINTAINED. THE COST OF PLACING EXCAVATED MATERIAL TO MATCH PROPOSED OFF PAVEMENT GRADES SHALL BE INCLUDED IN 816-1. NO ADDITIONAL PAYMENT WILL BE MADE FOR SPOILING MATERIAL IN EXCESS OF 4" DEEP.


JOINT LAYOUT LEGEND

- E3) MDOT "E3" ISOLATION JOINT
- (W)MDOT "W" PLANE OF WEAKNESS JOINT
- REINFORCED CONCRETE PANEL (WITH CURB TIES) RT
- REINFORCED CONCRETE PANEL (WITHOUT CURB TIES)


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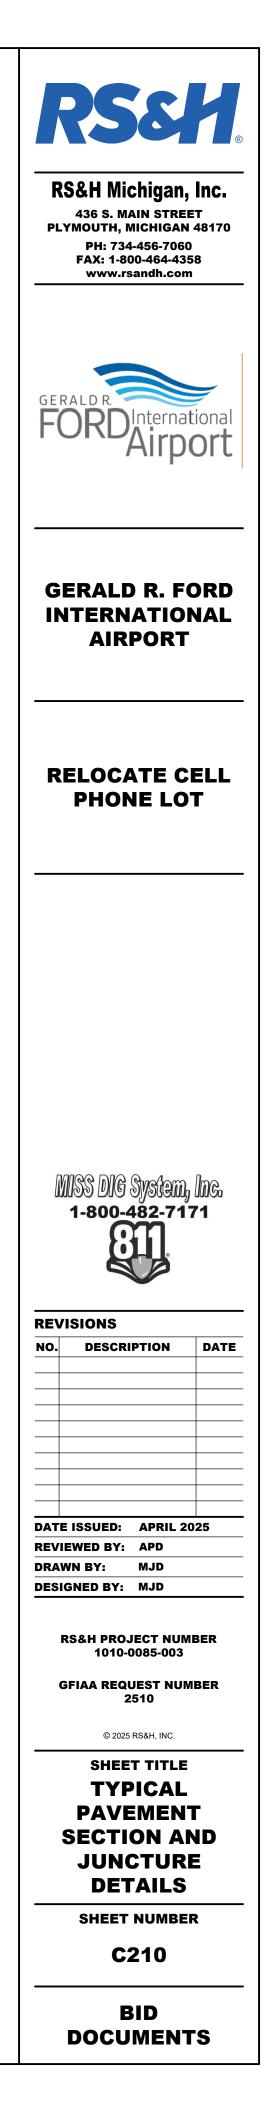



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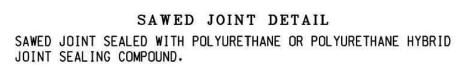


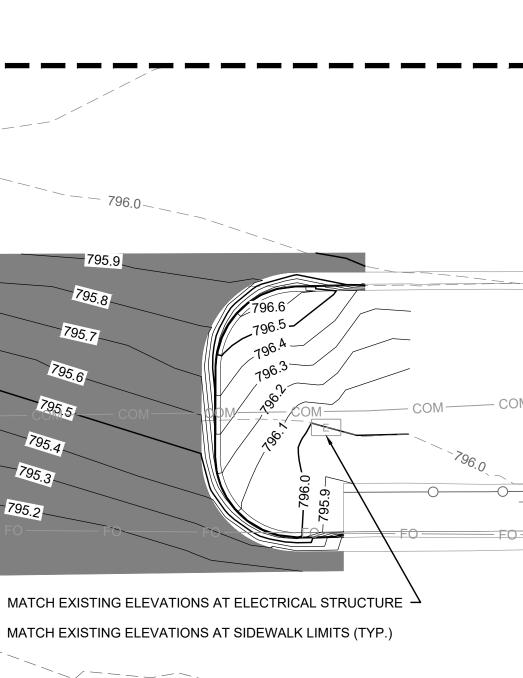
2/13/2023 DILIBERM

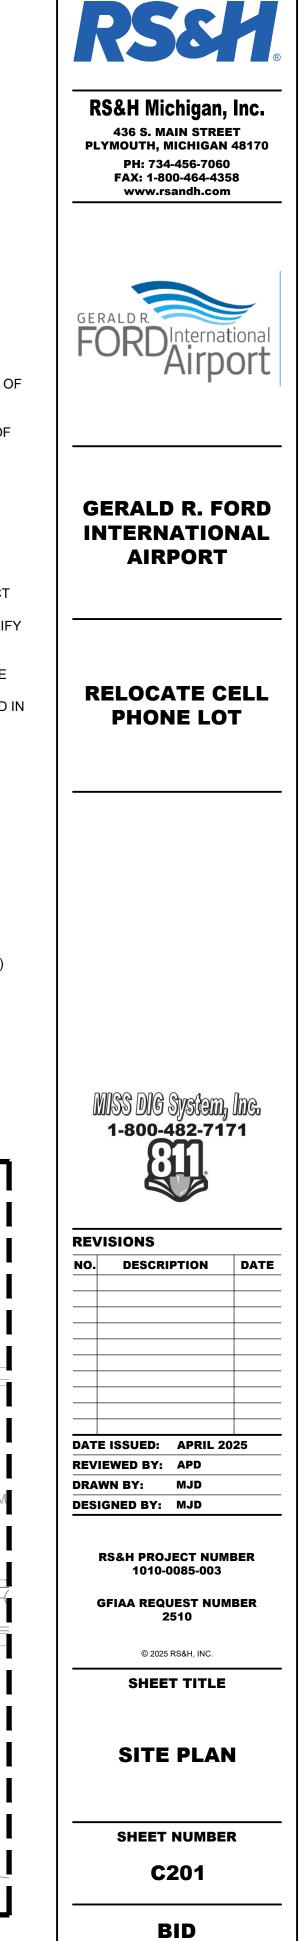1ENT	TWO WAY W	/IRE FABRIC
ESS, T	SIZE	SPACING
СН	W2.9 X W2.9	6" x 6"



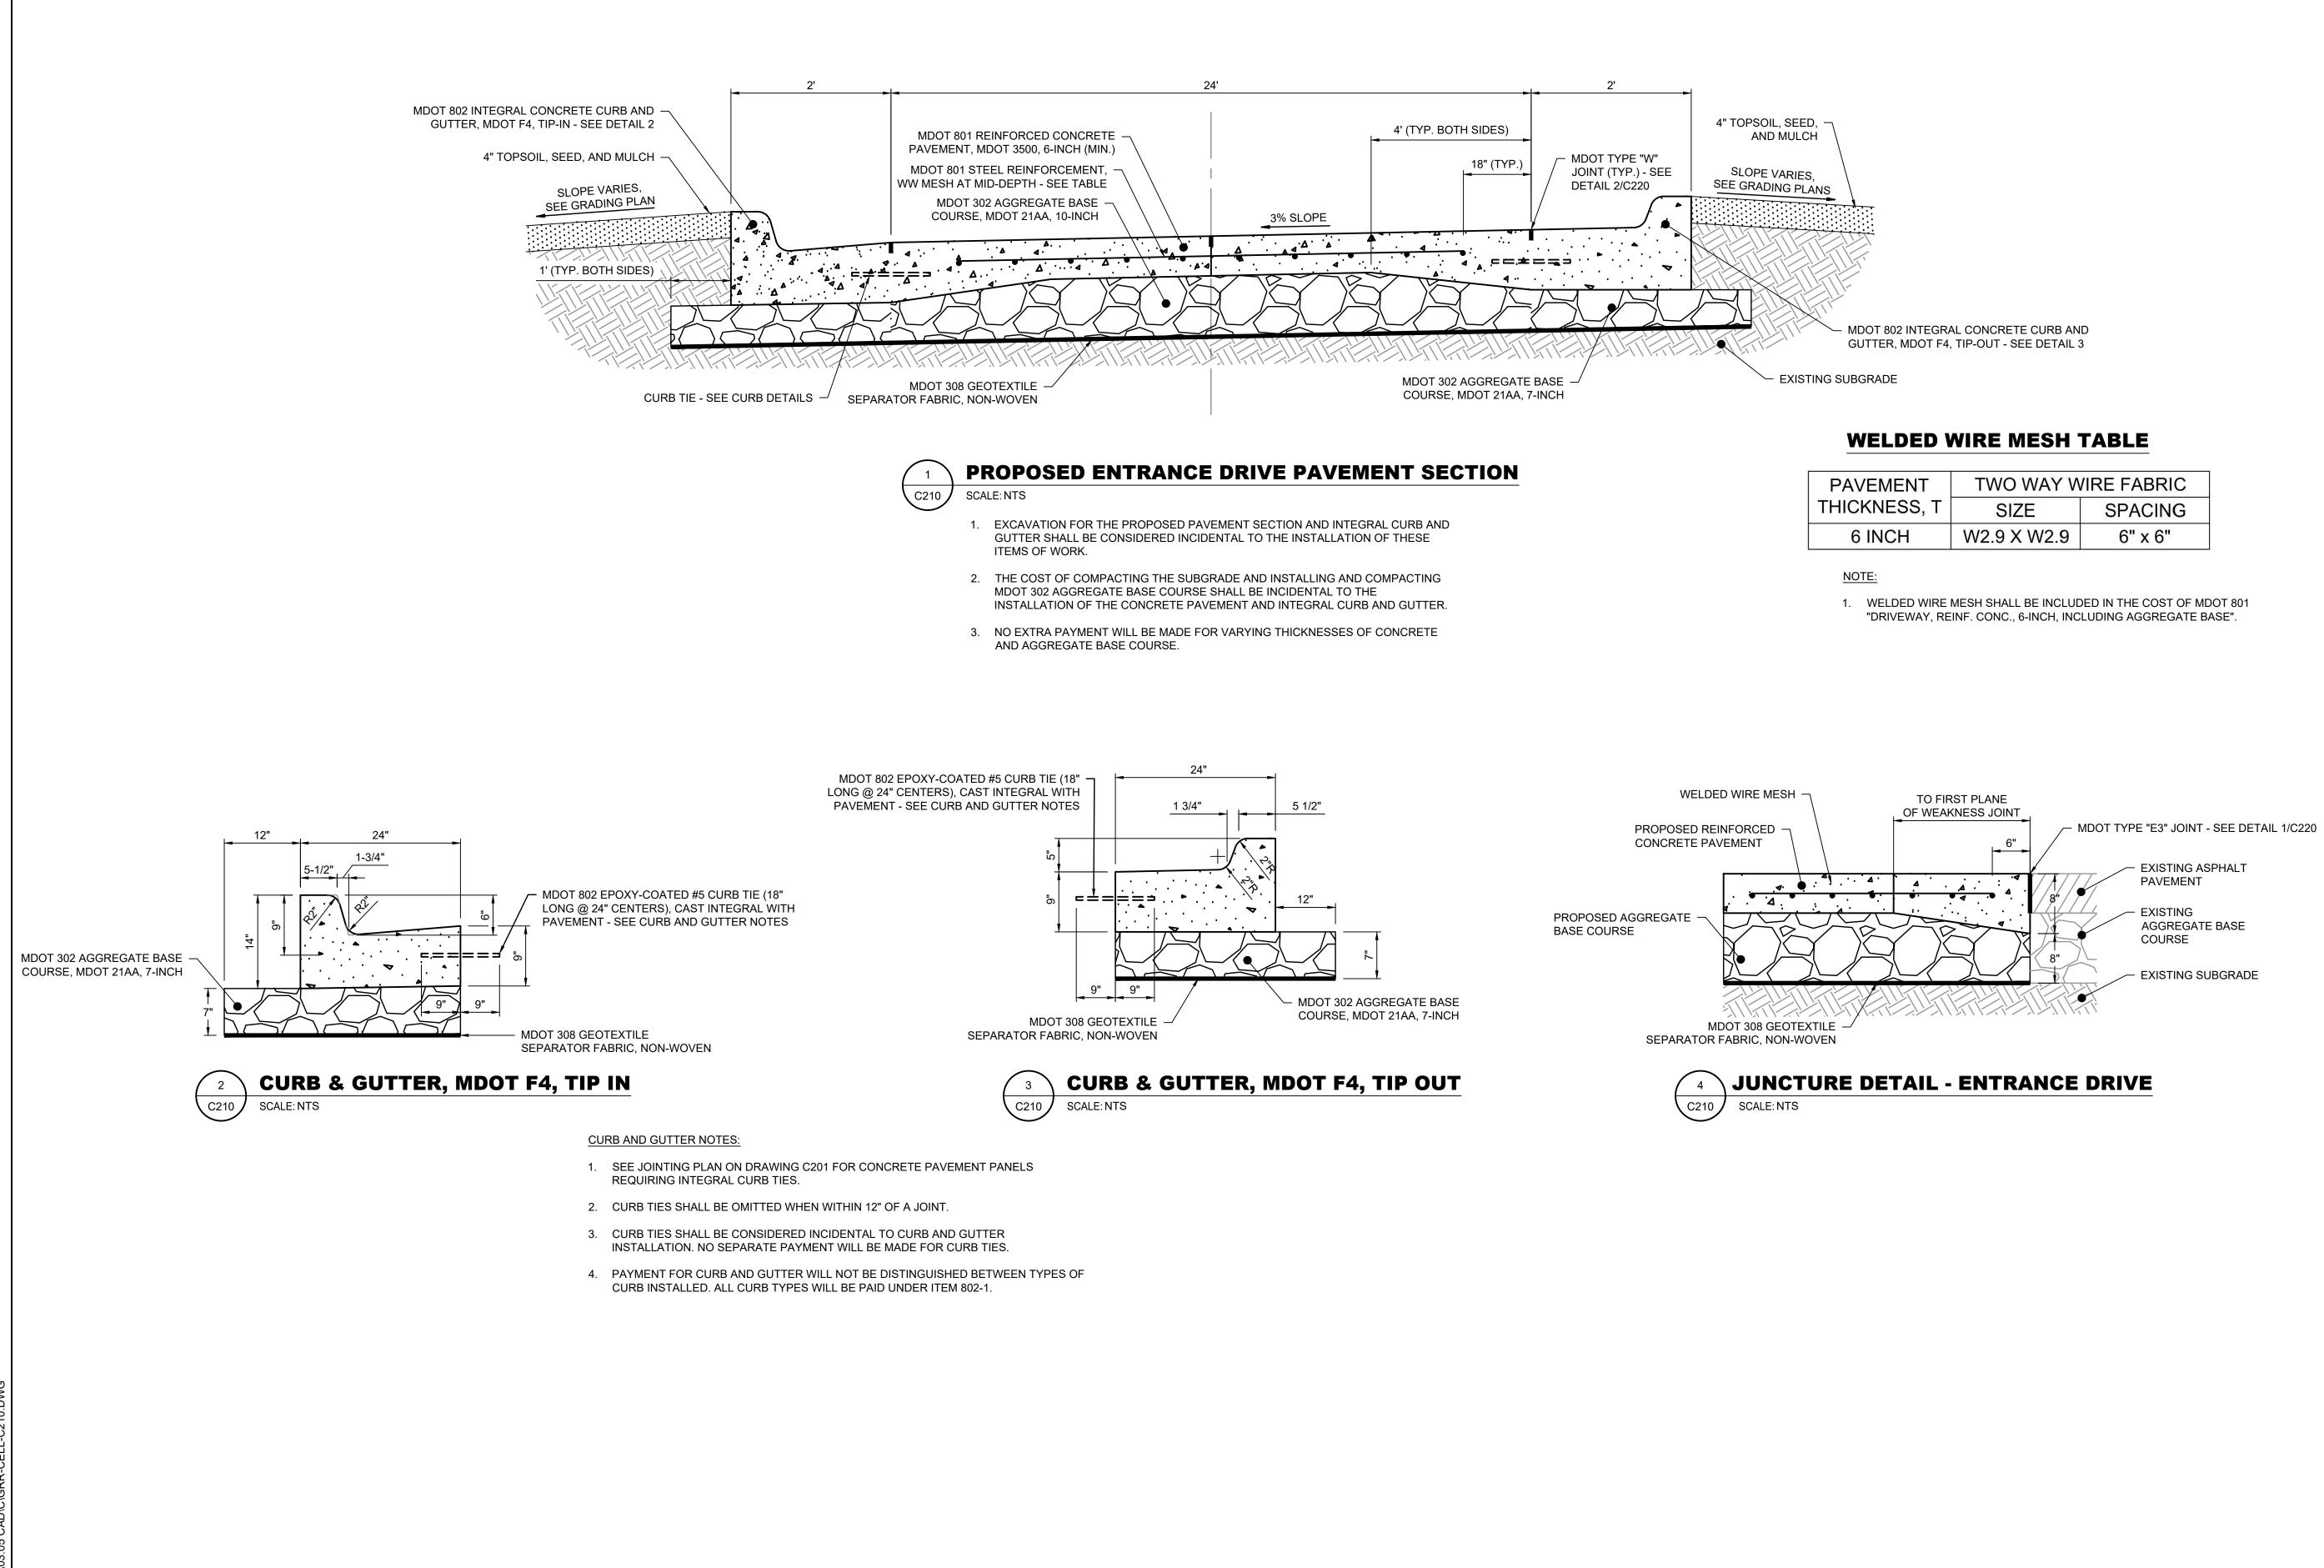

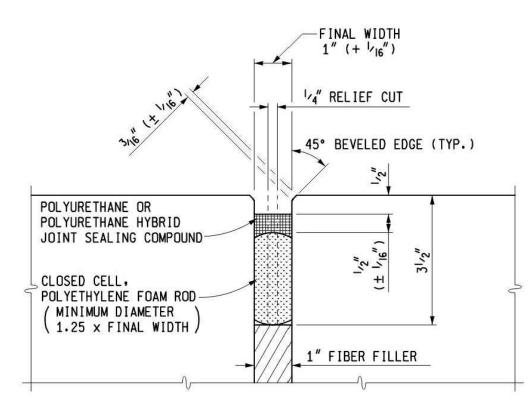

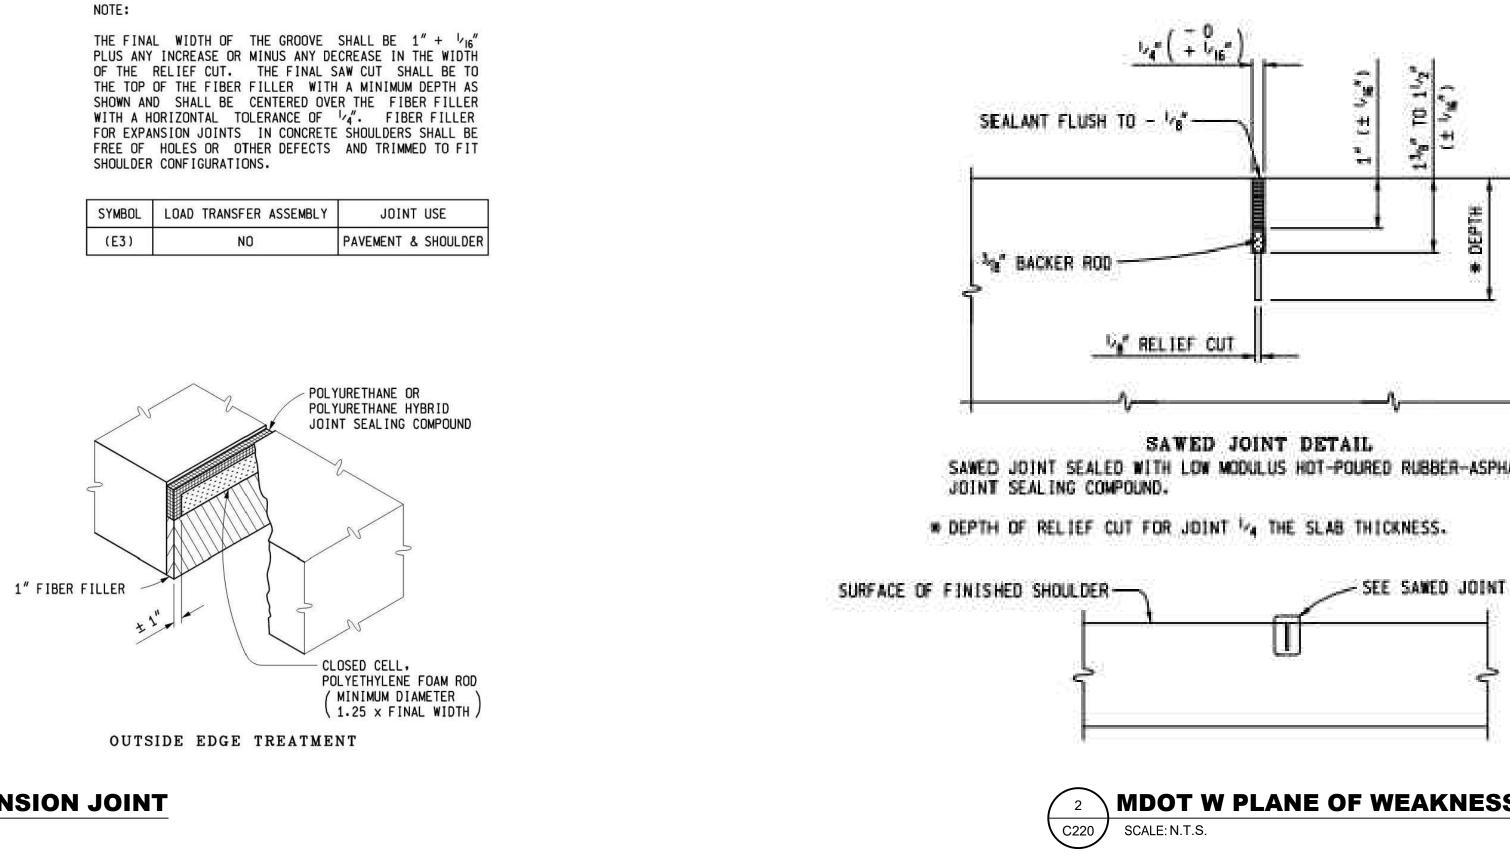



JOINTING NOTE:

PROJECT.

1. NO SEPARATE PAYMENT WILL BE MADE FOR SAWCUTTING, PREPARING NOR SEALING PROPOSED JOINTS IN CONCRETE PAVEMENT OR CURB AND GUTTER. PAYMENT FOR JOINT PREPARATION AND JOINT SEALING SHALL BE CONSIDERED INCIDENTAL TO THE VARIOUS CONCRETE PAY ITEMS OF THE


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	RELOCATE CELL PHONE LOT
	INTERNATIONAL AIRPORT
	GERALD R. FORD
	FORDInternationa Airport

PTH

RS&H.

RS&H Michigan, Inc.

436 S. MAIN STREET PLYMOUTH, MICHIGAN 48170

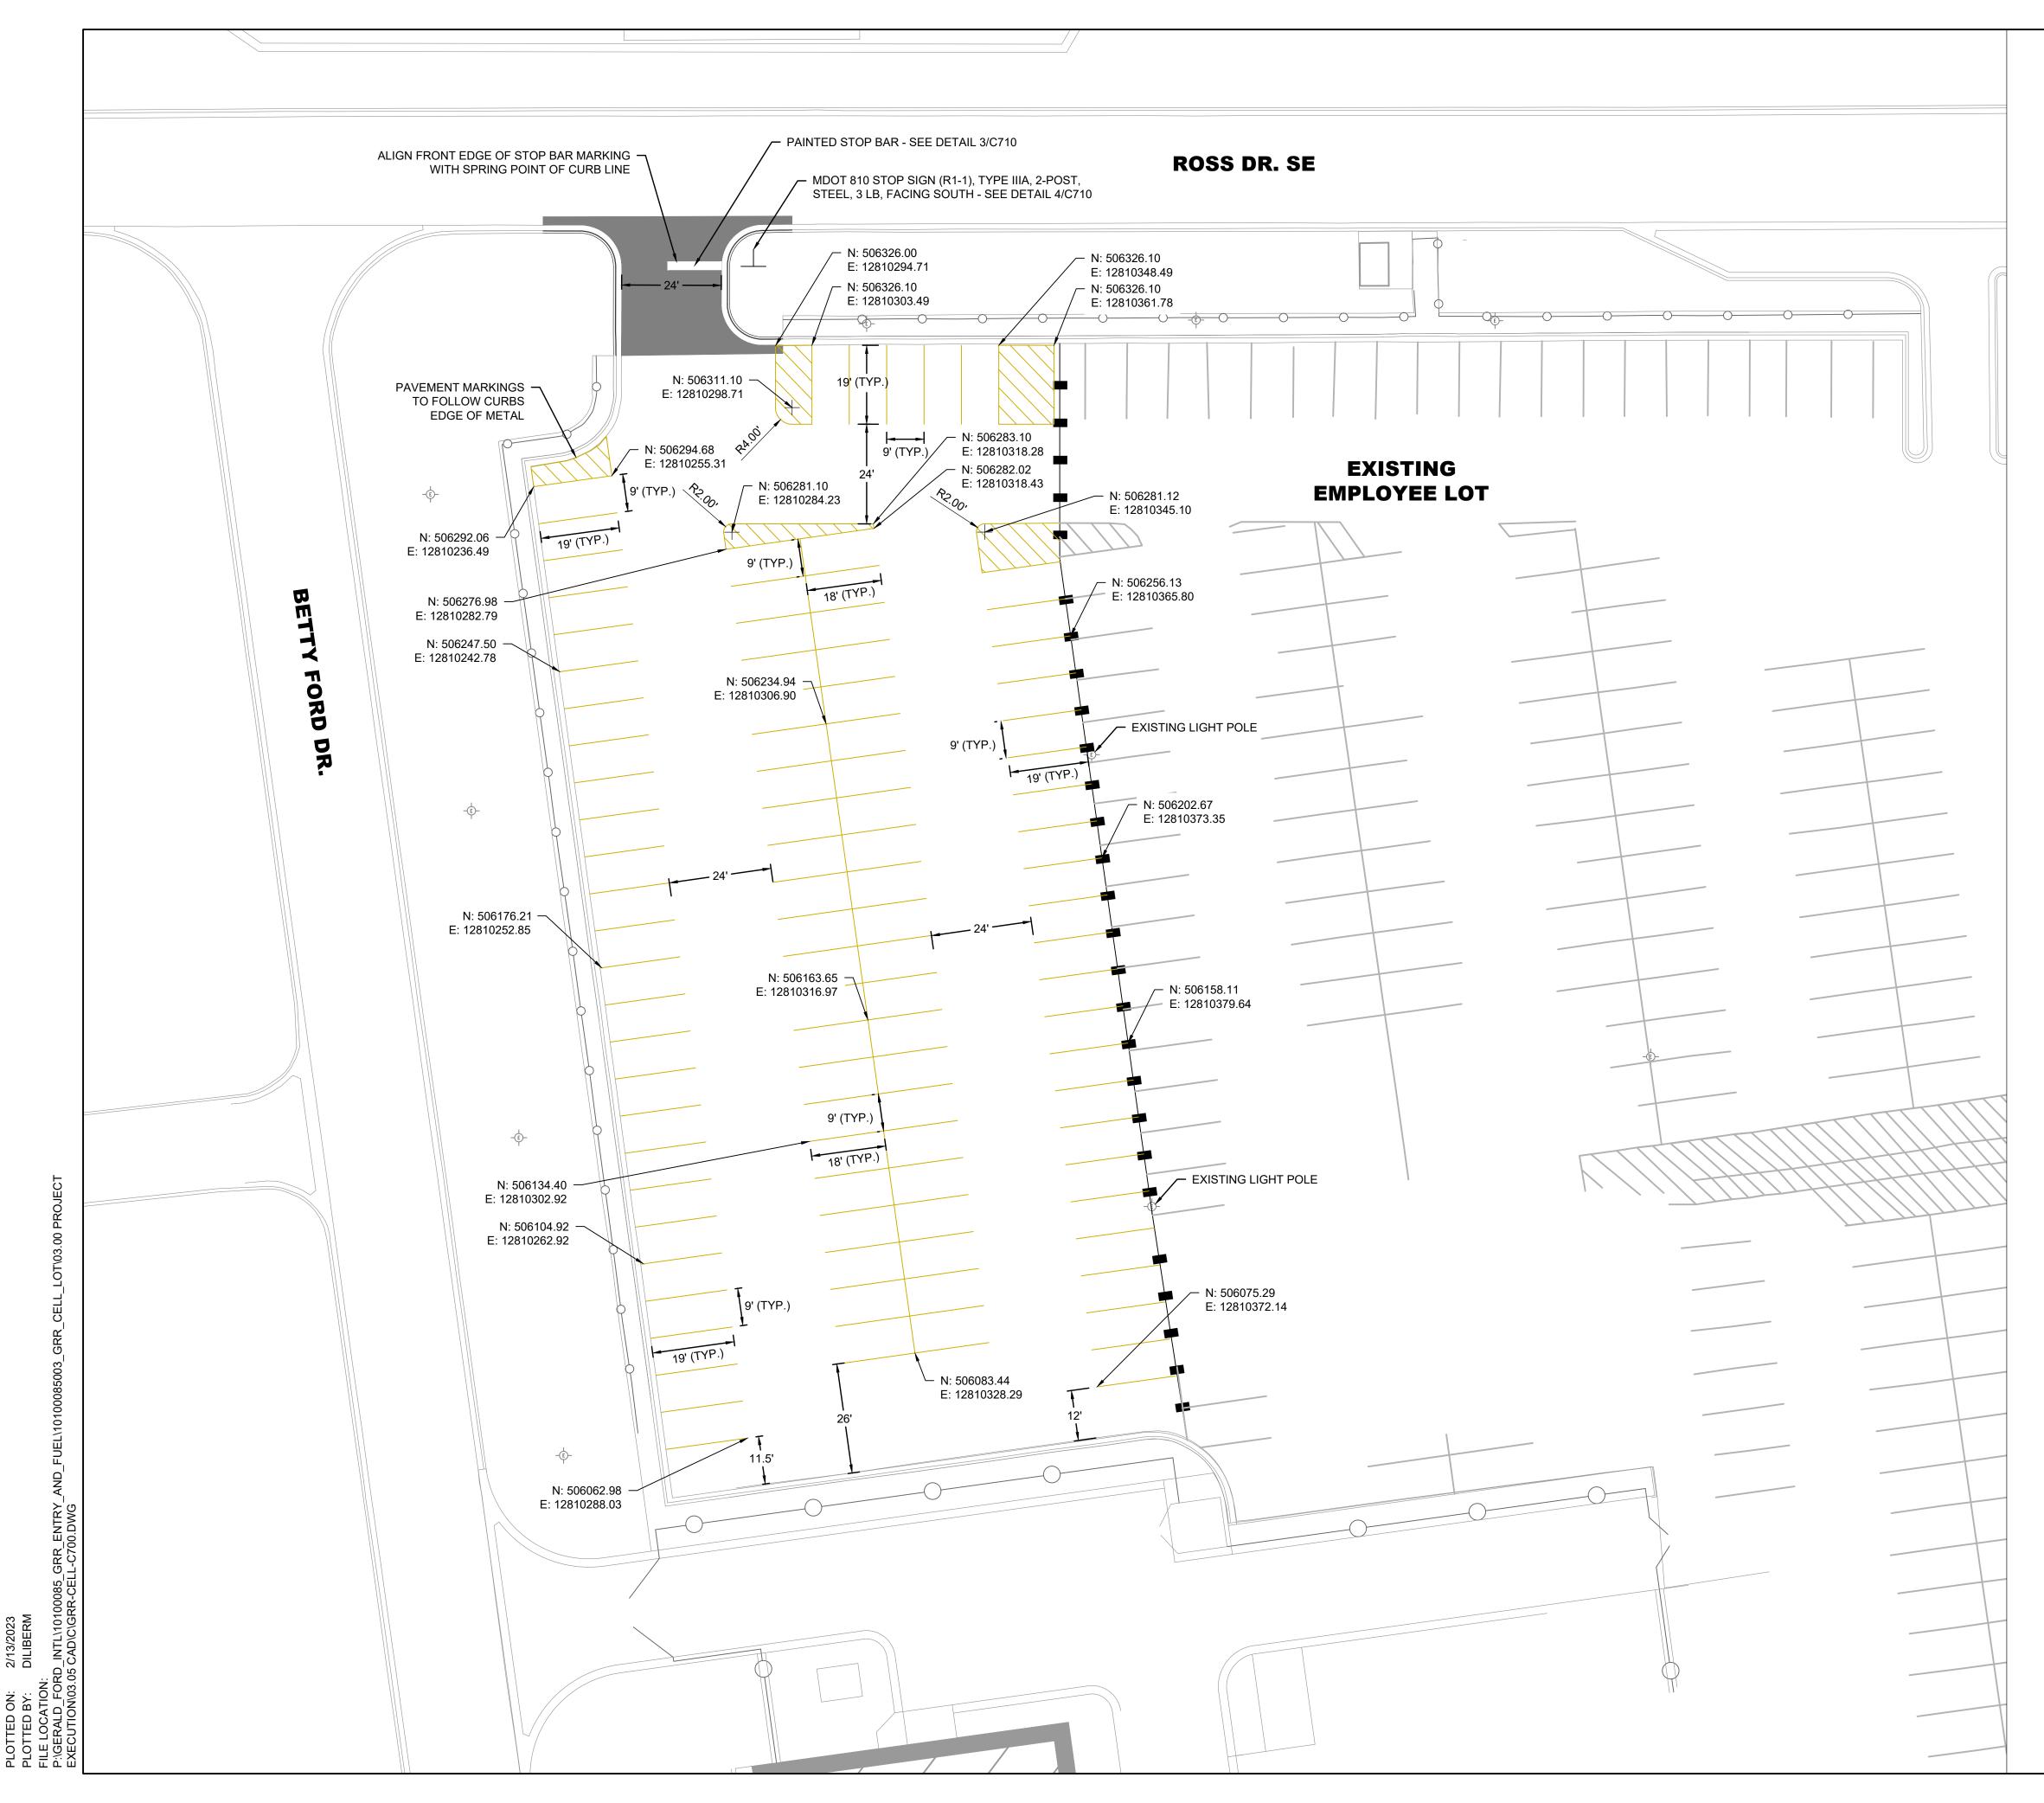



PROPOSED CONCRETE PAVEMENT

EXISTING PAVEMENT MARKINGS

PROPOSED PAVEMENT MARKING, YELLOW (BY OWNER)

PROPOSED PAVEMENT MARKING, WHITE (BY OWNER) PROPOSED MOVEABLE BARRICADES (BY OWNER)


PROPOSED STOP SIGN (BY CONTRACTOR)


EXISTING LIGHT POLE

NOTES


- 1. ALL DIMENSIONS SHOWN FROM MARKING REFERENCE POINT TO MARKING REFERENCE POINT. SEE SHEETS C710 FOR PAVEMENT MARKING DETAILS.
- 2. PROPOSED PAVEMENT MARKINGS ARE SHOWN FOR OWNER USE ONLY. GFIAA INTENDS TO SELF PERFORM THE APPLICATION OF ALL PROPOSED PAVEMENT MARKINGS.




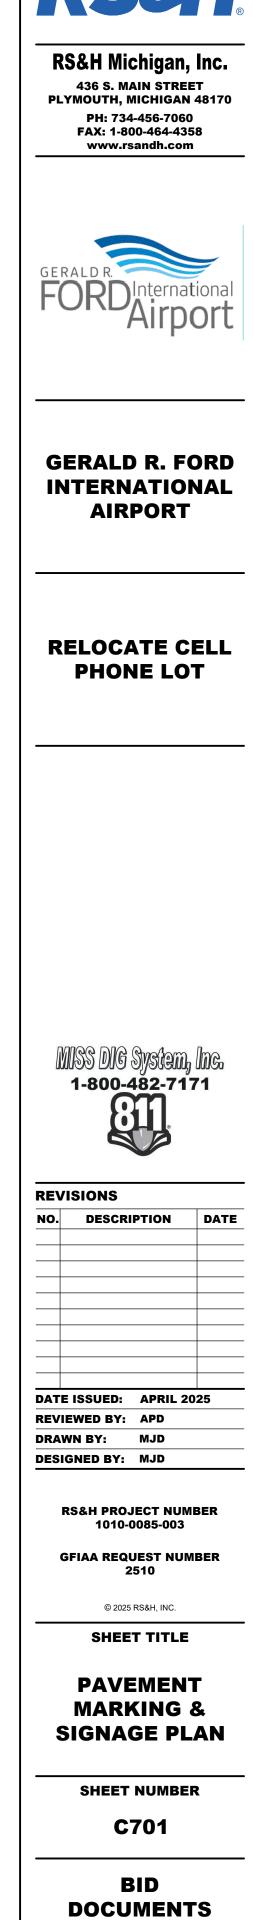

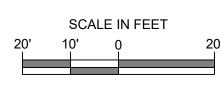



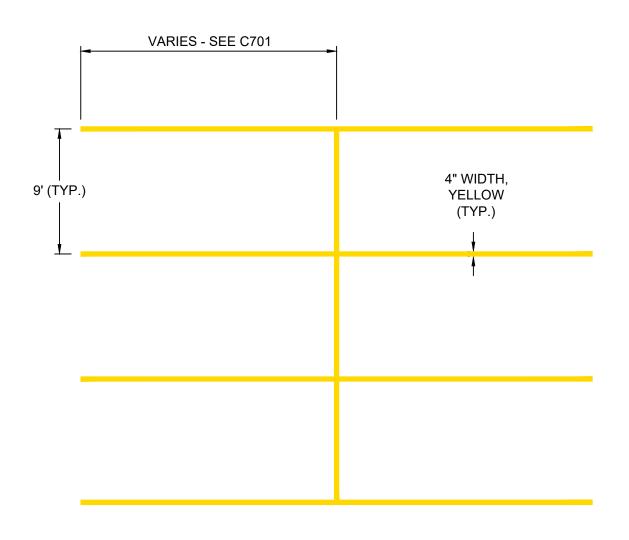


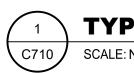

TYPICAL PARKING LAYOUT - BY OWNER SCALE: NTS


NOTES:

1. CENTER PARKING STALLS ARE 9' X 18'. OUTERMOST PARKING STALLS ARE 9' X 19'.

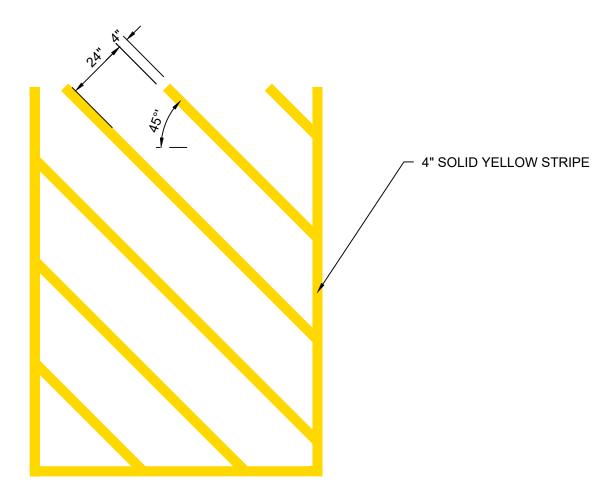



PARKING LOT CROSS HATCH MARKING - BY OWNER SCALE: NTS

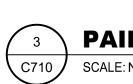



R1-1 STOP SIGN (24" ACROSS FLATS) COLORS: LEGEND - WHITE (RETROREFLECTIVE) BACKGROUND - RED (RETROREFLECTIVE) REF: MANUAL ON UNIFORM TRAFFIC CONTROL DEVICES (MUTCD) STANDARD HIGHWAY SIGNS 2009 WITH REVISIONS 1 AND 2 (ENGLISH) EDITION



NOTES:

1. ALIGN STOP SIGN WITH CENTER OF PAINTED STOP BAR.

	GERALD R. FORDInternational Airport
12'	GERALD R. FORD INTERNATIONAL AIRPORT
24" SOLID WHITE STRIPE NTED STOP BAR - BY OWNER NTS	RELOCATE CELL PHONE LOT
	Image: Description descriptindescriptindescription description description descript
	BID DOCUMENTS

RSEH

RS&H Michigan, Inc.

436 S. MAIN STREET PLYMOUTH, MICHIGAN 48170

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