	CONSTRUCTION DATA	
PRIME CONTRACTOR:		
MAJOR SUBCONTRACT	ORS AND/OR SUPPLIERS	
WORK COMPLETED		
PROJECT ENGINEER		
	ERFORMED UNDER THIS CONTRACT HAS ULL CONFORMITY WITH THE DRAWINGS,	
NOTES AND SPECIFICA	TIONS CONTAINED IN THESE PLANS ALL S AS BID, HAVE BEEN NOTED.	
S. J. WOLO I NOW I LAW	SAC SIS, THIVE BELLVINGTED.	
(Certified)		


GERALD R. FORD INTERNATIONAL **AIRPORT**

KENT COUNTY GRAND RAPIDS, MICHIGAN

TAXIWAY D LIGHTING REHABILITATION

ISSUED FOR BID MAY 2025



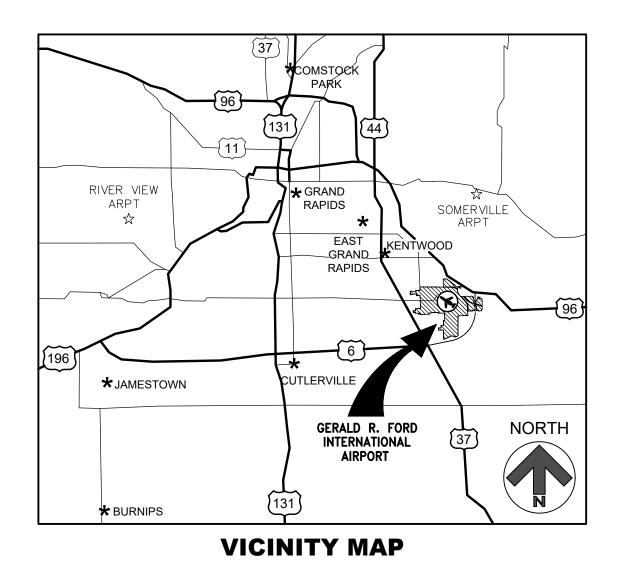

THIS DOCUMENT SHOULD BE PRINTED IN COLOR IMPORTANT DESIGN INFORMATION MAY NOT BE CORRECTLY INTERPRETED NOR EASILY DECIPHERED IF PRINTED IN GRAYSCALE.

SHEET NUMBER	INDEX OF SHEETS	REVISI DATE
G001	COVER SHEET	
G010	SUMMARY OF QUANTITIES	
G020	CONTRACT LAYOUT PLAN	
G030	OVERALL CONSTRUCTION PHASING PLAN	
G031 - G033	INDIVIDUAL CONSTRUCTION PHASING PLANS	
G040	SAFETY AND SECURITY NOTES AND DETAILS	
E001	GENERAL ELECTRICAL NOTES	
E002	GENERAL KEY PLAN	
ED101 - ED112	DEMOLITION AIRFIELD LIGHTING PLANS	
E101 - E112	PROPOSED AIRFIELD LIGHTING PLANS	
ED201	AIRFIELD LIGHTING VAULT DEMOLITION PLAN	
E201	AIRFIELD LIGHTING VAULT PROPOSED PLAN	
E301	GENERAL ELECTRICAL DETAILS	
E302	EXISTING INSTALLATION PHOTOS	

MISS DIG System, Inc. 1-800-482-7171



DESIGNERS & CONSULTANTS

RS&H.

436 South Main Street Plymouth, Michigan 48170 PH: (734) 456-7060 FAX: 1-800-464-4358 www.rsandh.com

DESIGNER'S CERTIFICATION

IN COMPLIANCE WITH THE SPONSOR'S UNITED STATES CODE, TITLE 49 CERTIFICATION, THESE PLANS AND SPECIFICATIONS HAVE BEEN PREPARED IN ACCORDANCE WITH CURRENT F.A.A. STANDARDS, IDENTIFIED IN F.A.R. PART 152.11 AND / OR STANDARDS OF THE MICHIGAN AERONAUTICS COMMISSION PREVIOUSLY APPROVED BY THE F.A.A. ANY DEVIATIONS FROM THE F.A.A. OR M.A.C. STANDARDS WHERE APPROVED BY F.A.A. LETTER DATED __/__/ AND ARE DISCUSSED IN THE ENGINEERING REPORT ACCOMPANYING THESE PLANS.

CERTIFIED -M. ANEES RAHMAN, P.E. - ENGINEER

SHEET G001

SUMMARY OF QUANTITIES								
ITEM	ITEM DESCRIPTION UNIT BID CHANGE ORDERS		ITEM DESCRIPTION		INIT BID	CHANGE ORDERS		FINAL
NUMBER	TIEW BESOKIF TION	Oiti	QUANTITY	1	2	QUANTITY		
C-100	CONTRACTOR QUALITY CONTROL PROGRAM (CQCP)	LSUM	1					
C-105	MOBILIZATION (10% MAX)	LSUM	1					
G-102-11.1	SAFETY AND SECURITY	LSUM	1					
G-102-11.2	SAFETY PLAN COMPLIANCE DOCUMENT (SPCD)	LSUM	1					
L-105-7.1	REMOVE EXISTING TAXIWAY EDGE LIGHT AND TRANSFORMER AND SALVAGE, BASE CAN TO REMAIN	EACH	375					
L-105-7.2	REMOVE EXISTING CABLE IN CONDUIT OR DUCTBANK, CONDUIT TO REMAIN	LSUM	1					
L-108-5.1	NO. 8 AWG, 5 kV, L-824, TYPE C CABLE, INSTALLED IN EXISTING CONDUIT OR DUCTBANK	FT	66,700					
L-109-7.1	AIRFIELD LIGHTING ELECTRICAL VAULT POWER AND CONTROLS MODIFICATIONS	LSUM	1					
L-109-7.2	CONSTANT CURRENT REGULATOR REMOVAL AND SALVAGE	EACH	3					
L-109-7.3	CONSTANT CURRENT REGULATOR 10KW, 3-STEP, 6.6A, 480V, L-829	EACH	3					
L-125-5.1	L-861T(L) ELEVATED TAXIWAY EDGE LIGHT ON EXISTING BASE CAN, INCLUDING ISOLATION TRANSFORMER AND CONNECTIONS	EACH	375					
L-125-5.2	REFLECTIVE LIGHT LOCATOR - SNOW WAND, 30" TALL, BLUE	EACH	375					
L-125-5.3	NEW ISOLATION TRANSFORMER AND CONNECTIONS FOR EXISTING GUIDANCE SIGN	EACH	43					
L-126-5.1	MAINTENANCE OF AIRPORT LIGHTING SYSTEMS, INCLUDING TEMPORARY CONNECTIONS/JUMPERS AND POWER/CONTROLS, AS NEEDED	LSUM	1					
L-126-5.2	AIRFIELD CIRCUIT WIRING LOCATING, PROTECTING, CLEANING, RACKING, AND TAGGING IN ALL STRUCTURES ENTERED DURING PROJECT	LSUM	1					



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GERALD R. FORD INTERNATIONAL **AIRPORT**

TAXIWAY D LIGHTING **REHABILITATION**



REVISIONS

NO. DESCRIPTION DATE

DATE ISSUED: MAY 2025 REVIEWED BY: MAR DRAWN BY: AZ DESIGNED BY: EE

RS&H PROJECT NUMBER 1010-5865-001

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SHEET TITLE

SUMMARY OF QUANTITIES

SHEET NUMBER

G010

ISSUED FOR

- CONTRACT LAYOUT PLAN: THIS PLAN IS INTENDED ONLY AS A GENERAL DESCRIPTION OF WORK ITEMS AND APPROXIMATE LOCATIONS AND LIMITS FOR THE PURPOSE OF UNDERSTANDING THE SCOPE OF THE WORK. IT SHALL NOT BE USED AS A CONSTRUCTION PLAN. REFER TO PLAN SHEETS WHICH FOLLOW FOR DETAILED CONSTRUCTION REQUIREMENTS, LOCATIONS, AND ITEMS OF WORK, AND CONSTRUCTION PHASES FOR WHICH THE CONTRACT WORK ITEMS SHALL BE COMPLETED.
- 2. PRECONSTRUCTION CONFERENCE: THE CONTRACTOR SHALL ATTEND A PRECONSTRUCTION CONFERENCE PRIOR TO BEGINNING WORK TO COORDINATE WORK PROCEDURES WITH ALL INTERESTED PARTIES. THE CONTRACTOR SHALL ALSO ATTEND ANY JOB MEETINGS CALLED BY THE OWNER.
- 3. HAUL ROUTES: LOCATION OF HAUL ROUTES ON THE AIRPORT SITE SHALL BE AS SPECIFIED ON THE PLANS OR AS APPROVED BY THE ENGINEER. IT SHALL BE THE CONTRACTOR'S RESPONSIBILITY TO COORDINATE OFF-SITE HAUL ROUTES (STATE HIGHWAYS, COUNTY ROADS OR CITY STREETS) WITH THE APPROPRIATE OWNER WHO HAS JURISDICTION OVER THE AFFECTED ROUTE.

ON-SITE HAUL ROUTES SHALL BE MAINTAINED BY THE CONTRACTOR AND SHALL BE RESTORED TO THEIR ORIGINAL CONDITION UPON COMPLETION OF BEING USED AS A HAUL ROUTE. THE BEFORE AND AFTER CONDITION OF ON-SITE HAUL ROUTES SHALL BE JOINTLY INSPECTED AND DETERMINED BY THE CONTRACTOR AND THE ENGINEER. ALL COSTS RELATED TO MAINTENANCE OF EXISTING HAUL ROUTES SHALL BE INCIDENTAL TO C-105 "MOBILIZATION".

- 4. WASTE DISPOSAL: ALL ELECTRICAL WASTE MATERIAL GENERATED DURING CONSTRUCTION SHALL BE DISPOSED OF OFF AIRPORT PROPERTY. ALL EARTH SPOILS MUST REMAIN ON AIRPORT PROPERTY.
- 5. CONTRACTOR UTILITIES: STAGING AREAS DO NOT HAVE UTILITIES. ANY UTILITIES REQUIRED BY THE CONTRACTOR, SHALL BE COORDINATED WITH THE UTILITY COMPANIES AND SHALL BE THE SOLE RESPONSIBILITY OF THE CONTRACTOR. THE CONTRACTOR SHALL CONTACT GFIAA REGARDING TEMPORARY WATER ACCESS.


THE CONTRACTOR SHALL BE RESPONSIBLE FOR TEMPORARY RESTROOM FACILITIES FOR ALL CONTRACTOR AND SUBCONTRACTOR PERSONNEL. AT NO TIME WILL THE CONTRACTOR BE ALLOWED TO UTILIZE AIRPORT OR TENANT RESTROOM FACILITIES. TEMPORARY RESTROOM FACILITIES SHALL BE LOCATED IN THE CONTRACTOR STAGING AREA, UNLESS OTHERWISE APPROVED BY THE AIRPORT.

PROTECTION AND REPAIR OF DAMAGE TO EXISTING CABLES: LOCATION OF EXISTING AIRFIELD UNDERGROUND CABLES WILL BE FLAGGED ONE TIME BY AIRPORT AND FAA PERSONNEL THROUGH FLAGGED AGAIN AT THE CONTRACTOR'S EXPENSE. ALL UNDERGROUND CABLES SHALL BE PROTECTED AND DAMAGES REPAIRED EXPEDITIOUSLY AT THE CONTRACTOR'S EXPENSE AT NO ADDITIONAL COST TO THE OWNER. THE CONTRACTOR SHALL PROVIDE A MINIMUM OF 72 HOURS NOTICE PRIOR TO WORK TO ALLOW FOR STAKING IN THESE AREAS. ALL SUCH REPAIRS SHALL BE IN ACCORDANCE WITH THE SPECIFICATIONS, OR AS DIRECTED BY THE OWNER OF THE CABLE, AND SHALL BE AT THE CONTRACTOR'S EXPENSE. IF FAA CABLES ARE DAMAGED, REPAIRS SHALL BE DONE IN ACCORDANCE WITH FAA REQUIREMENTS AND IN THE PRESENCE OF AN FAA REPRESENTATIVE. THE OWNER MAY ELECT TO HAVE THE REPAIR PERFORMED BY OTHERS, IN WHICH CASE, THE CONTRACTOR SHALL BE RESPONSIBLE FOR PAYING THE INCURRED COSTS OF THE REPAIRS. THE CONTRACTOR SHALL BE RESPONSIBLE FOR ALL INCIDENTAL AND CONSEQUENTIAL COSTS INCURRED BY THE OWNER FOR LOSS OF SERVICE. ALL CABLES ENCOUNTERED WHICH ARE NOT SHOWN ON THE PLANS SHALL BE DOCUMENTED IN THE FOLLOWING

1) CABLE LOCATION AND DEPTH SHALL BE NOTED ON CONTRACTOR'S CONSTRUCTION DRAWINGS. 2) CONTRACTOR SHALL CONTACT GFIAA/FAA PERSONNEL IMMEDIATELY. 3) CONTRACTOR SHALL DIGITALLY PHOTOGRAPH ALL ENCOUNTERED CABLES AND MAINTAIN A LOG

4) CONTRACTOR SHALL IMMEDIATELY REPAIR DAMAGED CABLES AT NO COST TO THE GFIAA/FAA.

- 7. CONSTRUCTION LIMITS: ALL CONTRACTOR VEHICLES AND TRAFFIC SHALL REMAIN WITHIN THE DESIGNATED CONSTRUCTION LIMITS OR HAUL ROUTES.
- 8. CONTRACTOR STAGING AREAS: THE CONTRACTOR MUST USE THE CORRECT STAGING AREAS DURING EACH PHASE OF THE PROJECT. STAGING AREAS ARE SUBJECT TO ALL AIRPORT SAFETY AND SECURITY REQUIREMENTS, SEE SHEET G040.
- 9. SAFETY AND PHASING: THE CONTRACTOR SHALL COMPLY WITH THE SAFETY AND PHASING PLANS AND TO THE AIRPORT SAFETY REQUIREMENTS SECTIONS OF THE SPECIFICATIONS. THESE SHALL BE STRICTLY
- 10. COMPLETION OF WORK: UPON COMPLETION OF THE WORK, THE CONTRACTOR SHALL REMOVE FROM THE SITE ALL TEMPORARY FACILITIES, SURPLUS MATERIAL, AND EQUIPMENT BELONGING TO HIM OR HIS SUBCONTRACTOR'S FORCES. PRIOR TO REMOVAL FROM AIRPORT PROPERTY OF SURPLUS MATERIALS, THE CONTRACTOR SHALL OBTAIN WRITTEN PERMISSION OF THE OWNER.

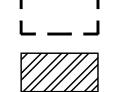


PROPOSED WORK LIMITS



CONTRACTOR PARKING AND STAGING AREA (LANDSIDE)

STAGING AND LAYDOWN AREA

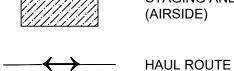

(AIRSIDE)

	P1	N042° 52' 46.84"	W085° 32' 38.70"
	P2	N042° 52' 52.72"	W085° 31' 46.52"
	P3	N042° 53' 05.97"	W085° 31' 49.28"
	P4	N042° 53' 06.65"	W085° 31' 43.10"
	P5	N042° 53' 01.43"	W085° 31' 42.01"
	P6	N042° 52' 52.96"	W085° 31' 44.31"
	P7	N042° 53' 02.14"	W085° 30' 22.73"
	P8	N042° 53' 06.04"	W085° 30' 17.59"
	P9	N042° 53' 07.18"	W085° 30' 07.46"
	P10	N042° 52' 51.73"	W085° 30' 04.25"
	P11	N042° 52' 34.64"	W085° 32' 36.16"
·	·		

PROJECT LIMITS - COORDINATE TABLE

LONGITUDE

STAC	STAGING AREA - COORDINATE TABLE					
POINT	LATITUDE	LONGITUDE				
S1	N042° 53' 06.77"	W085° 32' 12.53"				
S2	N042° 53' 06.85"	W085° 32' 09.42"				
S3	N042° 53' 03.58"	W085° 32' 12.41"				
S4	N042° 53' 03.67"	W085° 32' 09.21"				
S5	N042° 52' 41.90"	W085° 32' 33.23"				
S6	N042° 52' 43.05"	W085° 32' 29.86"				
S7	N042° 52' 42.24"	W085° 32' 27.10"				
S8	N042° 52' 40.24"	W085° 32' 32.85"				
S9	N042° 52' 41.49"	W085° 30' 00.01"				
S10	N042° 52' 41.52"	W085° 29' 57.03"				
S11	N042° 52' 38.87"	W085° 29' 56.98"				
S12	N042° 52' 38.84"	W085° 29' 59.96"				



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GERALD R. FORD INTERNATIONAL **AIRPORT**

TAXIWAY D LIGHTING **REHABILITATION**



REVI	SIONS	
NO.	DESCRIPTION	DATE
DATE	ISSUED: MAY 20	 25

DATE ISSUED: MAY 2025 REVIEWED BY: MAR DRAWN BY: DESIGNED BY: SCR

> RS&H PROJECT NUMBER 1010-5865-001

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SHEET TITLE

CONTRACT LAYOUT PLAN

SHEET NUMBER

G020

ISSUED FOR BID


NORTH

- 1. THE CONTRACTOR SHALL BE GIVEN THE SPECIFIC NUMBER OF DAYS TO COMPLETE THE WORK AS SHOWN. LIQUIDATED DAMAGES SHALL BE ASSESSED AFTER THE CONTRACT TIME HAS EXPIRED UNLESS THE CONTRACTOR CAN SHOW JUST CAUSE FOR DELAYS. IT IS THE SOLE RESPONSIBILITY OF THE CONTRACTOR TO PROVIDE JUSTIFICATION FOR WAIVING ANY LIQUIDATED DAMAGE CHARGED.
- 2. THE CONTRACTOR MUST KEEP AIRFIELD PAVEMENTS OPERATIONAL AT ALL TIMES. AIRPORT OPERATIONS SHALL NOT BE INTERRUPTED BY CONSTRUCTION ACTIVITIES AT ANY TIME.
- 3. BARRICADES MUST BE INSTALLED AT THE LOCATIONS SHOWN ON THE PLAN THROUGH COORDINATION WITH THE RPR. BARRICADES MUST BE INSTALLAED AT THE BEGINNING OF EACH PHASE AND REMAIN IN PLACE THROUGHOUT THE PHASE. ONE DRIVE LANE MUST REMAIN OPEN ON THE PERIMETER ROAD AT ALL TIMES.
- 4. COSTS ASSOCIATED WITH PLACING AND MAINTAINING BARRICADES AND CLOSURES WILL BE INCLUDED IN PAY ITEM C-105 "MOBILIZATION".
- 5. CONTRACTOR MUST SUBMIT CONSTRUCTION SEQUENCING PLAN TO BE REVIEWED BEFORE CONSTRUCTION START.
- 6. CONTRACTOR SHALL PROVIDE FULL-TIME FLAGGER DURING CONSTRUCTION. FLAGGER MUST BE TRAINED BY GFIAA IN ADVANCE OF CONSTRUCTION NTP.

KEYED NOTES:

- 1. AT LEAST ONE TAXIWAY FROM THE CORPORATE AND TERMINAL APRON TO TAXIWAY D MUST REMAIN OPEN FOR AIRPORT OPERATIONS AT ALL TIME. BARRICADES TO BE REMOVED/RELOCATED AS NEEDED.
- (2.) AT LEAST ONE TAXIWAY FROM THE FEDEX APRON TO TAXIWAY D MUST REMAIN OPEN FOR AIRPORT OPERATIONS AT ALL TIME.
- (3.) REPLACEMENT OF ALL HOMERUN CIRCUITS SHALL BE COMPLETED IN ONE SINGULAR OPERATION. CONTRACTOR MAY CHOOSE THE APPROPRIATE PHASE TO REPLACE HOMERUN CIRCUITS IN COORDINATION WITH AIRPORT AND ENGINEER.

SCHEMATIC CONSTRUCTION SEQUENCING:

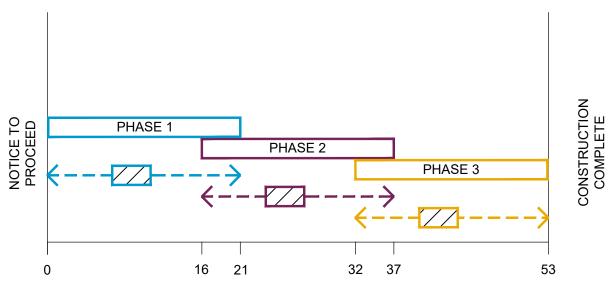

PHASE 1 21 CALENDER DAYS \$1,500 PER CALENDAR DAY PHASE 2 21 CALENDER DAYS \$1,500 PER CALENDAR DAY PHASE 3 21 CALENDER DAYS \$1,500 PER CALENDAR DAY

DURATION

PHASE

LIQUIDATED DAMAGES

TOTAL CONTRACT TIME OF 53 CALENDAR DAYS

PHASING DETAILS:

<u>PHASE 1</u> - 21 DAYS

- CRITICAL WORK FLOATING SUBPHASE - 5 DAYS


<u>PHASE 2</u> - 21 DAYS

 CRITICAL WORK FLOATING SUBPHASE - 5 DAYS

<u>PHASE 3</u> - 21 DAYS

 CRITICAL WORK FLOATING SUBPHASE - 5 DAYS

LEGEND:

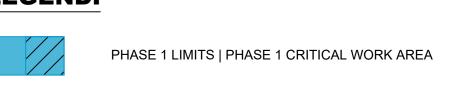

PHASE 2 LIMITS | PHASE 2 CRITICAL WORK AREA PHASE 3 LIMITS | PHASE 3 CRITICAL WORK AREA

WORK AREA FOR HOMERUN CIRCUIT REPLACEMENT - SEE NOTE 3 HAUL ROUTE

TAXIWAY OBJECT FREE AREA —— TOFA —— **RUNWAY SAFETY AREA** ----- RSA -----CONSTRUCTION FLAGGER

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GERALD R. FORD INTERNATIONAL AIRPORT

TAXIWAY D LIGHTING REHABILITATION



SCALE IN FEET

REVISIONS NO. DESCRIPTION DATE DATE ISSUED: MAY 2025 REVIEWED BY: MAR DRAWN BY: SCR

> RS&H PROJECT NUMBER 1010-5865-001

DESIGNED BY: SCR

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SHEET TITLE

OVERALL CONSTRUCTION PHASING PLAN

SHEET NUMBER

G030

RELOCATION UPON REQUEST FROM AIRPORT OR RPR TO ENSURE ACCESS TO ALL AIRPORT TENANTS. BARRICADES MUST BE INSTALLED AT THE BEGINNING OF EACH PHASE AND REMAIN IN PLACE THROUGHOUT THE PHASE.

ECONOMY PARKING LOT

- 4. COSTS ASSOCIATED WITH PLACING AND MAINTAINING BARRICADES AND CLOSURES WILL BE INCLUDED IN PAY ITEM C-105 "MOBILIZATION".
- 5. CONTRACTOR MUST SUBMIT CONSTRUCTION SEQUENCING PLAN TO BE REVIEWED BEFORE CONSTRUCTION START.
- 6. TEMPORARY LOW-PROFILE BARRICADES ARE ADDITIONAL BARRICADES TO BE PLACED WHEN WORKING IN CRITICAL WORK AREAS. CONTRACTOR TO COORDINATE WITH GFIAA AIRPORT OPERATIONS ON EXACT LOCATION AND POSITION OF TEMPORARY LOW-PROFILE BARRICADES. CONTRACTOR SHALL NOT PLACE ANY TEMPORARY BARRICADES WITHOUT EXPLICIT DIRECTION FROM GFIAA NOR WITHOUT AN ESCORT FROM GFIAA AIRPORT OPERATIONS. TEMPORARY BARRICADES SHALL BE REMOVED AFTER WORK IS COMPLETED IN EACH CRITICAL WORK AREA.
- 7. CONTRACTOR SHALL PROVIDE FULL-TIME FLAGGER DURING CONSTRUCTION. FLAGGER MUST BE TRAINED BY GFIAA IN ADVANCE OF CONSTRUCTION NTP.

KEYED NOTES:

- 1. AT LEAST ONE TAXIWAY FROM THE CORPORATE AND TERMINAL APRON TO TAXIWAY D MUST REMAIN OPEN FOR AIRPORT OPERATIONS AT ALL TIME. BARRICADES TO BE REMOVED/RELOCATED AS NEEDED.
- 2. AT LEAST ONE TAXIWAY FROM THE FEDEX APRON TO TAXIWAY D MUST REMAIN OPEN FOR AIRPORT OPERATIONS AT ALL TIME.
- (3.) REPLACEMENT OF ALL HOMERUN CIRCUITS SHALL BE COMPLETED IN ONE SINGULAR OPERATION. CONTRACTOR MAY CHOOSE THE APPROPRIATE PHASE TO REPLACE HOMERUN CIRCUITS IN COORDINATION WITH AIRPORT AND ENGINEER.

- REPLACE ISOLATION TRANSFORMERS IN EXISTING
- AIRFIELD CLOSURES

SIGNS


- TAXIWAY D CLOSED BETWEEN TAXIWAY M AND
- **RUNWAY 8R**
- TAXIWAY D2 CLOSED
- TAXIWAY Y CLOSED TAXIWAY R - CLOSED
- TAXIWAY Z OFF PEAK ROTATING CLOSURES NORTH
- OF TAXIWAY D, INCLUDING TAXIWAY D INTERSECTION - TERMINAL APRON - ROTATING DAYTIME CLOSURES
- RUNWAY 8R/26L OFF PEAK CLOSURES



PHASE 3 LIMITS | PHASE 3 CRITICAL WORK AREA




WORK AREA FOR HOMERUN CIRCUIT REPLACEMENT - SEE NOTE 3

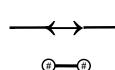

#—**#**

HAUL ROUTE

LOW-PROFILE BARRICADES -NUMBER DENOTES PHASE TEMPORARY LOW-PROFILE BARRICADES -

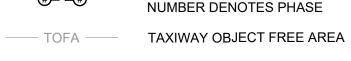



CONSTRUCTION FLAGGER - SEE NOTE 7

TAXIWAY CLOSURE MARKER

RUNWAY SAFETY AREA

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GERALD R. FORD INTERNATIONAL **AIRPORT**

TAXIWAY D LIGHTING REHABILITATION



NO. DESCRIPTION DATE

NORTH

SCALE IN FEET

DES	IGNED BY:	SCR	
DRAWN BY:		SCR	
REVIEWED BY:		MAR	
DAT	E ISSUED:	MAY 20	25

REVISIONS

RS&H PROJECT NUMBER 1010-5865-001


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SHEET TITLE

CONSTRUCTION **PHASING PLAN -**PHASE 1

SHEET NUMBER

G031

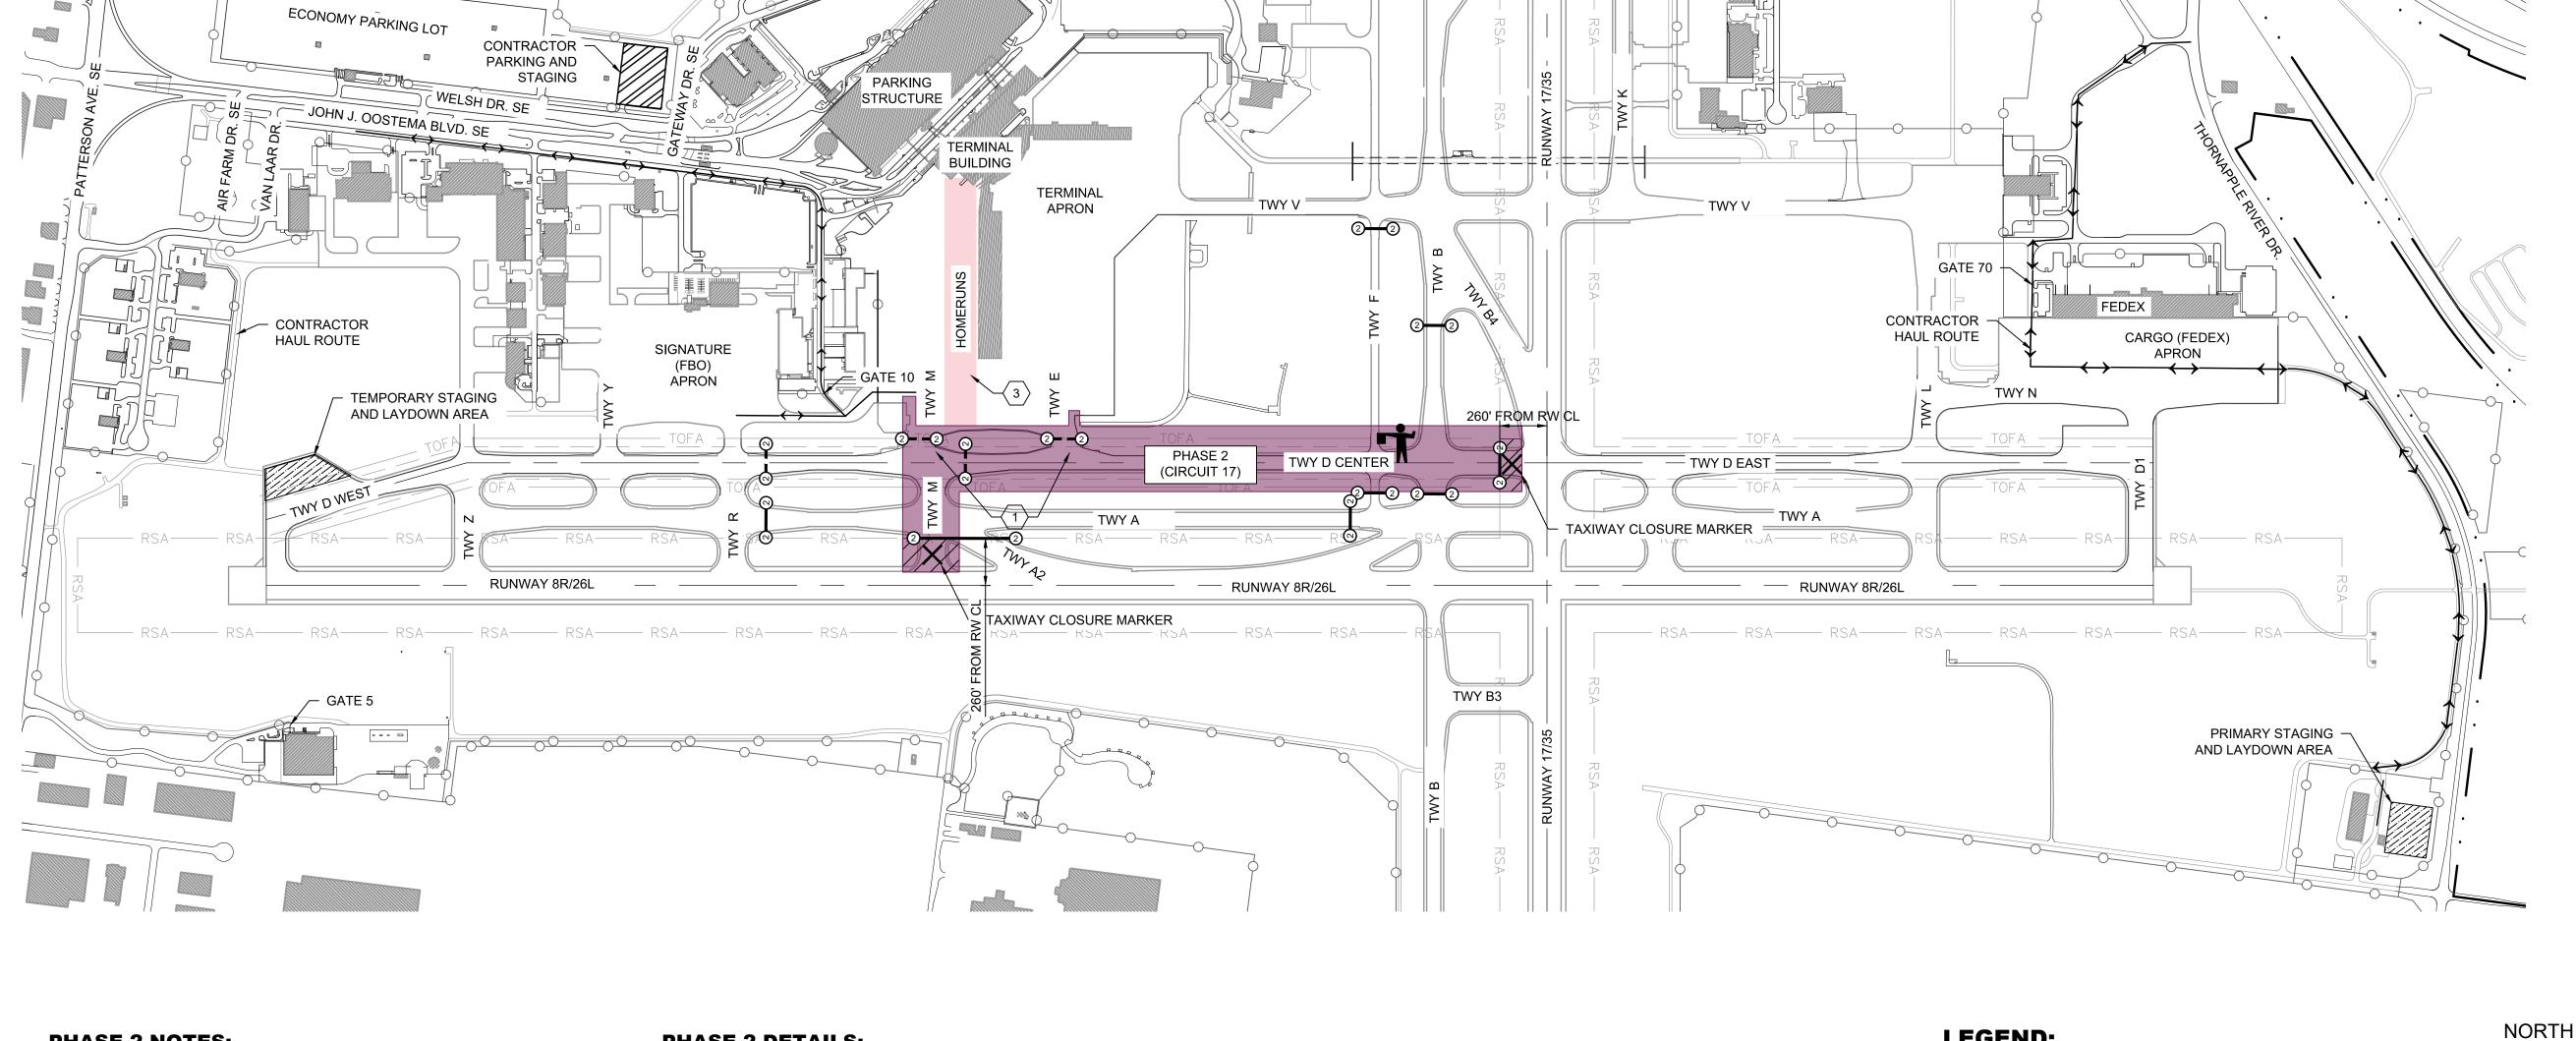

PHASE 2 NOTES:

- 1. TAXIWAY M AND TAXIWAY E NOT TO BE CLOSED CONCURRENTLY.
- THE CONTRACTOR MUST KEEP ACTIVE AIRFIELD PAVEMENTS OPERATIONAL AT ALL TIMES. AIRPORT OPERATIONS SHALL NOT BE INTERRUPTED BY CONSTRUCTION ACTIVITIES AT ANY TIME.
- 3. BARRICADES MUST BE INSTALLED AT THE LOCATIONS SHOWN ON THE PLAN THROUGH COORDINATION WITH THE RPR. LOCATIONS ARE SUBJECT TO RELOCATION UPON REQUEST FROM AIRPORT OR RPR TO ENSURE ACCESS TO ALL AIRPORT TENANTS. BARRICADES MUST BE INSTALLED AT THE BEGINNING OF EACH PHASE AND REMAIN IN PLACE THROUGHOUT THE PHASE.
- 4. COSTS ASSOCIATED WITH PLACING AND MAINTAINING BARRICADES AND CLOSURES WILL BE INCLUDED IN PAY ITEM C-105 "MOBILIZATION".
- 5. CONTRACTOR MUST SUBMIT CONSTRUCTION SEQUENCING PLAN TO BE REVIEWED BEFORE CONSTRUCTION START.
- 6. TEMPORARY LOW-PROFILE BARRICADES ARE ADDITIONAL BARRICADES TO BE PLACED WHEN WORKING IN CRITICAL WORK AREAS. CONTRACTOR TO COORDINATE WITH GFIAA AIRPORT OPERATIONS ON EXACT LOCATION AND POSITION OF TEMPORARY LOW-PROFILE BARRICADES. CONTRACTOR SHALL NOT PLACE ANY TEMPORARY BARRICADES WITHOUT EXPLICIT DIRECTION FROM GFIAA NOR WITHOUT AN ESCORT FROM GFIAA AIRPORT OPERATIONS. TEMPORARY BARRICADES SHALL BE REMOVED AFTER WORK IS COMPLETED IN EACH CRITICAL WORK AREA.
- 7. CONTRACTOR SHALL PROVIDE FULL-TIME FLAGGER DURING CONSTRUCTION. FLAGGER MUST BE TRAINED BY GFIAA IN ADVANCE OF CONSTRUCTION NTP.

KEYED NOTES:

- APRON TO TAXIWAY D MUST REMAIN OPEN FOR AIRPORT OPERATIONS
- 2. AT LEAST ONE TAXIWAY FROM THE FEDEX APRON TO TAXIWAY D MUST REMAIN OPEN FOR AIRPORT OPERATIONS AT ALL TIME.
- (3.) REPLACEMENT OF ALL HOMERUN CIRCUITS SHALL BE COMPLETED IN ONE SINGULAR OPERATION. CONTRACTOR MAY CHOOSE THE APPROPRIATE PHASE TO REPLACE HOMERUN CIRCUITS IN COORDINATION WITH AIRPORT AND ENGINEER.

PHASE 2 DETAILS:

PHASE 2 - 21 DAYS

- REMOVAL OF TAXIWAY EDGE LIGHTING AND
- RELATED CIRCUITS - INSTALLATION OF TAXIWAY EDGE LIGHTING AND
- RELATED CIRCUITS REPLACE ISOLATION TRANSFORMERS IN
- **EXISTING SIGNS**

AIRFIELD CLOSURES

- TAXIWAY D CLOSED BETWEEN TAXIWAY M AND
- **RUNWAY 17/35** - TAXIWAY M - CLOSED
- TAXIWAY E CLOSED
- TAXIWAY A CLOSED WEST OF TAXIWAY F
- TAXIWAY A2 CLOSED
- TAXIWAY F CLOSED SOUTH OF TAXIWAY V - TAXIWAY B - CLOSED BETWEEN TAXIWAY D AND
- SOUTH OF TAXIWAY B4 - TERMINAL APRON - ROTATING DAYTIME
- CLOSURES
- RUNWAY 8R/26L OFF PEAK CLOSURES - RUNWAY 17/35 - OFF PEAK CLOSURES

LEGEND:

----- TOFA -----





PHASE 3 LIMITS | PHASE 3 CRITICAL WORK AREA



REPLACEMENT - SEE NOTE 3

HAUL ROUTE

LOW-PROFILE BARRICADES - NUMBER DENOTES PHASE

TEMPORARY LOW-PROFILE BARRICADES - NUMBER DENOTES PHASE

TAXIWAY OBJECT FREE AREA

CONSTRUCTION FLAGGER - SEE NOTE 7

RUNWAY SAFETY AREA ----- RSA -----

TAXIWAY CLOSURE MARKER

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GERALD R. FORD INTERNATIONAL **AIRPORT**

TAXIWAY D LIGHTING REHABILITATION



SCALE IN FEET

REVI	SIONS		
NO.	DESCRI	PTION	DATI
DATE	ISSUED:	MAY 20	 25
REVIE	WED BY:	MAR	
DRAW	N BY:	SCR	
DESIG	NED BY:	SCR	

RS&H PROJECT NUMBER 1010-5865-001

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SHEET TITLE

CONSTRUCTION **PHASING PLAN -**PHASE 2

SHEET NUMBER

G032

ISSUED FOR BID

1. AT LEAST ONE TAXIWAY FROM THE CORPORATE AND TERMINAL AT ALL TIME. BARRICADES TO BE REMOVED/RELOCATED AS NEEDED.

- THE CONTRACTOR MUST KEEP ACTIVE AIRFIELD PAVEMENTS OPERATIONAL AT ALL TIMES. AIRPORT OPERATIONS SHALL NOT BE INTERRUPTED BY CONSTRUCTION ACTIVITIES AT ANY TIME.
- 3. BARRICADES MUST BE INSTALLED AT THE LOCATIONS SHOWN ON THE PLAN THROUGH COORDINATION WITH THE RPR. LOCATIONS ARE SUBJECT TO RELOCATION UPON REQUEST FROM AIRPORT OR RPR TO ENSURE ACCESS TO ALL AIRPORT TENANTS. BARRICADES MUST BE INSTALLED AT THE BEGINNING OF EACH PHASE AND REMAIN IN PLACE THROUGHOUT THE
- 4. COSTS ASSOCIATED WITH PLACING AND MAINTAINING BARRICADES AND CLOSURES WILL BE INCLUDED IN PAY ITEM C-105 "MOBILIZATION".
- 5. CONTRACTOR MUST SUBMIT CONSTRUCTION SEQUENCING PLAN TO BE REVIEWED BEFORE CONSTRUCTION START.
- 6. TEMPORARY LOW-PROFILE BARRICADES ARE ADDITIONAL BARRICADES TO BE PLACED WHEN WORKING IN CRITICAL WORK AREAS. CONTRACTOR TO COORDINATE WITH GFIAA AIRPORT OPERATIONS ON EXACT LOCATION AND POSITION OF TEMPORARY LOW-PROFILE BARRICADES. CONTRACTOR SHALL NOT PLACE ANY TEMPORARY BARRICADES WITHOUT EXPLICIT DIRECTION FROM GFIAA NOR WITHOUT AN ESCORT FROM GFIAA AIRPORT OPERATIONS. TEMPORARY BARRICADES SHALL BE REMOVED AFTER WORK IS COMPLETED IN EACH CRITICAL WORK AREA.
- 7. CONTRACTOR SHALL PROVIDE FULL-TIME FLAGGER DURING CONSTRUCTION. FLAGGER MUST BE TRAINED BY GFIAA IN ADVANCE OF CONSTRUCTION NTP.
- APRON TO TAXIWAY D MUST REMAIN OPEN FOR AIRPORT OPERATIONS
- 2. AT LEAST ONE TAXIWAY FROM THE FEDEX APRON TO TAXIWAY D MUST REMAIN OPEN FOR AIRPORT OPERATIONS AT ALL TIME.
- (3.) REPLACEMENT OF ALL HOMERUN CIRCUITS SHALL BE COMPLETED IN ONE SINGULAR OPERATION. CONTRACTOR MAY CHOOSE THE APPROPRIATE PHASE TO REPLACE HOMERUN CIRCUITS IN COORDINATION WITH AIRPORT AND ENGINEER.

- REMOVAL OF TAXIWAY EDGE LIGHTING AND
- RELATED CIRCUITS - INSTALLATION OF TAXIWAY EDGE LIGHTING AND RELATED CIRCUITS
- REPLACE ISOLATION TRANSFORMERS IN EXISTING SIGNS

AIRFIELD CLOSURES

- TAXIWAY D CLOSED EAST OF RUNWAY 17/35
- TAXIWAY D1 CLOSED
- TAXIWAY P CLOSED NORTH OF TAXIWAY A
- TAXIWAY L CLOSED BETWEEN TAXIWAY A AND
- TAXIWAY N INCLUDING TAXIWAY N INTERSECTION - TERMINAL APRON - ROTATING DAYTIME CLOSURES
- RUNWAY 8R/26L OFF PEAK CLOSURES - RUNWAY 17/35 - OFF PEAK CLOSURES

PHASE 3 LIMITS | PHASE 3 CRITICAL WORK AREA WORK AREA FOR HOMERUN CIRCUIT REPLACEMENT - SEE NOTE 3 HAUL ROUTE LOW-PROFILE BARRICADES - NUMBER

PHASE 2 LIMITS | PHASE 2 CRITICAL WORK AREA

DENOTES PHASE TEMPORARY LOW-PROFILE BARRICADES - NUMBER DENOTES PHASE

TAXIWAY OBJECT FREE AREA ----- TOFA -----

----- RSA -----

CONSTRUCTION FLAGGER - SEE NOTE 7

TAXIWAY CLOSURE MARKER

RUNWAY SAFETY AREA

NORTH

SCALE IN FEET

1-800-482-7171

RS&H Michigan, Inc.

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GERALD R. FORD INTERNATIONAL **AIRPORT**

TAXIWAY D

LIGHTING REHABILITATION

REVISIONS NO. DESCRIPTION DATE DATE ISSUED: MAY 2025 REVIEWED BY: MAR

RS&H PROJECT NUMBER

1010-5865-001

DRAWN BY: SCR

DESIGNED BY: SCR

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SHEET TITLE

CONSTRUCTION **PHASING PLAN -**PHASE 3

SHEET NUMBER

G033

ISSUED FOR BID

KEYED NOTES:

1. AT LEAST ONE TAXIWAY FROM THE CORPORATE AND TERMINAL AT ALL TIME. BARRICADES TO BE REMOVED/RELOCATED AS NEEDED.

SAFETY:

- 1. THE CONTRACTOR MUST ACQUAINT HIS SUPERVISORS AND EMPLOYEES WITH THE AIRPORT ACTIVITY AND OPERATIONS THAT ARE INHERENT TO THIS AIRPORT AND CONDUCT THE CONSTRUCTION ACTIVITIES TO CONFORM TO ALL ROUTINE AND EMERGENCY REQUIREMENTS AND GUIDELINES ON SAFETY AS SPECIFIED IN NOTE NO. 4 BELOW. ALL CONTRACTOR CONSTRUCTION COMMUNICATIONS WITH GERALD R. FORD INTERNATIONAL AIRPORT AUTHORITY (GFIAA) OPERATIONS OR ADMINISTRATION MUST BE VIA AIRPORT COMMUNICATIONS, 616-233-6000 OR AS DIRECTED BY GFIAA STAFF. THIS NUMBER SHOULD BE USED IN CASE OF EMERGENCIES AS WELL. CONTRACTOR MUST PROVIDE GFIAA AND THE ENGINEER WITH A CONTACT NUMBER FOR THE ON-SITE SUPERVISOR THAT CAN BE REACHED 24 HOURS A DAY, SEVEN DAYS A WEEK. THE SUPERVISOR SHALL HAVE AUTHORITY TO MAKE DECISIONS IN RESOLVING ANY EMERGENCY OR OTHER ISSUES.
- 2. OPEN FLAME WELDING OR TORCH CUTTING OPERATIONS ARE PROHIBITED UNLESS ADEQUATE FIRE AND SAFETY PRECAUTIONS HAVE BEEN TAKEN AND THE PROCEDURE IS APPROVED AND A HOT WORK PERMIT IS OBTAINED FROM GFIAA.
- 3. DEBRIS, WASTE, AND LOOSE MATERIAL CAPABLE OF CAUSING DAMAGE TO AIRCRAFT ARE NOT ALLOWED ON ACTIVE AIRCRAFT OPERATING SURFACES. IF THESE MATERIALS ARE OBSERVED TO BE ON ACTIVE AIRCRAFT OPERATING SURFACES, THE CONTRACTOR MUST INFORM GFIAA OPERATIONS IMMEDIATELY. DEBRIS, WASTE, AND LOOSE MATERIAL WILL BE REMOVED IMMEDIATELY AND/OR CONTINUOUSLY DURING CONSTRUCTION BY USE OF VACUUM TRUCK (SEE SAFETY NOTE 6 BELOW).
- 4. THE CONTRACTOR IS DIRECTED TO COMPLY WITH AND ACQUAINT HIS/HER EMPLOYEES WITH THE FOLLOWING SAFETY GUIDELINES, RELATED MATERIALS AND FAA ADVISORY CIRCULARS:

150/5370-G "OPERATIONAL SAFETY ON AIRPORTS DURING CONSTRUCTION"

GERALD R. FORD INTERNATIONAL AIRPORT RULES AND REGULATIONS

COPIES OF THESE DOCUMENTS ARE AVAILABLE ONLINE AT HTTP://WWW.FAA.GOV/AIRPORTS/RESOURCES/ADVISORY_CIRCULARS/ AND HTTPS://WWW.GRR.ORG/HUBFS/PDFS/RULES%26REGS2019.PDF?HSLANG=EN

- 5. CONSTRUCTION DURING THE PROJECT MAY BE HALTED AT ANY TIME BY THE ENGINEER IF IT IS DETERMINED TO BE IN THE BEST INTEREST OF AIRPORT OPERATIONS OR SAFETY. THE CONTRACTOR MAY BE DIRECTED TO REMOVE EQUIPMENT AND/OR EVACUATE THE SITE. NECESSARY EXTENSIONS IN CONTRACT TIME WILL BE GRANTED OR A STOP WORK ORDER WILL BE ISSUED DUE TO THESE DELAYS. HOWEVER, THERE WILL BE NO ADJUSTMENTS IN CONTRACT COST DUE TO THESE DELAYS.
- 6. THE CONTRACTOR SHALL PROVIDE A FULLY OPERATIONAL, SELF-CONTAINING VACUUM TRUCK. THE VACUUM TRUCK MUST BE AVAILABLE FOR THE DURATION OF THE PROJECT AND WITH AN OPERATOR AT THE DISCRETION OF THE ENGINEER TO VACUUM PAVEMENT AREAS ADJACENT TO THE CONSTRUCTION AREAS TO ENSURE NO FOREIGN OBJECT DEBRIS IS PRESENT ON PAVEMENTS WITHIN 500 FEET OF ANY CONSTRUCTION AREA. THE COST OF THE VACUUM TRUCK MUST BE INCLUDED IN THE SAFETY AND SECURITY BID ITEM.
- 7. FAILURE TO COMPLY WITH ANY OF THE SAFETY AND SECURITY REQUIREMENTS MAY RESULT IN ANY OR ALL OF THE FOLLOWING ACTIONS:
 - PROJECT SHUT DOWN
 - REMOVAL FROM AIRPORT (PERSONNEL AND/OR EQUIPMENT)
 - FINES, IN ACCORDANCE WITH AIRPORT RULES AND REGULATIONS
- 8. THE CONTRACTOR'S EQUIPMENT STORAGE AREA MUST BE WITHIN THE CONSTRUCTION SITE OR WITHIN THE STAGING AREA AS SHOWN ON THE CONTRACT LAYOUT. THE CONTRACTOR'S EQUIPMENT AND CONSTRUCTION VEHICLES ARE RESTRICTED TO THE CONSTRUCTION SITE OR STORAGE AREAS DURING CONSTRUCTION AND PARKED IN THE STAGING AREA DURING NON-WORKING PERIODS. EQUIPMENT HEIGHT MUST NOT EXCEED 25 FEET. EQUIPMENT HEIGHT MUST NOT EXCEED 20 FEET WHILE STORED IN THE EQUIPMENT STORAGE AREA.

SECURITY:

1. ACCESS TO THE SITE: CONTRACTOR'S ACCESS TO THE SITE MUST BE AS SHOWN ON THE PLANS. NO OTHER ACCESS POINTS ARE ALLOWED UNLESS APPROVED BY GFIAA. ALL CONTRACTOR TRAFFIC AUTHORIZED TO ENTER THE SITE MUST BE EXPERIENCED IN THE ROUTE OR GUIDED BY CONTRACTOR PERSONNEL. THE CONTRACTOR IS RESPONSIBLE FOR TRAFFIC CONTROL TO AND FROM THE VARIOUS CONSTRUCTION AREAS ON THE SITE, AND FOR THE OPERATION AND SECURITY OF ACCESS TO THE SITE. A CONTRACTOR'S FLAGPERSON OR TRAFFIC CONTROL PERSON MUST MONITOR AND COORDINATE ALL CONTRACTOR TRAFFIC AT THE ACCESS POINT.

THE CONTRACTOR MUST NOT PERMIT ANY UNAUTHORIZED CONSTRUCTION PERSONNEL OR TRAFFIC ON THE SITE. ACCESS POINTS TO THE SITE MUST BE SECURED AND LOCKED AT ALL TIMES WHEN NOT ATTENDED BY THE CONTRACTOR. THE GATE OR GATE ARM MUST BE CLOSED AFTER EACH ACCESS. THE GATE GUARD MUST BE PROFESSIONALLY TRAINED AND MUST MAINTAIN A CONTRACTOR VEHICLE "ACTIVITY LOG" AS SUPPLIED BY THE OWNER. GATE GUARDS MUST HAVE AN APPROPRIATE MEANS OF COMMUNICATION TO CONTACT ADDITIONAL GATE MONITORS TO PROVIDE FOR BATHROOM, LUNCH AND OTHER BREAK PERIODS. AT NO TIME CAN THE GATE GUARD LEAVE THE UNSECURED GATE UNATTENDED WITHOUT AN APPROPRIATELY TRAINED SUBSTITUTE GUARD.

THE CONTRACTOR IS RESPONSIBLE FOR THE IMMEDIATE CLEANUP OF ANY DEBRIS DEPOSITED ALONG THE ACCESS ROUTE AS A RESULT OF HIS CONSTRUCTION TRAFFIC. DIRECTIONAL SIGNING FROM THE ACCESS POINT ALONG THE DELIVERY ROUTE TO THE STORAGE AREA OR WORK SITE ARE AS DIRECTED BY GFIAA.

- 2. <u>MATERIAL DELIVERY TO THE SITE:</u> ALL CONTRACTOR'S MATERIAL ORDERS FOR DELIVERY TO THE WORK SITE WILL USE, AS A DELIVERY ADDRESS, THE STREET NAME ASSIGNED TO THE ACCESS POINT AT THE CONTRACTOR'S STAGING SITE AT THE AIRPORT. DELIVERIES MUST REFERENCE THE PROJECT NAME AND CONTRACTOR'S NAME. THIS CONSTRUCTION ADDRESS WILL BE DETERMINED AT THE PRE-CONSTRUCTION MEETING.
- 3. CONSTRUCTION AREA LIMITS: THE LIMITS OF CONSTRUCTION, MATERIAL STORAGE AREAS, EQUIPMENT STORAGE AREA, PARKING AREA AND OTHER AREAS DEFINED AS REQUIRED FOR THE CONTRACTOR'S EXCLUSIVE USE DURING CONSTRUCTION MUST BE MARKED BY THE CONTRACTOR. THE CONTRACTOR MUST ERECT AND MAINTAIN AROUND THE PERIMETER OF THESE AREAS SUITABLE FENCING, MARKING AND/OR WARNING DEVICES VISIBLE FOR DAY/NIGHT USE. TEMPORARY BARRICADES, FLAGGING AND FLASHING WARNING LIGHTS WILL BE REQUIRED AT CRITICAL ACCESS POINTS. TYPE OF MARKING AND WARNING DEVICES MUST BE APPROVED BY THE GFIAA, THROUGH THE ENGINEER.
- 4. <u>SUPERVISION:</u> CONTRACTOR MUST, AT ALL TIMES, HAVE A SUPERVISOR ON SITE DURING ALL OPERATIONS INCLUDING ALL SUBCONTRACTOR OPERATIONS.
- 5. <u>IDENTIFICATION VEHICLES:</u> THE CONTRACTOR MUST ESTABLISH AND MAINTAIN A LIST OF CONTRACTOR AND SUBCONTRACTOR VEHICLES AUTHORIZED TO OPERATE ON THE SITE WHICH MUST BE MADE AVAILABLE UPON DEMAND BY THE ENGINEER OR GFIAA. EACH VEHICLE MUST DISPLAY A LARGE COMPANY SIGN ON BOTH SIDES OF THE VEHICLE. THE CONTRACTOR MUST PROVIDE THE GFIAA THROUGH THE ENGINEER, WITH A CURRENT LIST OF COMPANIES AUTHORIZED TO ENTER AND CONDUCT WORK ON THE AIRPORT. CONTRACTOR EMPLOYEE VEHICLES WILL BE RESTRICTED TO THE CONTRACTOR'S EMPLOYEE PARKING AREA AS DESIGNATED ON THE PLANS.
- 6. <u>FINES</u>: PAYMENT OF ALL FINES ASSESSED TO GFIAA DUE TO FAA OR TSA VIOLATIONS BY THE CONTRACTOR WILL BE THE SOLE RESPONSIBILITY OF THE CONTRACTOR. SUCH FINES WILL BE DEDUCTED FROM THE CONTRACT VIA CHANGE ORDER.

PROJECT SAFETY NARRATIVE:


- 1. THERE IS CONSTRUCTION ACTIVITY ANTICIPATED WITHIN THE AIRPORT OPERATIONS AREA (AOA). REFER TO SHEET G030 FOR ANTICIPATED AIRFIELD CLOSURES.
- 2. BASIS FOR DEVIATING FROM STANDARDS: NOT APPLICABLE.
- 3. HEIGHT OF CONSTRUCTION EQUIPMENT: 25 FEET (ANY TYPE)*

*- FAA APPROVAL MUST BE OBTAINED FOR ANY CONSTRUCTION EQUIPMENT EXPECTED TO EXCEED 15 FEET, BEFORE THE EQUIPMENT IS ALLOWED ON THE CONSTRUCTION SITE.

4. DATES FOR START AND COMPLETION:

ESTIMATED START: AUGUST 2025 ESTIMATED COMPLETE: OCTOBER 2025

TOTAL CONTRACT TIME: REFER TO SHEET G030 - CONSTRUCTION PHASING PLAN

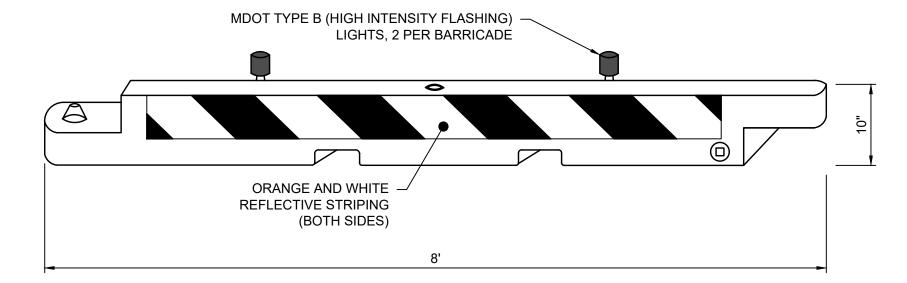


NOTES:

- ALL COSTS RELATED TO THE INSTALLATION, MAINTENANCE, REMOVAL, AND/OR RELOCATION OF BARRICADES SHALL BE INCLUDED IN ITEM G-102-11.1, "SAFETY AND SECURITY".
- 2. BARRICADES SHALL BE AR-10x96 LOW-PROFILE BARRICADES (MANUFACTURED BY MULTI-BARRIER), OR APPROVED EQUAL. WEIGH DOWN EACH BARRICADE BY FILLING WITH WATER.
- 3. BARRICADES SHALL BE PLACED AROUND ALL PAVEMENT DROP-OFFS AND IN AREAS IDENTIFIED ON THE PHASING PLAN.
- 4. PLACE BARRICADES INTERLOCKED ON PAVED SURFACES AND A MAXIMUM OF 50 FT. APART IN TURF AREAS UNLESS OTHERWISE NOTED. BARRICADES SHOULD ALTERNATE COLORS, ORANGE AND WHITE.



LOW-PROFILE BARRICADE


SCALE: N.T.S

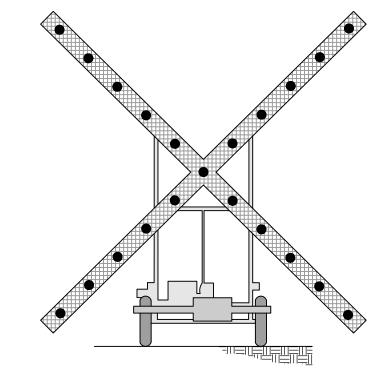

NOTES:

- 1. LIGHTED RUNWAY CLOSURE MARKERS (LIGHTED X'S) MUST BE PLACED ON EACH RUNWAY END FACING THE RUNWAY APPROACH WHENEVER A RUNWAY IS CLOSED. PLACE RUNWAY CLOSURE MARKER ON OR AS NEAR AS PRACTICAL TO THE RUNWAY DESIGNATION MARKING.
- 2. CONTRACTOR SHALL FURNISH AND INSTALL TWO LIGHTED RUNWAY CLOSURE MARKERS AT BOTH ENDS OF RUNWAY 8R-26L DURING CLOSURES. THE CONTRACTOR WILL BE RESPONSIBLE FOR THE TRANSPORT, PLACEMENT, AND REMOVAL OF THE LIGHTED RUNWAY CLOSURE MARKERS AT THE DIRECTION OF THE OWNER AND/OR ENGINEER. THE CONTRACTOR WILL BE RESPONSIBLE FOR THE OPERATION AND MAINTENANCE OF THE LIGHTED RUNWAY CLOSURE MARKERS WHILE IN THE CONTRACTOR'S USE. THE CONTRACTOR IS REQUIRED TO PROVIDE ALL FUEL, OIL, BULBS, FILTERS, AND ANY ADDITIONAL REPLACEMENT PARTS TO KEEP THE RUNWAY CLOSURE MARKERS IN WORKING ORDER.
- 3. A RECEPTACLE MUST BE PLACED AND SECURED UNDER THE LIGHTED RUNWAY CLOSURE MARKERS CAPABLE OF HOLDING SPILLED GASOLINE AND OIL. ANY MATERIAL SPILLED ON PAVEMENT MUST BE CLEANED IMMEDIATELY AT NO ADDITIONAL EXPENSE TO THE OWNER.
- 4. UNDER NO CIRCUMSTANCE WILL THE CONTRACTOR BE PERMITTED TO SET UP OR REMOVE LIGHTED X'S WITHOUT OWNER OR ENGINEER AUTHORIZATION.
- 5. LIGHTED X'S MUST COMPLY WITH FAA AC 150/5345-55 AND FAA AC 150-5370-2.



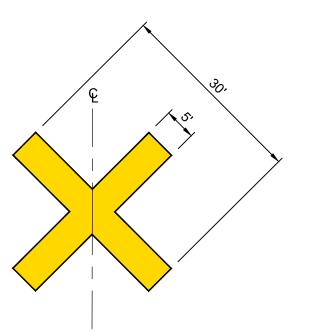

NOTES:

- 1. ALL COSTS RELATED TO THE INSTALLATION, MAINTENANCE, REMOVAL, AND/OR RELOCATION OF TAXIWAY CLOSURE MARKERS SHALL BE INCLUDED IN ITEM G-102, "SAFETY AND SECURITY".
- 2. MARKER SHALL BE YELLOW AND CONSTRUCTED OF MATERIAL APPROVED BY THE OWNER AND ENGINEER. TEMPORARY PAINT WILL NOT BE ALLOWED.
- 3. TEMPORARY MARKER MATERIAL SHALL BE SECURELY ANCHORED TO THE PAVEMENT TO PREVENT DISLOCATION BY WIND OF JET/PROP BLAST. CONTRACTOR SHALL REPAIR PAVEMENT DAMAGED DURING ANY ANCHORING OF CLOSURE MARKERS.
- 4. THE CONTRACTOR SHALL COORDINATE THE EXACT PLACEMENT AND LOCATION OF ALL TAXIWAY CLOSURE MARKERS WITH THE ENGINEER AND AIRPORT OPERATIONS.





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GERALD R. FORD INTERNATIONAL AIRPORT

TAXIWAY D LIGHTING REHABILITATION



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RS&H PROJECT NUMBER 1010-5865-001

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SHEET TITLE

SAFETY AND SECURITY NOTES AND DETAILS

SHEET NUMBER

G040

GENERAL ELECTRICAL NOTES:

- ALL ELECTRICAL WORK SHALL BE IN ACCORDANCE WITH THE LATEST ADOPTED VERSION OF THE NATIONAL ELECTRICAL CODE. THE NATIONAL ELECTRICAL SAFETY CODE, FAA ADVISORY CIRCULARS AND ORDERS, AND APPLICABLE LOCAL BUILDING CODES, LAWS AND ORDINANCES.
- THE CONTRACTOR SHALL OBTAIN AND PAY FOR ALL REQUIRED PERMITS, LICENSES, INSPECTIONS, FEES, AND APPROVALS.
- 3. THE CONTRACTOR SHALL PROVIDE ALL LABOR, MATERIALS, AND EQUIPMENT TO REMOVE, RELOCATE, MODIFY, AND INSTALL THE ELECTRICAL SYSTEMS AS INDICATED ON THE DRAWINGS. ITEMS NOT SHOWN, BUT NECESSARY FOR COMPLETION OF THE WORK, SHALL BE INCLUDED.
- 4. ALL ITEMS ARE NEW UNLESS SPECIFICALLY NOTED OTHERWISE. NEW MATERIALS SHALL BE U.L. LISTED.
- ALL MATERIALS SCHEDULED FOR REMOVAL SUCH AS EXISTING CONSTANT CURRENT REGULATORS, LIGHTS, COVERS, TRANSFORMERS, ETC. AND WHICH ARE DEEMED SALVAGEABLE BY THE AIRPORT, SHALL BE DELIVERED TO THE LOCATION ON AIRPORT PROPERTY AS INDICATED BY THE OWNER'S REPRESENTATIVE. ALL NON-SALVAGEABLE MATERIALS REMOVED SUCH AS STRUCTURES, CONCRETE FOUNDATIONS, CABLE, CONDUIT, LIGHT BASES, ETC. SHALL BE REMOVED FROM THE SITE AND LEGALLY DISPOSED OF BY THE CONTRACTOR IN ACCORDANCE WITH APPLICABLE LAWS AND ENVIRONMENTAL REGULATIONS.
- 6. THE LOCATIONS OF UTILITIES, DUCT BANKS, AND CONDUITS SHOWN ON THE PLANS ARE APPROXIMATE AND SHALL NOT BE SCALED FOR EXACT LOCATIONS. ALL UTILITIES MIGHT NOT BE SHOWN. IT SHALL BE THE RESPONSIBILITY OF THE CONTRACTOR TO CONTACT THE APPROPRIATE UTILITY/AGENCY PRIOR TO STARTING WORK FOR THE LOCATION OF EXISTING UTILITIES AND TO ALLOW THEM TIME TO PROPERLY LOCATE ALL UTILITIES. ANY INTERRUPTION OF AN EXISTING SYSTEM OR UTILITY SERVICE SHALL BE COORDINATED AND APPROVED BY THE AUTHORITY, AGENCY, OR UTILITY HAVING JURISDICTION.
- ALL EXISTING SYSTEMS AND UTILITIES TO REMAIN SHALL BE PROTECTED FROM DAMAGE. THE CONTRACTOR SHALL BE RESPONSIBLE FOR ANY DAMAGED SYSTEM OR UTILITY AND SHALL REPLACE OR MAKE REPAIRS IMMEDIATELY, AT THEIR OWN EXPENSE, IN ACCORDANCE WITH THE AUTHORITY, AGENCY, OR UTILITY HAVING JURISDICTION. DAMAGED SYSTEMS OR UTILITIES SHALL BE IMMEDIATELY REPORTED TO THE OWNER'S REPRESENTATIVE.
- PRIOR TO START OF CONSTRUCTION, CONTRACTOR SHALL IDENTIFY THE ROUTING OF AIRFIELD LIGHTING CIRCUITS #12, #16 AND #17 THROUGH THE VAULT, DUCTBANKS, IN MANHOLES, HANDHOLES, AND IN CONDUITS. EXACT ROUTING SHALL BE DOCUMENTED AND PROVIDED TO THE AIRPORT AND ENGINEER PRIOR TO START OF CONSTRUCTION. THE CONTRACTOR SHALL UTILIZE A LOCATE SERVICE, AS WELL AS HAVE A CABLE TRACER AVAILABLE, TO LOCATE EXISTING CABLES. ALL EXCAVATION WITHIN FOUR FEET OF ANY UNDERGROUND UTILITY TO REMAIN SHALL BE PERFORMED BY HAND DIGGING METHODS.
- THE IDENTITY AND ROUTING OF ALL CABLES SHOWN ON THE PLANS SHALL BE VERIFIED IN THE FIELD. ANY DISCREPANCY SHALL BE BROUGHT TO THE ATTENTION OF THE OWNER'S REPRESENTATIVE AND RECORDED IN THE AS-BUILT DRAWINGS TO PROVIDE AN ACCURATE RECORD OF CONDITIONS. THESE PLANS DO NOT PURPORT TO SHOW ALL EXISTING CABLES AND CONCEALED UTILITIES WHICH WILL REQUIRE STAKE OUT PRIOR TO CONSTRUCTION. CONTRACTOR SHALL VERIFY EXISTING CIRCUIT ROUTING PRIOR TO COMMENCING WORK.
- 10. DEWATERING FOR ENTRANCE INTO OR FOR THE INSTALLATION OF STRUCTURES, FOUNDATIONS, DUCT BANKS, AND CONDUIT IS INCIDENTAL TO THE RESPECTIVE PAY ITEM. THE CONTRACTOR SHALL BE RESPONSIBLE TO PAY FOR AND OBTAIN ANY AND ALL PERMITS REQUIRED FOR DEWATERING.
- 11. THE PROJECT PAY ITEMS PROVIDED ARE INCLUSIVE OF ALL WORK TO BE PERFORMED AS SHOWN IN THE PLANS. ALL WORK IDENTIFIED WITH A SPECIFIC PAY ITEM SHALL BE CONSIDERED REQUIRED WORK TO COMPLETE THE PROJECT AND IS SUBSIDIARY TO THE COST OF THE RESPECTIVE PROJECT PAY ITEM.
- 12. ITEMS SHOWN SCREENED (LIGHT) ARE EXISTING ITEMS AND ITEMS SHOWN IN SOLID (BOLD) ARE ITEMS TO BE MODIFIED. REMOVED. OR INSTALLED UNDER THIS CONTRACT UNLESS NOTED OTHERWISE.
- 13. AT THE END OF EACH SHIFT, IT SHALL BE THE CONTRACTOR'S RESPONSIBILITY TO DETERMINE THAT ALL AIRFIELD LIGHTING CIRCUITS (EXCEPT THOSE SERVING CLOSED TAXIWAYS OR RUNWAYS) ARE OPERATIONAL USING TOWER CONTROLS. CONTROL FROM VAULT WILL BE ALLOWED ONLY WHEN NECESSARY DURING THE TIE-IN OF THE NEW CONSTANT CURRENT REGULATORS (CCRs) TO THE EXISTING ALCMS AND UPON ADVANCE WRITTEN AGREEMENT WITH THE RPR, AIRPORT, AND TOWER. ADVANCE NOTICE TIMEFRAME SHALL BE DETERMINED WITH ALL PARTIES. CONTRACTOR SHALL CERTIFY TO THE OWNER'S REPRESENTATIVE BEFORE LEAVING THE PROJECT SITE EACH DAY. ALL INOPERABLE CIRCUITS REQUIRED FOR THE OPERATION OF THE AIRPORT SHALL BE IMMEDIATELY RESTORED. THE CONTRACTOR SHALL BE RESPONSIBLE FOR ALL COSTS, INCLUDING REPAIRS MADE BY AIRPORT PERSONNEL, ASSOCIATED WITH RESTORATION OF CIRCUITS.
- CONTRACTOR SHALL PROVIDE ANY TEMPORARY SPLICES, CONDUITS, JUMPER WIRING, OR ANY OTHER ITEMS NECESSARY TO KEEP EXISTING CIRCUITS OPERATIONAL DURING CONSTRUCTION. THESE ITEMS SHALL BE CONSIDERED INCIDENTAL TO THE INSTALLATION OF THE NEW L-824, 5KV WIRING.

- 15. THE CONTRACTOR SHALL COORDINATE ALL WORK WITH THE SAFETY AND PHASING PLANS.
- 16. THE CONTRACTOR SHALL COMPLY WITH THE AIRPORT MAINTENANCE "LOCK-OUT/TAG-OUT" PROCEDURES AND NFPA 70E.
- 17. FOR ANY LIGHT FIXTURE, SIGN, OR STRUCTURE INSTALLED OR RELOCATED UNDER THIS CONTRACT, THE CONTRACTOR SHALL OBTAIN THE EXACT LOCATION VIA SURVEY. THE LOCATION SHALL BE APPROVED BY THE OWNER'S REPRESENTATIVE PRIOR TO INSTALLATION.
- 18. THE CONTRACTOR SHALL CONDUCT INSULATION RESISTANCE TO GROUND (MEGGER) TESTS ON ALL AIRFIELD LIGHTING CIRCUITS BEFORE COMMENCING WORK ON ANY CIRCUITS. THE CONTRACTOR SHALL PREPARE AND PROVIDE TO THE OWNER'S REPRESENTATIVE A WRITTEN REPORT, BY CIRCUIT, OF THESE RESULTS. THE CONTRACTOR SHALL REPEAT THIS TEST ON EACH CIRCUIT AFTER COMPLETION OF THE WORK. RESULTS OF BOTH TESTS SHALL BE PROVIDED TO THE OWNER'S REPRESENTATIVE. WEATHER CONDITIONS SHALL BE INCLUDED IN THE WRITTEN REPORT. ANY CIRCUITS NOT BEING REPLACED UNDER THIS CONTRACT THAT EXHIBIT LOWER TEST RESULTS DURING FINAL TESTING SHALL BE REPAIRED UNTIL TESTS RESULTS MEET OR EXCEED ORIGINAL TEST RESULTS.
- 19. WHEN PREPARING RECORD DRAWINGS, ALL ITEMS SHALL BE SHOWN IN THEIR ACTUAL INSTALLED LOCATIONS. ALL UNDERGROUND DUCTS, CONDUITS, DRAINS, GROUND GRIDS, FORCE MAINS, ETC. (ALL UNDERGROUND UTILITIES) INSTALLED BY THE CONTRACTOR OR LOCATED BY THE CONTRACTOR DURING CONSTRUCTION OF THIS PROJECT SHALL BE SURVEYED. THE DATA SHALL BE SUFFICIENTLY ACCURATE TO LOCATE THE UTILITY AT A LATER DATE. THE DATA SHALL INCLUDE NORTH-SOUTH AND EAST-WEST COORDINATES AND AN ELEVATION. ALL STRUCTURES INSTALLED BY THE CONTRACTOR SHALL BE SURVEYED. THE CENTER OF THE STRUCTURE SHALL BE LOCATED BY A NORTH-SOUTH AND EAST-WEST COORDINATE AND AN ELEVATION. CONTRACTOR SHALL EDIT THE EQUIPMENT SCHEDULES TO REFLECT ITEMS ACTUALLY FURNISHED. AT THE END OF THE PROJECT, ALL CHANGES SHALL BE TRANSFERRED TO A SET OF REPRODUCIBLE DESIGN DRAWINGS MARKED "AS-BUILT" AND DATED AND STAMPED BY THE ELECTRICAL CONTRACTOR.
- 20. WHEN ENTERING EXISTING MANHOLES OR STRUCTURES, CONTRACTOR SHALL FOLLOW AIRPORT OR CONTRACTOR CONFINED SPACE REQUIREMENTS. REQUIREMENTS SHALL BE PROVIDED TO THE OWNER AND ENGINEER.
- 21. ONLY THIRD PARTY CERTIFIED MANUFACTURERS, LISTED IN AC 150/5345-53, APPENDIX 3 ADDENDUM (AS REQUIRED) AND MEETING THE BUY AMERICAN PREFERENCE REQUIREMENTS CAN PROVIDE EQUIPMENT AND MATERIALS SPECIFIED IN THE CONTRACT DOCUMENTS. DOCUMENTATION CERTIFYING COMPLIANCE WITH THE BUY AMERICAN PREFERENCE RULES FOR AIRPORT IMPROVEMENT PROGRAM (AIP) CITED IN 49 USC §50101 SHALL BE INCLUDED WITH EACH EQUIPMENT AND MATERIAL SUBMITTAL.
- 22. A MINIMUM OF THREE COPIES OF INSTRUCTION BOOKS MUST BE SUPPLIED WITH EACH TYPE OF EQUIPMENT. FOR MORE SOPHISTICATED TYPES OF EQUIPMENT SUCH AS REGULATORS, PAPI, REIL, ETC., THE INSTRUCTION BOOK MUST CONTAIN THE FOLLOWING:
 - A. A DETAILED DESCRIPTION OF THE OVERALL EQUIPMENT
 - AND ITS INDIVIDUAL COMPONENTS. B. THEORY OF OPERATION INCLUDING THE FUNCTION OF
 - EACH COMPONENT.
 - C. INSTALLATION INSTRUCTIONS.
 - START-UP INSTRUCTIONS.
 - PREVENTATIVE MAINTENANCE REQUIREMENTS. CHART FOR TROUBLESHOOTING.
 - G. COMPLETE POWER AND CONTROL DETAILED WIRING DIAGRAM(S), SHOWING EACH CONDUCTOR/CONNECTION/COMPONENT; "BLACK" BOXES ARE NOT ACCEPTABLE. THE DIAGRAM OR THE NARRATIVE MUST SHOW VOLTAGES/CURRENT/WAVE SHAPES AT STRATEGIC LOCATIONS TO BE USED WHEN CHECKING AND/OR TROUBLESHOOTING THE EQUIPMENT. WHEN THE EQUIPMENT HAS SEVERAL BRIGHTNESS STEPS. THESE PARAMETERS MUST BE INDICATED FOR ALL THE
 - DIFFERENT MODES. H. PARTS LIST WILL INCLUDE ALL MAJOR AND MINOR COMPONENTS, SUCH AS RESISTORS, DIODES, ETC. IT MUST INCLUDE A COMPLETE NOMENCLATURE OF EACH COMPONENT AND, IF APPLICABLE, THE NAME OF ITS MANUFACTURER AND THE CATALOG NUMBER.
 - I. SAFETY INSTRUCTIONS.

GROUNDING NOTES:

- GROUND ALL NON-CURRENT-CARRYING METAL PARTS OF ELECTRICAL EQUIPMENT BY USING CONDUCTORS SIZED AND ROUTED PER NFPA 70 (NEC), ARTICLE 250.
- ALL GROUND CONNECTIONS TO BUSSES, PANELS, ETC., SHALL BE MADE WITH PRESSURE TYPE SOLDERLESS LUGS AND GROUND CLAMPS. SOLDERED OR BOLT AND WASHER TYPE CONNECTIONS ARE NOT ACCEPTABLE. CLEAN ALL METAL SURFACES BEFORE MAKING GROUND CONNECTIONS. EXOTHERMIC WELDS ARE REQUIRED FOR CONNECTION TO A GROUND ROD.
- 3. THE RESISTANCE TO GROUND OF THE VAULT GROUNDING SYSTEM WITH THE COMMERCIAL POWER LINE NEUTRAL DISCONNECTED SHALL NOT EXCEED 10 OHMS.
- 4. THE RESISTANCE TO GROUND OF THE COUNTERPOISE SYSTEM, OR AT ISOLATED LOCATIONS, SUCH AS AIRPORT BEACON, SHALL NOT EXCEED 25 OHMS.

SPARE PARTS NOTES:

ITEM TYPE

ELEVATED FIXTURES

MISCELLANEOUS

- 1. THE SPARE PARTS TABLE ON THIS SHEET LISTS THE ELECTRICAL SPARE PARTS REQUIRED TO BE FURNISHED BY THE CONTRACTOR. ALL SPARE PARTS SHALL BE IDENTICAL TO THE SAME PARTS APPROVED AND INSTALLED ON THE PROJECT.
- 2. THE QUANTITY OF SPARE PARTS PROVIDED SHALL BE A MINIMUM OF 10% OF THE QUANTITY REQUIRED BY THE PROJECT TO BE INSTALLED, PROVIDED THAT THE COST DOES NOT EXCEED 10% OF THE COST THE VISUAL AID FOR WHICH THEY ARE REQUIRED. ADDITIONALLY, THE TOTAL COST OF ALL SPARE PARTS MUST NOT EXCEED \$10.000. THE COST OF ALL DEFINED SPARE PARTS TO BE FURNISHED TO THE OWNER MUST BE INCLUDED IN THE VARIOUS UNIT BID ITEMS FOR WHICH THE SPARE PARTS ARE PROVIDED.
- 3. CONTRACTOR TO PROVIDE A SHOP DRAWING SUBMITTAL LISTING THE SPARE PARTS TO BE PROVIDED FOR EACH ITEM BASED UPON THE MANUFACTURER'S RECOMMENDED SPARE PARTS. THIS SUBMITTAL SHALL INCLUDE THE MANUFACTURER PART NUMBERS FOR EACH SPARE PART AND WHICH ITEM IT PERTAINS TO ALONG WITH THE QUANTITY TO BE PROVIDED.
- 4. SPARE PARTS SHALL BE DELIVERED TO A LOCATION ON THE AIRPORT DESIGNATED BY THE AIRPORT. SPARE PARTS SHALL BE PROTECTED FROM THE ELEMENTS. SUCH PROTECTION SHALL INCLUDE THE USE OF HEAT LAMPS, SUITABLE COVERINGS, INDOOR STORAGE, ETC. TO PROPERLY STORE THE SPARE PARTS. ANY SPARE PARTS, IN THE OPINION OF THE ENGINEER, DAMAGED DURING SHIPPING OR STORAGE PERIODS SHALL BE REPLACED BY AND AT THE EXPENSE OF THE CONTRACTOR

BASE PLATES

ISOLATION TRANSFORMERS

CONNECTORS, CABLE CLAMP, CORD SET, AND CABLE

ABBREVIATIONS:

MINIMUM

MEDIUM INTENSITY RUNWAY LIGHT

MIN

MIRL

ADJ	ADJUSTABLE	MITL	MEDIUM INTENSITY TAXIWAY LIGHT
ALCS	AIRFIELD LIGHTING CONTROL SYSTEM	N	NORTHING
ALCMS	AIRFIELD LIGHTING CONTROL AND MONITORING	NAD	NORTH AMERICAN DATUM
	SYSTEM	NGVD	NATIONAL GEODETIC VERTICAL DATUM
ALEV	AIRFIELD LIGHTING ELECTRICAL VAULT	NOTAM	NOTICE TO AIRMEN
AOA	AIRCRAFT OPERATIONS AREA	NTS	NOT TO SCALE
ARFF	AIRCRAFT RESCUE AND FIRE FIGHTING	OFA	OBJECT FREE AREA
ATCT	AIR TRAFFIC CONTROL TOWER	PCC	PORTLAND CEMENT CONCRETE
AWG	AMERICAN WIRE GAUGE	PG	PROPOSED GRADE
В	BASELINE	PI	POINT OF INTERSECTION
BSD	BARE SOFT DRAWN SOLID COPPER	PT	POINT OF TANGENCY
С	CONDUIT	PVC	POLYVINYL CHLORIDE
CCR	CONSTANT CURRENT REGULATOR	REIL	RUNWAY END IDENTIFIER LIGHT
CONC	CONCRETE	ROFA	RUNWAY OBJECT FREE AREA
CP	COUNTERPOISE	RPR	RESIDENT PROJECT REPRESENTATIVE
DIA	DIAMETER	RW	RUNWAY
DEB	DIRECT EARTH BURIED	RPZ	RUNWAY PROTECTION ZONE
DWG	DRAWING	RSA	RUNWAY SAFETY AREA
E	EASTING	RT	RIGHT
EA	EACH	RW	RUNWAY
ELEV	ELEVATION	SCH	SCHEDULE
EOP	EDGE OF PAVEMENT	SGN	SIGN
ES	EQUAL SPACES	SIDA	SECURITY IDENTIFICATION DISPLAY AREA
EX	EXISTING	SS	STAINLESS STEEL
FAA	FEDERAL AVIATION ADMINISTRATION	STA	STATION
GND	GROUND	STD	STANDARD
GRS	GALVANIZED RIGID STEEL CONDUIT	SW	SWITCH
HDD	HYDRAULIC DIRECTIONAL DRILLING	T/L	TAXILANE
HIRL	HIGH INTENSITY RUNWAY LIGHT	TW	TAXIWAY
I/C	NUMBER OF CONDUCTORS/CONDUCTOR	TBR	TO BE REMOVED
ILS	INSTRUMENT LANDING SYSTEM	TDZ	TOUCHDOWN ZONE
kV	KILOVOLT	TSA	TAXIWAY SAFETY AREA
LF	LINEAR FEET	TYP.	TYPICAL
LSUM	LUMP SUM	UG	UNDERGROUND ELECTRICAL DUCT
LT	LEFT	XFMR	TRANSFORMER
MAX	MAXIMUM	-	-
MCB	MAIN CIRCUIT BREAKER		

SPARE PARTS LIST	
SPARE PARTS LIST SPARE PARTS REQUIRED	
I	
SPARE PARTS REQUIRED	



RS&H Michigan, Inc.

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GERALD R. FORD INTERNATIONAL **AIRPORT**

TAXIWAY D LIGHTING REHABILITATION



REVISIONS				
NO.	DESCRIPTION	DATE		
DATE	ISSUED: MAY 20	25		

REVIEWED BY: MAR DRAWN BY: DESIGNED BY: EE

> RS&H PROJECT NUMBER 1010-5865-001


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GENERAL **ELECTRICAL** NOTES

SHEET TITLE

SHEET NUMBER

E001

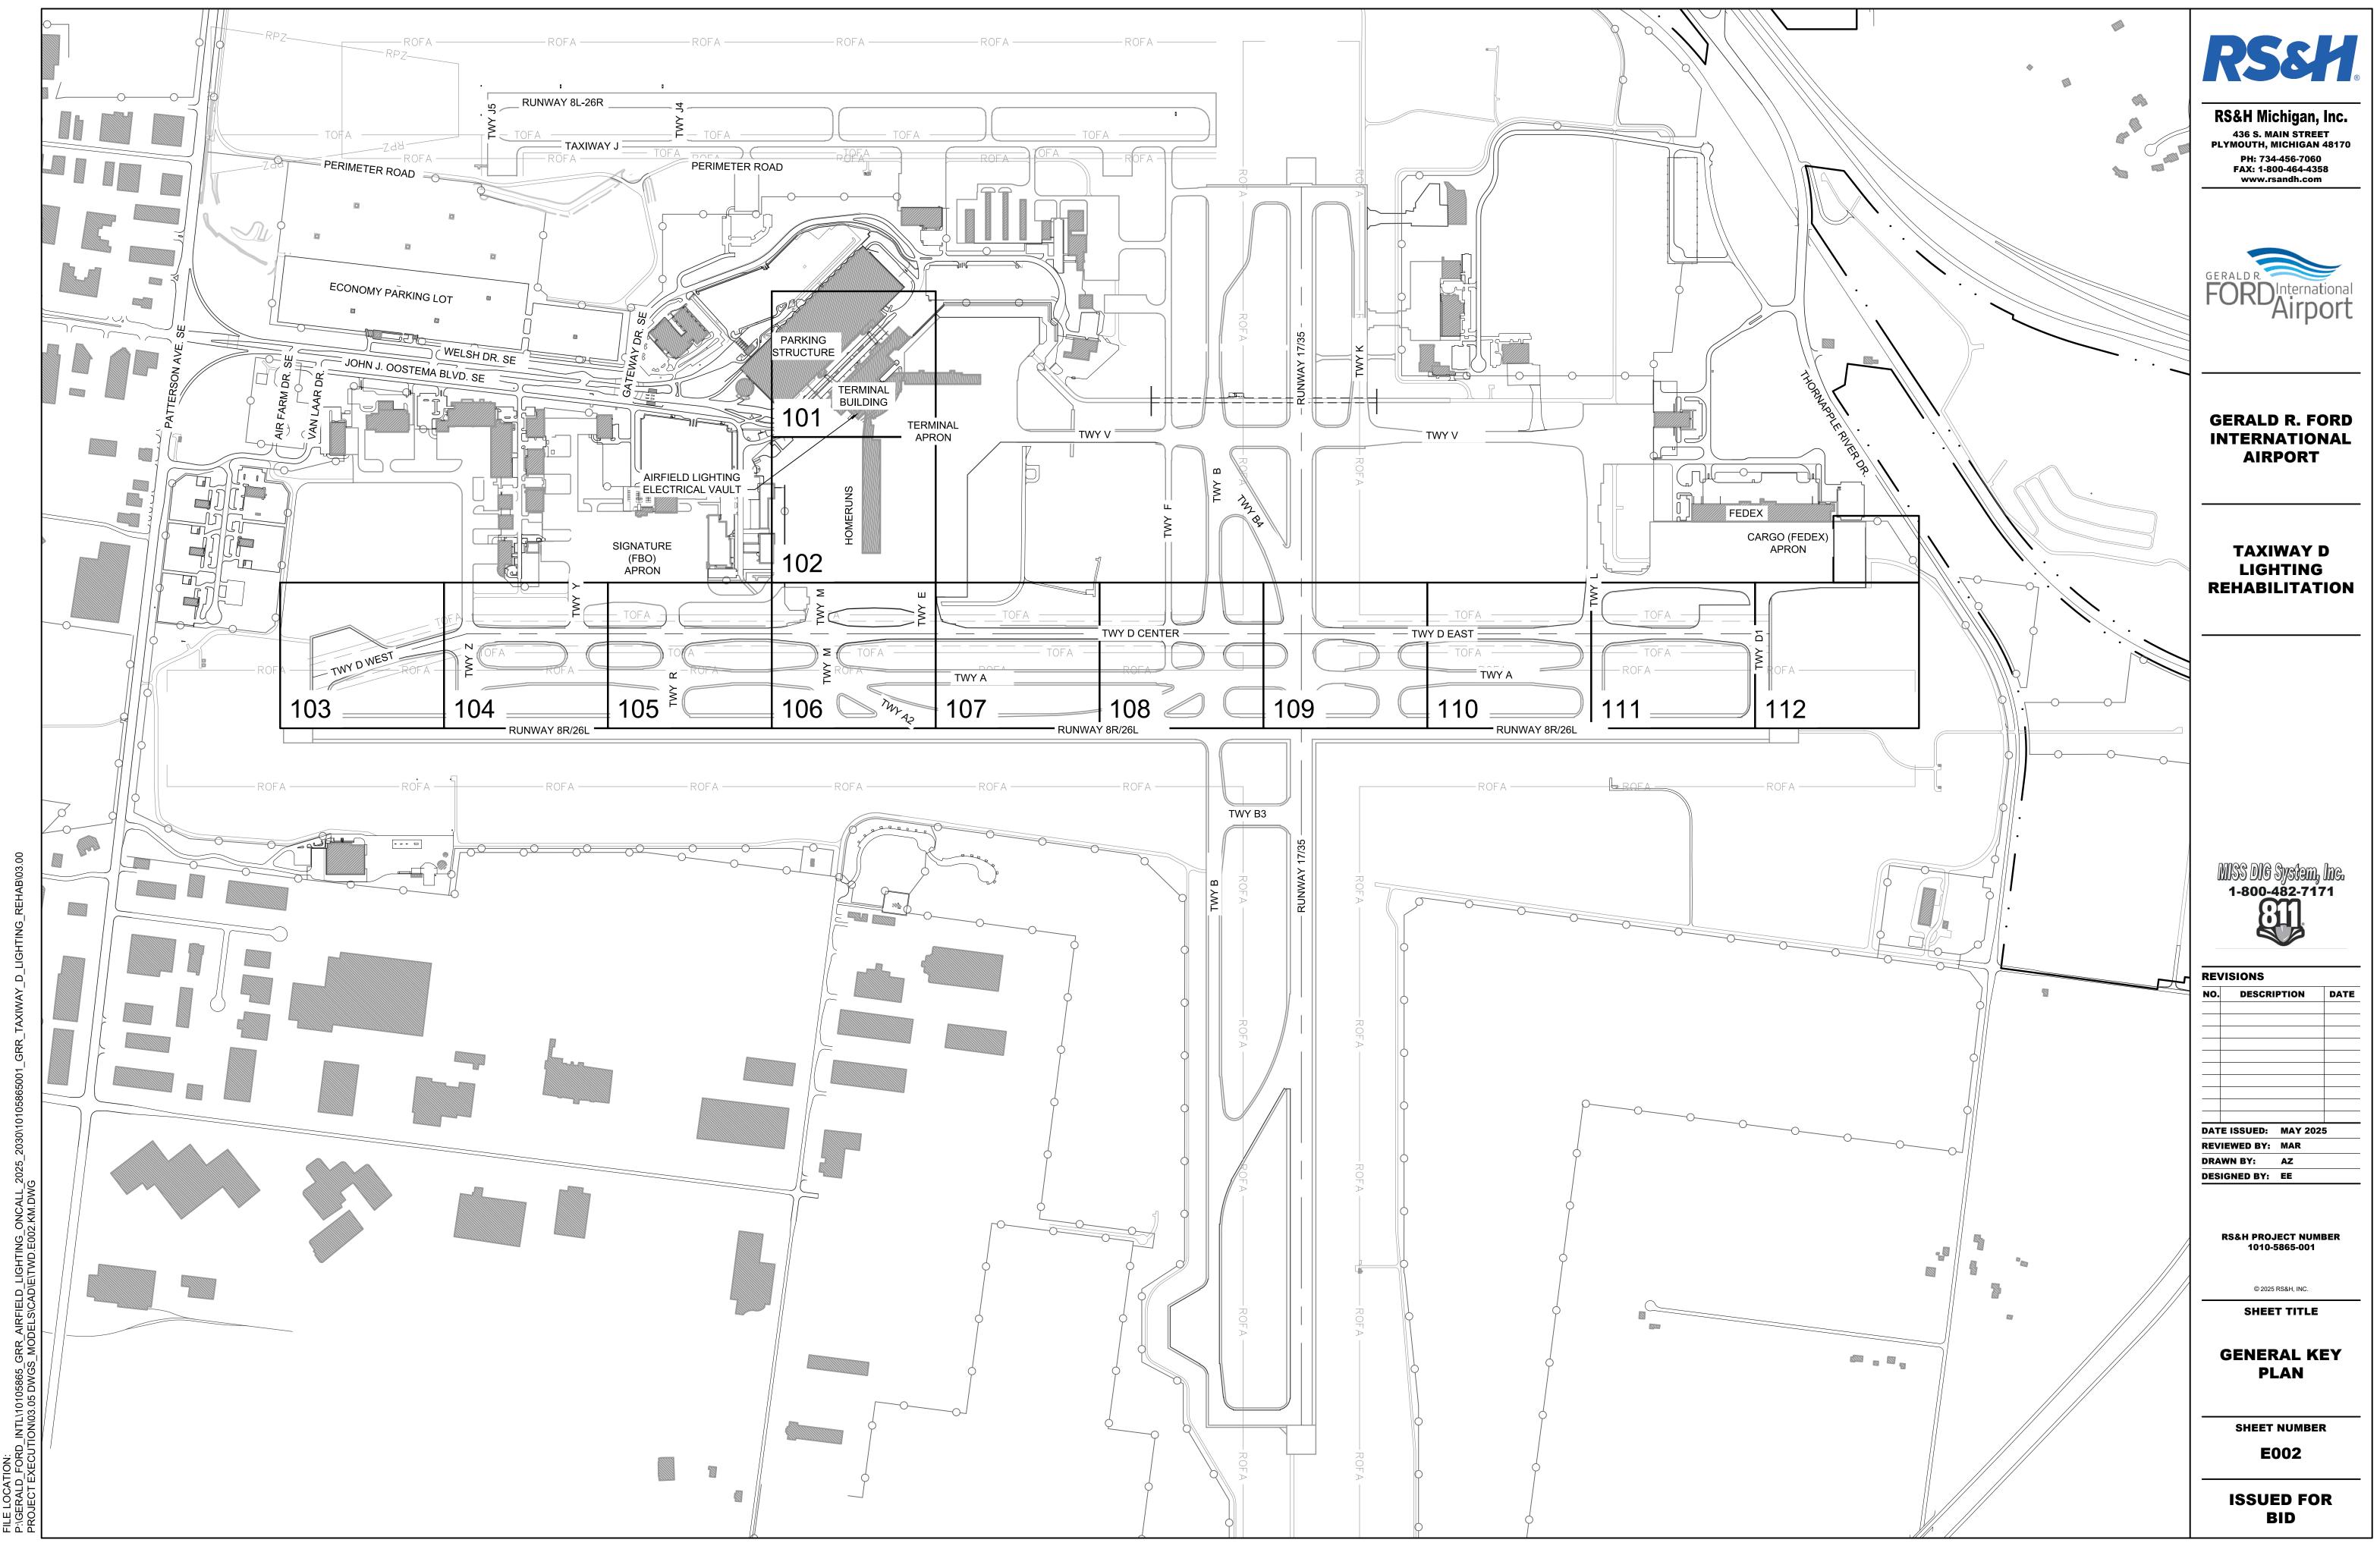

L-824 5KV CABLE IN EXISTING CONDUIT, REMOVE /-- CKT# AND REPLACE WITH NEW CABLE, EXISTING CONDUIT TO REMAIN. HASH MARKS INDICATE NUMBER OF CABLES, CKT # = CIRCUIT DESIGNATOR

EXISTING ELECTRICAL DUCT BANK

EXISTING RUNWAY EDGE LIGHT TO REMAIN

EXISTING TAXIWAY EDGE LIGHT TO REMAIN

EXISTING TAXIWAY EDGE LIGHT, REMOVE AND REPLACE WITH NEW LED FIXTURE, EXISTING BASE CAN TO BE REUSED

EXISTING AIRFIELD GUIDANCE SIGN TO REMAIN

EXISTING AIRFIELD GUIDANCE SIGN, REMOVE AND REPLACE ISOLATION TRANSFORMER, SIGN TO REMAIN. XXX = SIGN NUMBER

EXISTING WINDCONE TO REMAIN, REMOVE AND REPLACE ISOLATION TRANSFORMER

EXISTING ELECTRICAL HANDHOLE TO REMAIN

EXISTING SINGLE JUNCTION CAN TO REMAIN

EXISTING ELECTRICAL MANHOLE TO REMAIN

EXISTING COMMUNICATIONS MANHOLE TO REMAIN

CKT #12 = TAXIWAY DELTA WEST CKT #16 = TAXIWAY DELTA EAST CKT #17 = TAXIWAY DELTA CENTER

GENERAL NOTES:


- 1. SEE E001 FOR GENERAL ELECTRICAL NOTES.
- 2. REMOVE AND REPLACE ALL ISOLATION TRANSFORMERS CONNECTED TO CIRCUITS #12, #16 AND #17, AT TAXIWAY EDGE LIGHTS, GUIDANCE SIGNS AND WINDCONES, AS APPLICABLE.
- 3. EXACT ROUTING OF CABLES THROUGH EXISTING INFRASTRUCTURE SHALL BE FIELD VERIFIED.

KEYED NOTES:

- \langle 1 \rangle APPROXIMATE LOCATION OF EXISTING AIRFIELD LIGHTING ELECTRICAL VAULT. SEE SHEETS ED201 FOR DEMOLITION SCOPE OF WORK. EXACT ROUTING OF "HOMERUN" CONDUITS AND DUCTBANKS TO VAULT SHALL BE FIELD DETERMINED.
- (2) REMOVE AND REPLACE TAXIWAY DELTA "HOMERUN" CIRCUITS #12, #16, AND #17 FROM EXISTING DUCTBANKS. ALL OTHER CIRCUITS SHALL BE PROTECTED IN PLACE.
- REMOVE AND REPLACE TAXIWAY DELTA CIRCUITS #12, #16, AND #17 FROM EXISTING CONDUITS. ALL OTHER CIRCUITS SHALL BE PROTECTED IN PLACE.
- 4 ALL PROPOSED AND EXISTING WIRING TO BE PROPERLY IDENTIFIED, RACKED, AND TAGGED IN EACH MANHOLE. PROVIDE A MINIMUM OF ONE (1) LOOP OF WIRING IN EACH MANHOLE FOR EACH NEW CIRCUIT HOMERUN WIRE. CLEAN HOMERUN MANHOLES. ANY DEWATERING SHALL BE INCIDENTAL TO INSTALLATION OF NEW WIRING.
- \langle 5 \rangle EXISTING GUIDANCE SIGNS AND CONCRETE PADS TO REMAIN ON CIRCUITS #12, #16 AND #17. REPLACE ISOLATION TRANSFORMER AND CONNECTIONS. SIZE ISOLATION TRANSFORMER PER EACH SIGN LOAD, PER MANUFACTURER'S RECOMMENDATION.

3 4 5 6 7 8 9 10 11 12

KEY PLAN

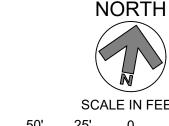

SCALE IN FEET

RS&H PROJECT NUMBER 1010-5865-001

DATE ISSUED: MAY 2025 REVIEWED BY: MAR

DRAWN BY: AZ DESIGNED BY: EE

RS&H Michigan, Inc.

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NO. DESCRIPTION DATE


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SHEET TITLE

DEMOLITION AIRFIELD LIGHTING PLAN - AREA 1

> **SHEET NUMBER** ED101



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DRAWN BY: AZ
DESIGNED BY: EE

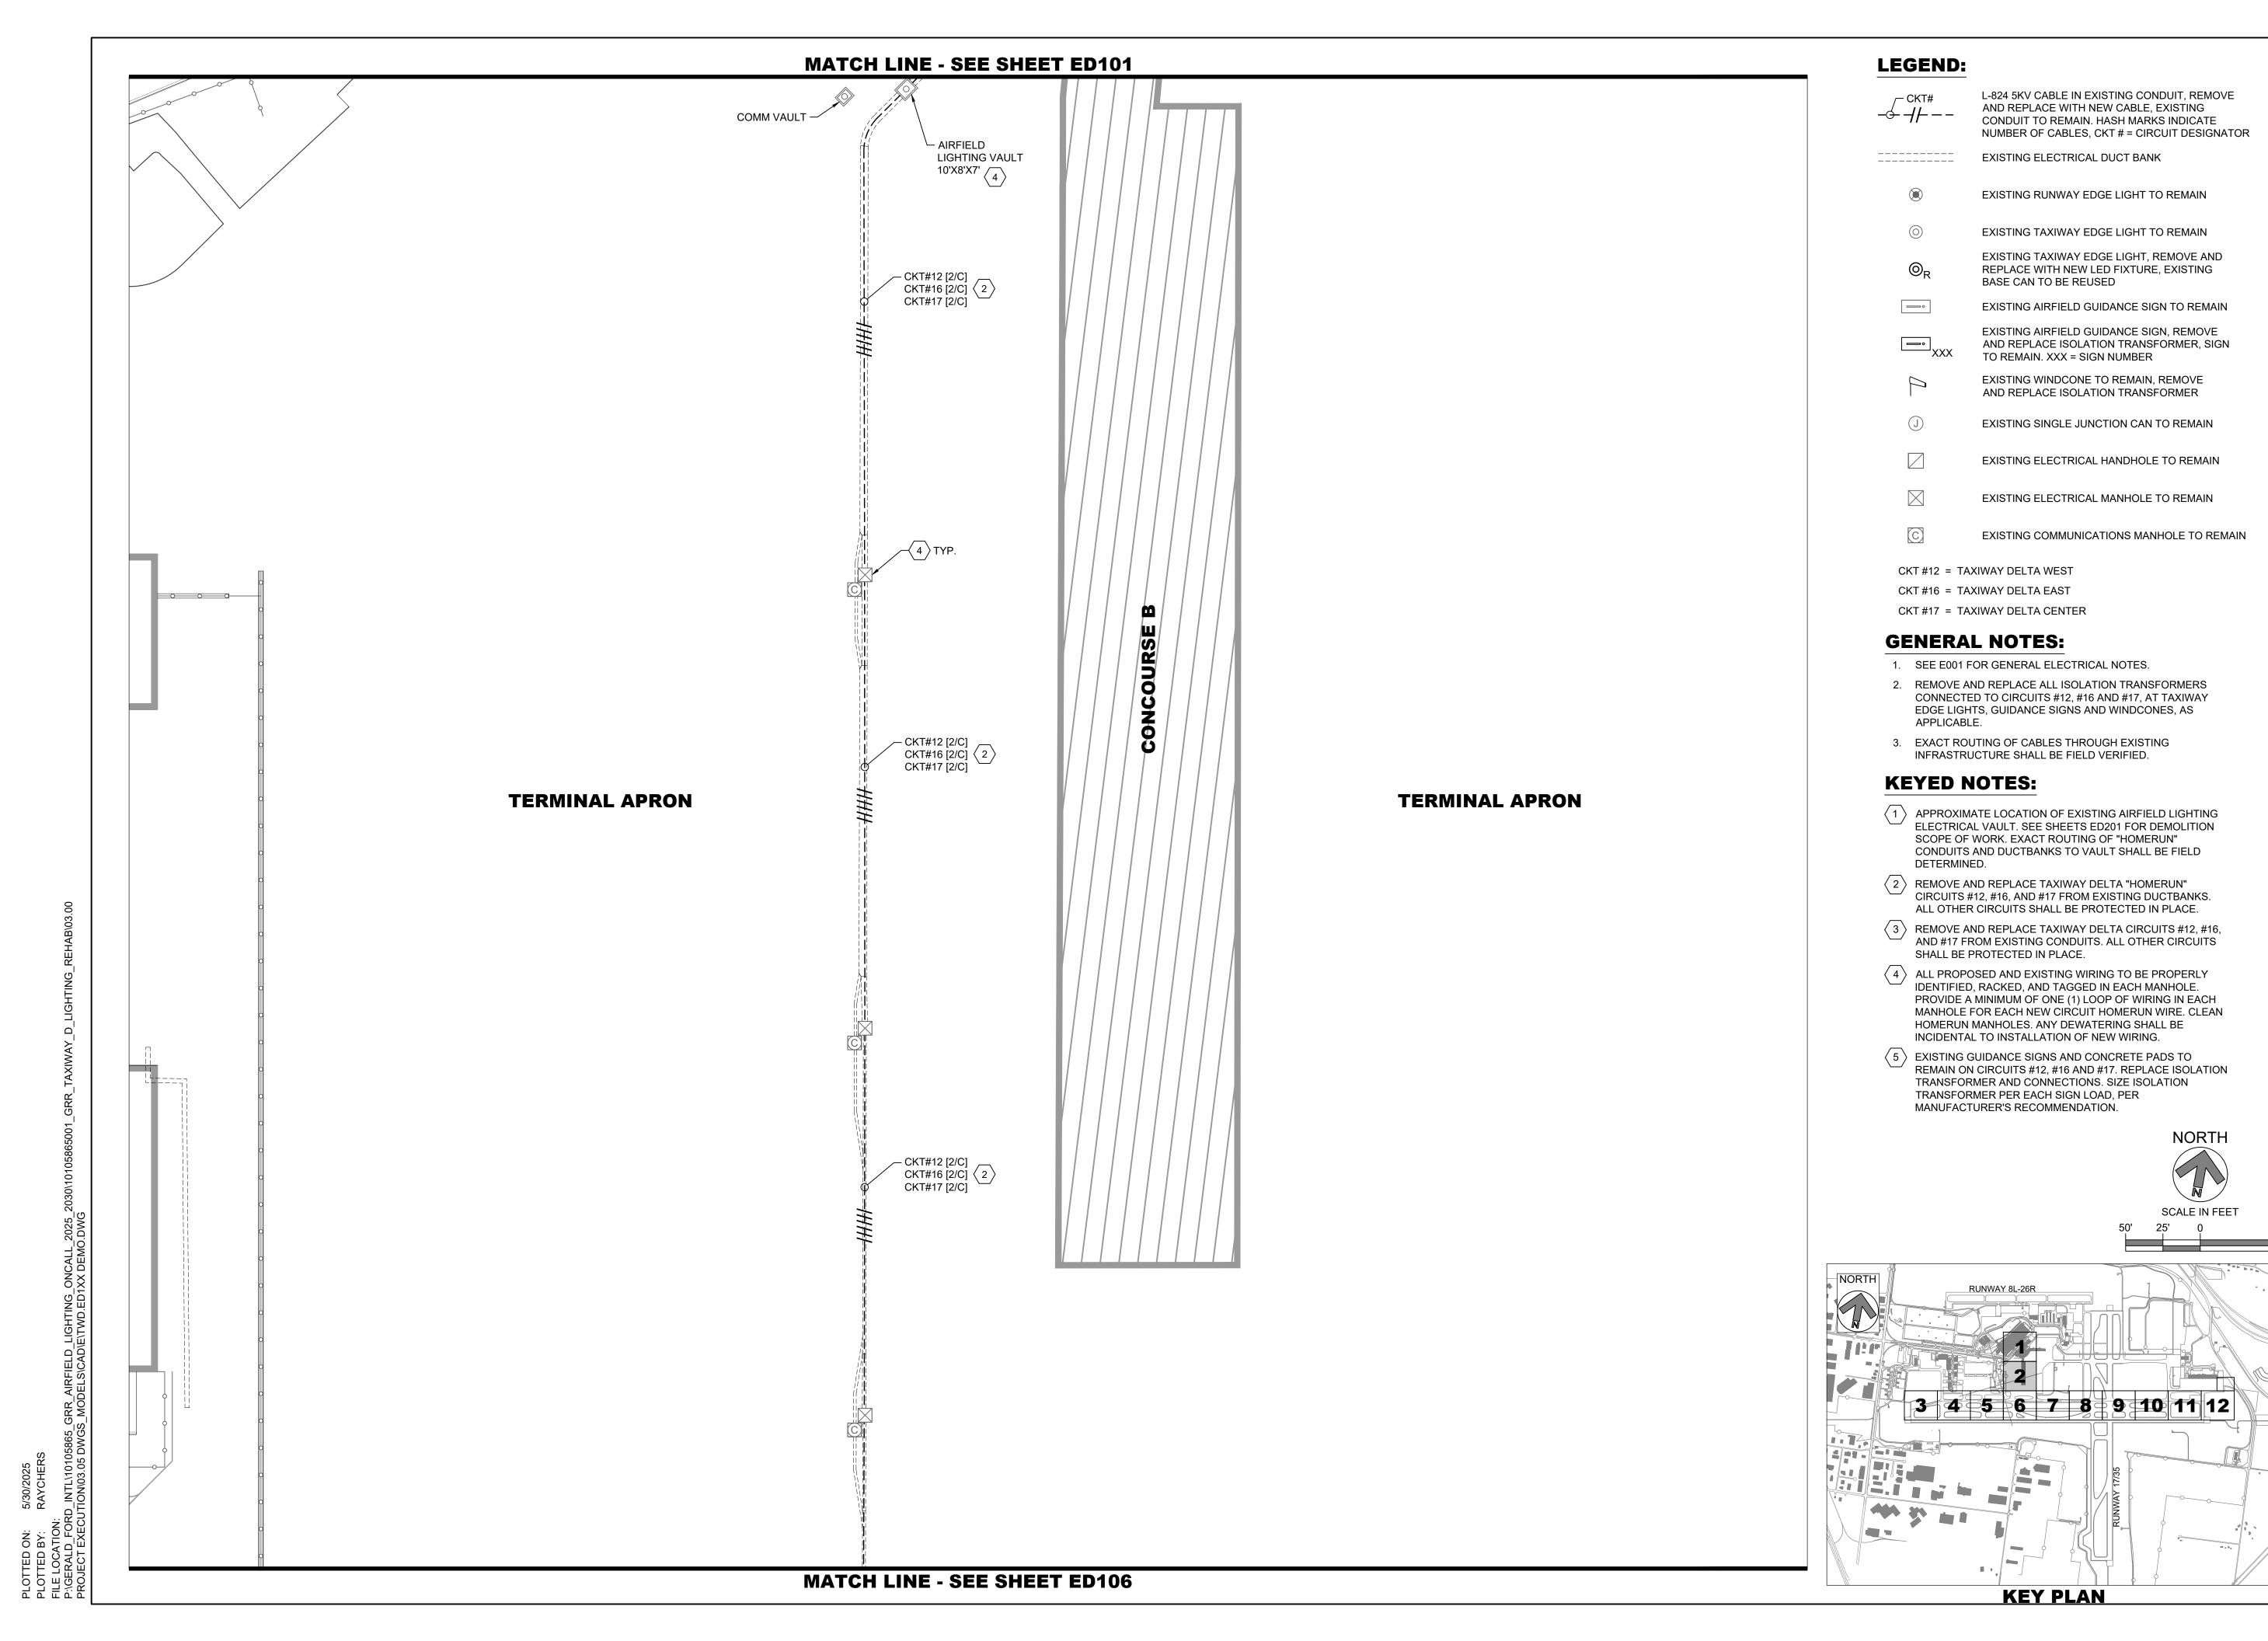RS&H PROJECT NUMBER 1010-5865-001


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SHEET TITLE

DEMOLITION AIRFIELD LIGHTING PLAN - AREA 2

SHEET NUMBER

ED102

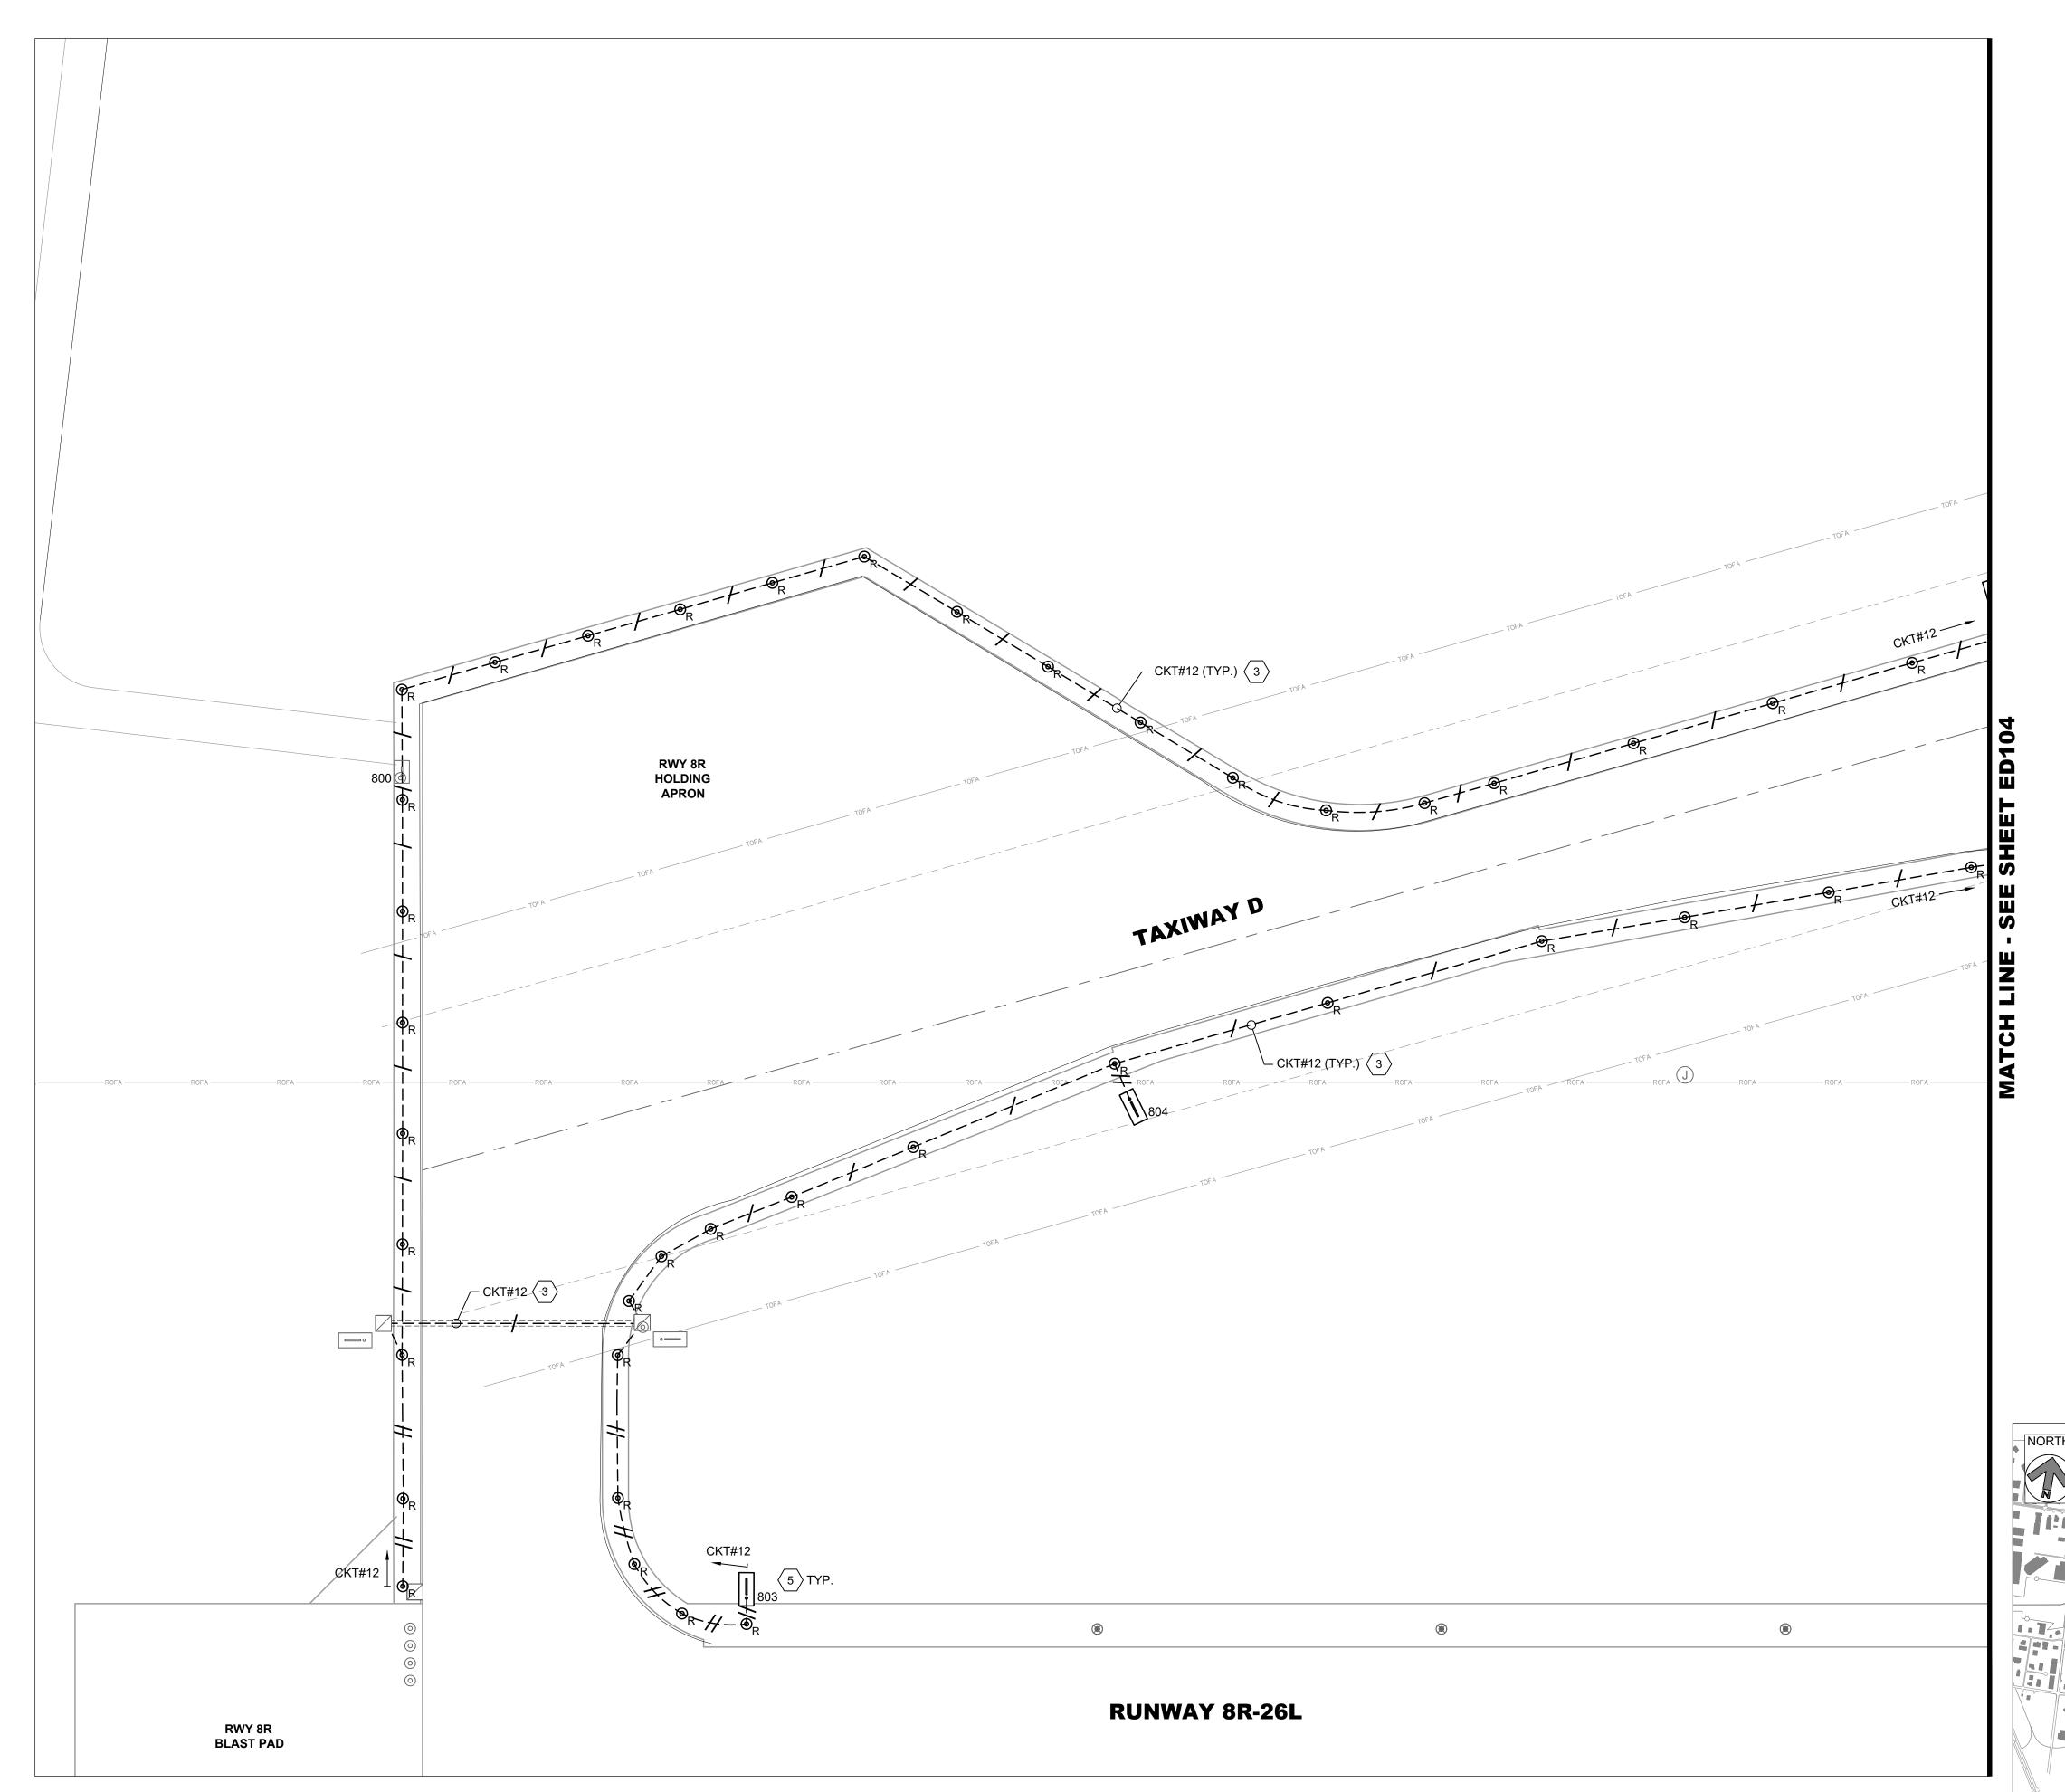

LEGEND: L-824 5KV CABLE IN EXISTING CONDUIT, REMOVE /-- CKT# AND REPLACE WITH NEW CABLE, EXISTING CONDUIT TO REMAIN. HASH MARKS INDICATE NUMBER OF CABLES, CKT # = CIRCUIT DESIGNATOR EXISTING ELECTRICAL DUCT BANK EXISTING RUNWAY EDGE LIGHT TO REMAIN EXISTING TAXIWAY EDGE LIGHT TO REMAIN EXISTING TAXIWAY EDGE LIGHT, REMOVE AND REPLACE WITH NEW LED FIXTURE, EXISTING BASE CAN TO BE REUSED EXISTING AIRFIELD GUIDANCE SIGN TO REMAIN EXISTING AIRFIELD GUIDANCE SIGN, REMOVE AND REPLACE ISOLATION TRANSFORMER, SIGN TO REMAIN. XXX = SIGN NUMBER EXISTING WINDCONE TO REMAIN, REMOVE AND REPLACE ISOLATION TRANSFORMER EXISTING SINGLE JUNCTION CAN TO REMAIN EXISTING ELECTRICAL HANDHOLE TO REMAIN EXISTING ELECTRICAL MANHOLE TO REMAIN EXISTING COMMUNICATIONS MANHOLE TO REMAIN CKT #12 = TAXIWAY DELTA WEST CKT #16 = TAXIWAY DELTA EAST

GENERAL NOTES:


1. SEE E001 FOR GENERAL ELECTRICAL NOTES.


CKT #17 = TAXIWAY DELTA CENTER

- 2. REMOVE AND REPLACE ALL ISOLATION TRANSFORMERS CONNECTED TO CIRCUITS #12, #16 AND #17, AT TAXIWAY EDGE LIGHTS, GUIDANCE SIGNS AND WINDCONES, AS APPLICABLE.
- 3. EXACT ROUTING OF CABLES THROUGH EXISTING INFRASTRUCTURE SHALL BE FIELD VERIFIED.

KEYED NOTES:

- \langle 1 \rangle APPROXIMATE LOCATION OF EXISTING AIRFIELD LIGHTING ELECTRICAL VAULT. SEE SHEETS ED201 FOR DEMOLITION SCOPE OF WORK. EXACT ROUTING OF "HOMERUN" CONDUITS AND DUCTBANKS TO VAULT SHALL BE FIELD DETERMINED.
- (2) REMOVE AND REPLACE TAXIWAY DELTA "HOMERUN" CIRCUITS #12, #16, AND #17 FROM EXISTING DUCTBANKS. ALL OTHER CIRCUITS SHALL BE PROTECTED IN PLACE.
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- \langle 5 \rangle EXISTING GUIDANCE SIGNS AND CONCRETE PADS TO REMAIN ON CIRCUITS #12, #16 AND #17. REPLACE ISOLATION TRANSFORMER AND CONNECTIONS. SIZE ISOLATION TRANSFORMER PER EACH SIGN LOAD, PER MANUFACTURER'S RECOMMENDATION.

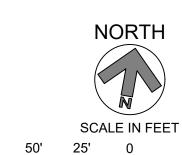

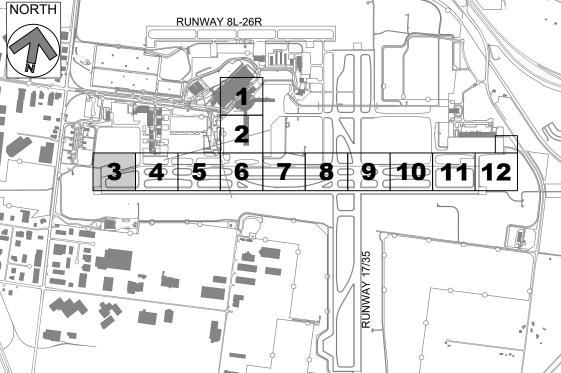

KEY PLAN

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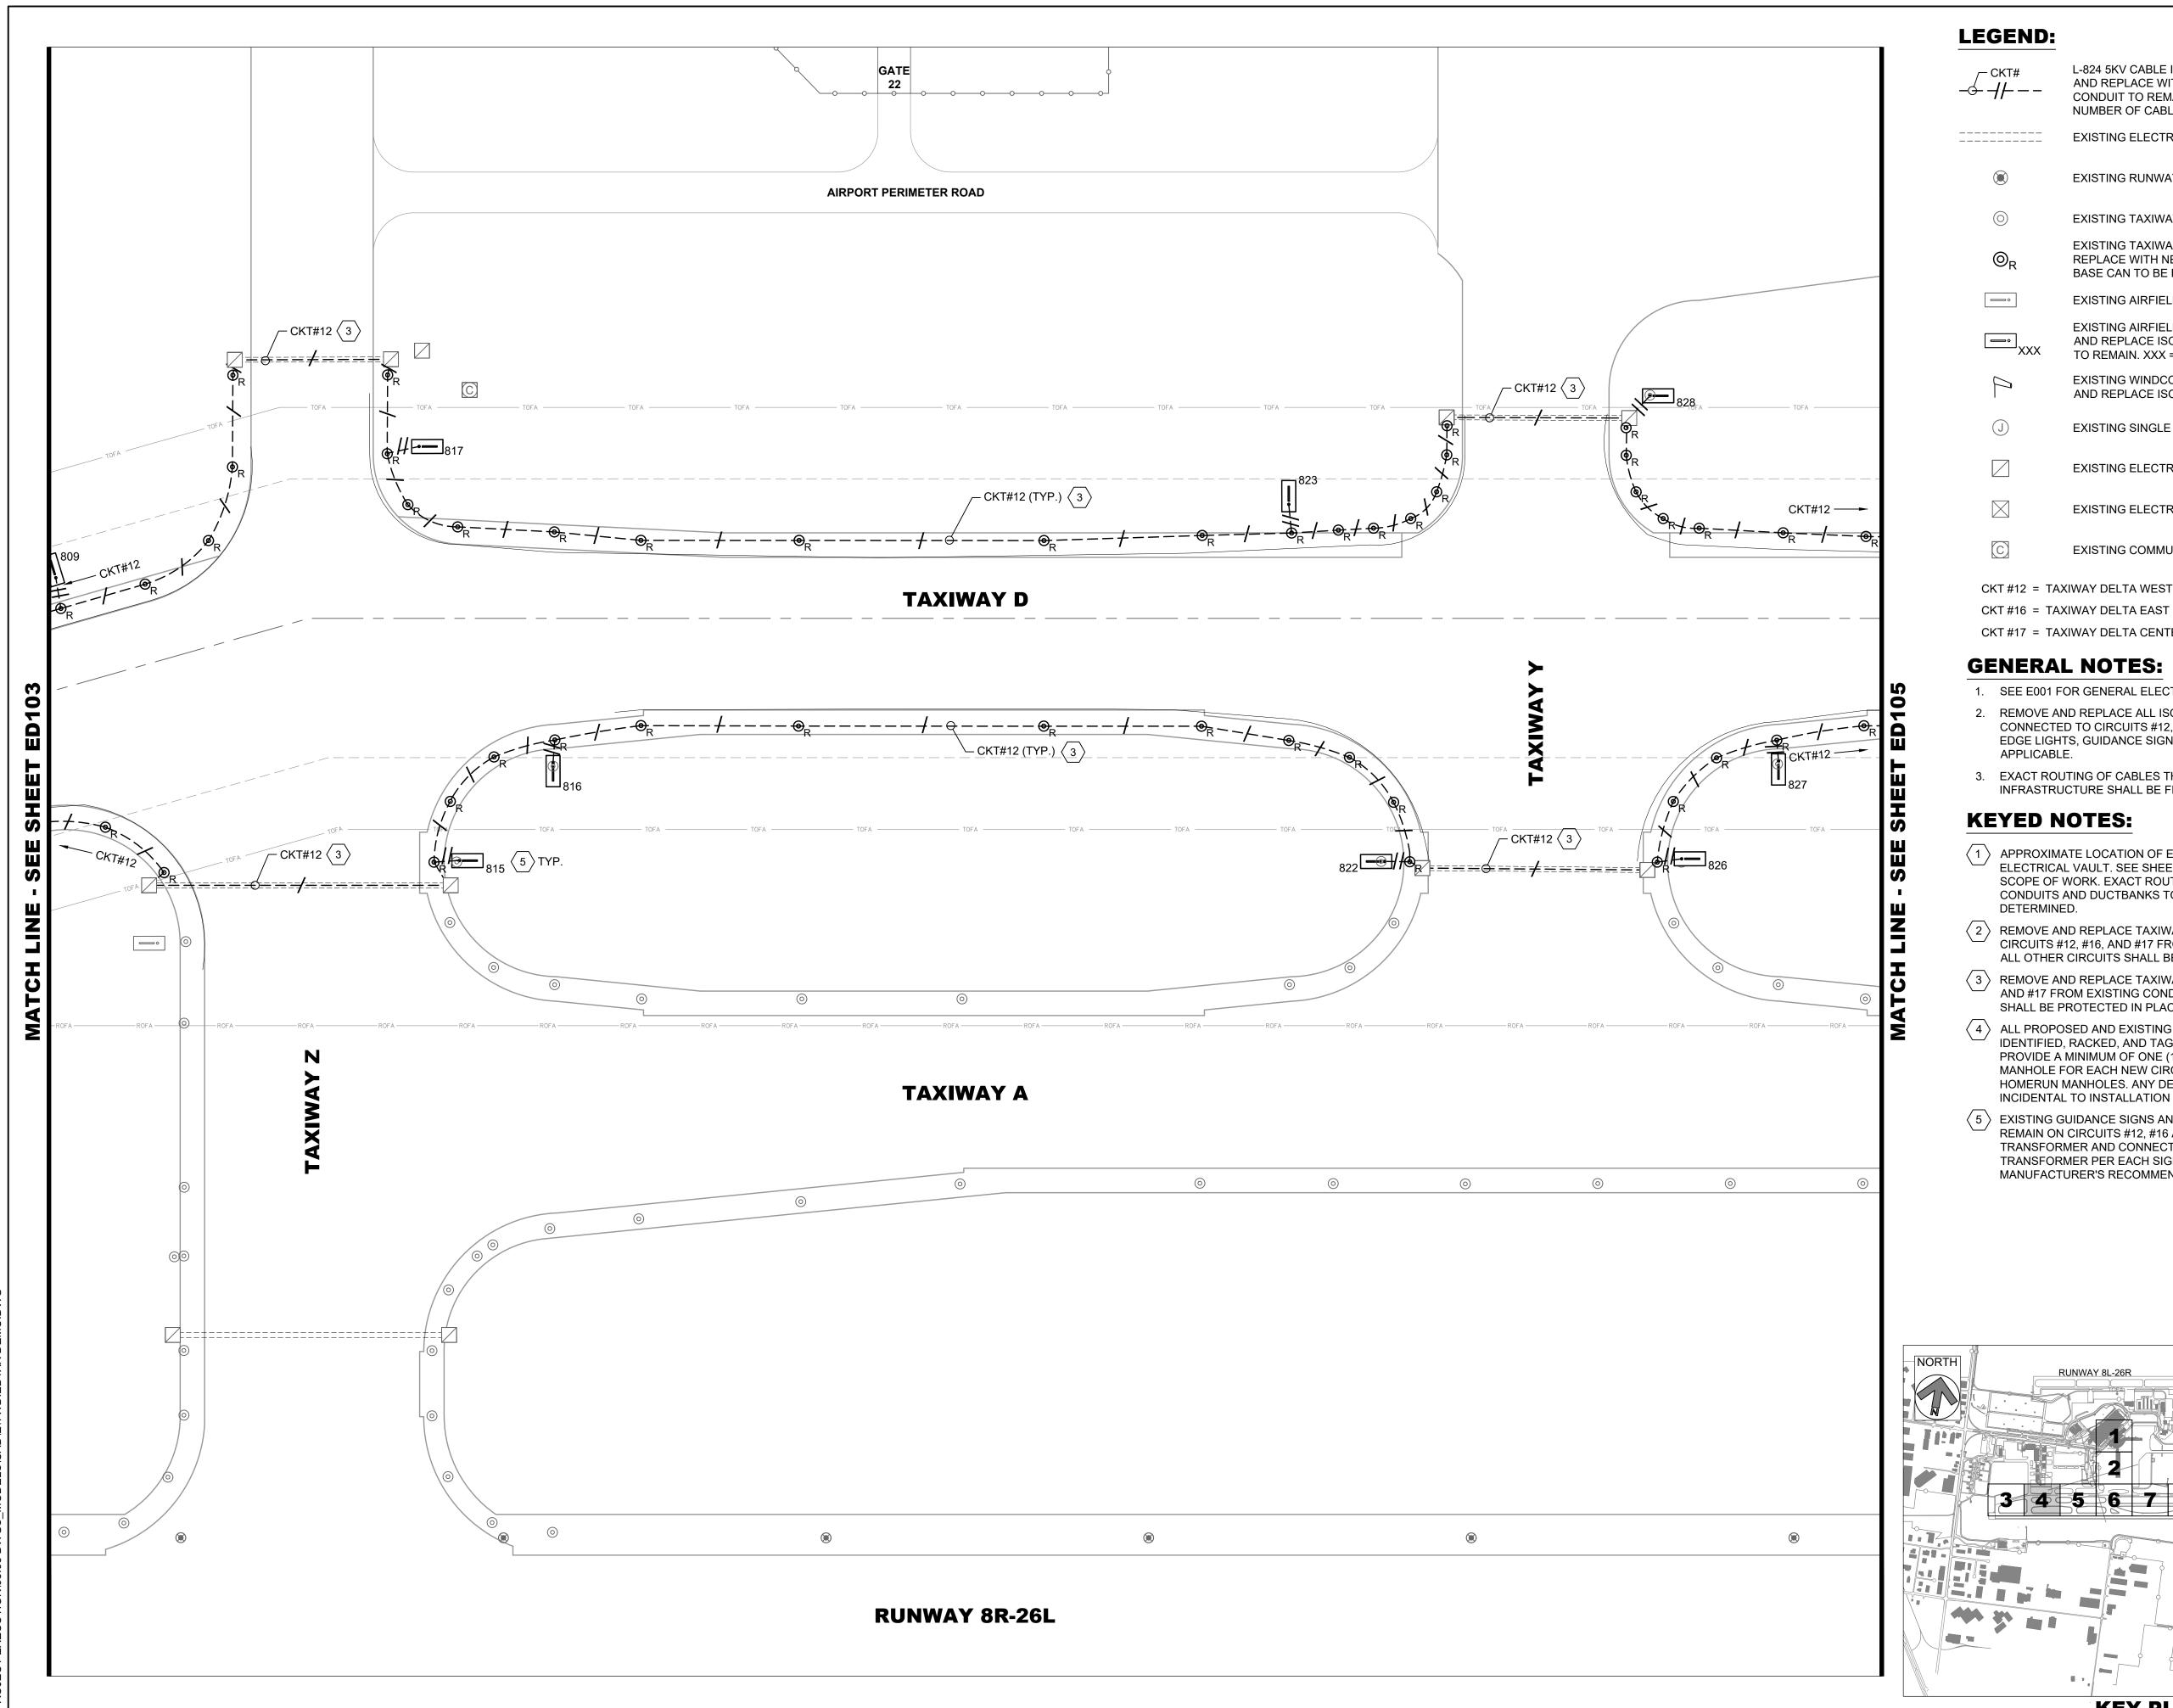
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SHEET TITLE **DEMOLITION**

AIRFIELD LIGHTING PLAN - AREA 3

> **SHEET NUMBER ED103**



LEGEND: L-824 5KV CABLE IN EXISTING CONDUIT, REMOVE /-- CKT# AND REPLACE WITH NEW CABLE, EXISTING CONDUIT TO REMAIN. HASH MARKS INDICATE NUMBER OF CABLES, CKT # = CIRCUIT DESIGNATOR EXISTING ELECTRICAL DUCT BANK EXISTING RUNWAY EDGE LIGHT TO REMAIN EXISTING TAXIWAY EDGE LIGHT TO REMAIN EXISTING TAXIWAY EDGE LIGHT, REMOVE AND REPLACE WITH NEW LED FIXTURE, EXISTING BASE CAN TO BE REUSED EXISTING AIRFIELD GUIDANCE SIGN TO REMAIN EXISTING AIRFIELD GUIDANCE SIGN, REMOVE AND REPLACE ISOLATION TRANSFORMER, SIGN TO REMAIN. XXX = SIGN NUMBER EXISTING WINDCONE TO REMAIN, REMOVE AND REPLACE ISOLATION TRANSFORMER EXISTING SINGLE JUNCTION CAN TO REMAIN EXISTING ELECTRICAL HANDHOLE TO REMAIN EXISTING ELECTRICAL MANHOLE TO REMAIN EXISTING COMMUNICATIONS MANHOLE TO REMAIN CKT #12 = TAXIWAY DELTA WEST


CKT #17 = TAXIWAY DELTA CENTER


GENERAL NOTES:

- 1. SEE E001 FOR GENERAL ELECTRICAL NOTES.
- 2. REMOVE AND REPLACE ALL ISOLATION TRANSFORMERS CONNECTED TO CIRCUITS #12, #16 AND #17, AT TAXIWAY EDGE LIGHTS, GUIDANCE SIGNS AND WINDCONES, AS APPLICABLE.
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KEYED NOTES:

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- (5) EXISTING GUIDANCE SIGNS AND CONCRETE PADS TO REMAIN ON CIRCUITS #12, #16 AND #17. REPLACE ISOLATION TRANSFORMER AND CONNECTIONS. SIZE ISOLATION TRANSFORMER PER EACH SIGN LOAD, PER MANUFACTURER'S RECOMMENDATION.



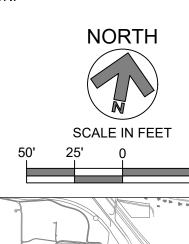
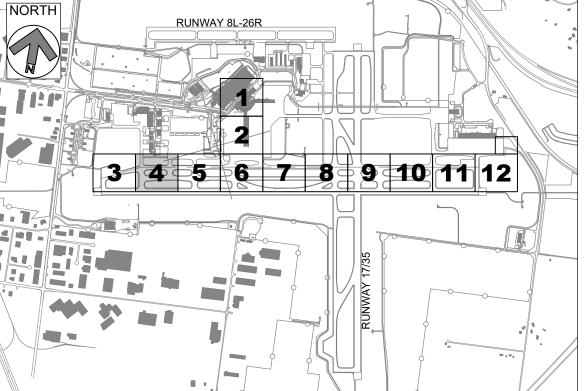
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DATE	ISSUED:	MAY 20	25
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REVISIONS

RS&H PROJECT NUMBER

DESIGNED BY: EE

1010-5865-001


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SHEET TITLE **DEMOLITION**

AIRFIELD LIGHTING PLAN - AREA 4

SHEET NUMBER

ED104

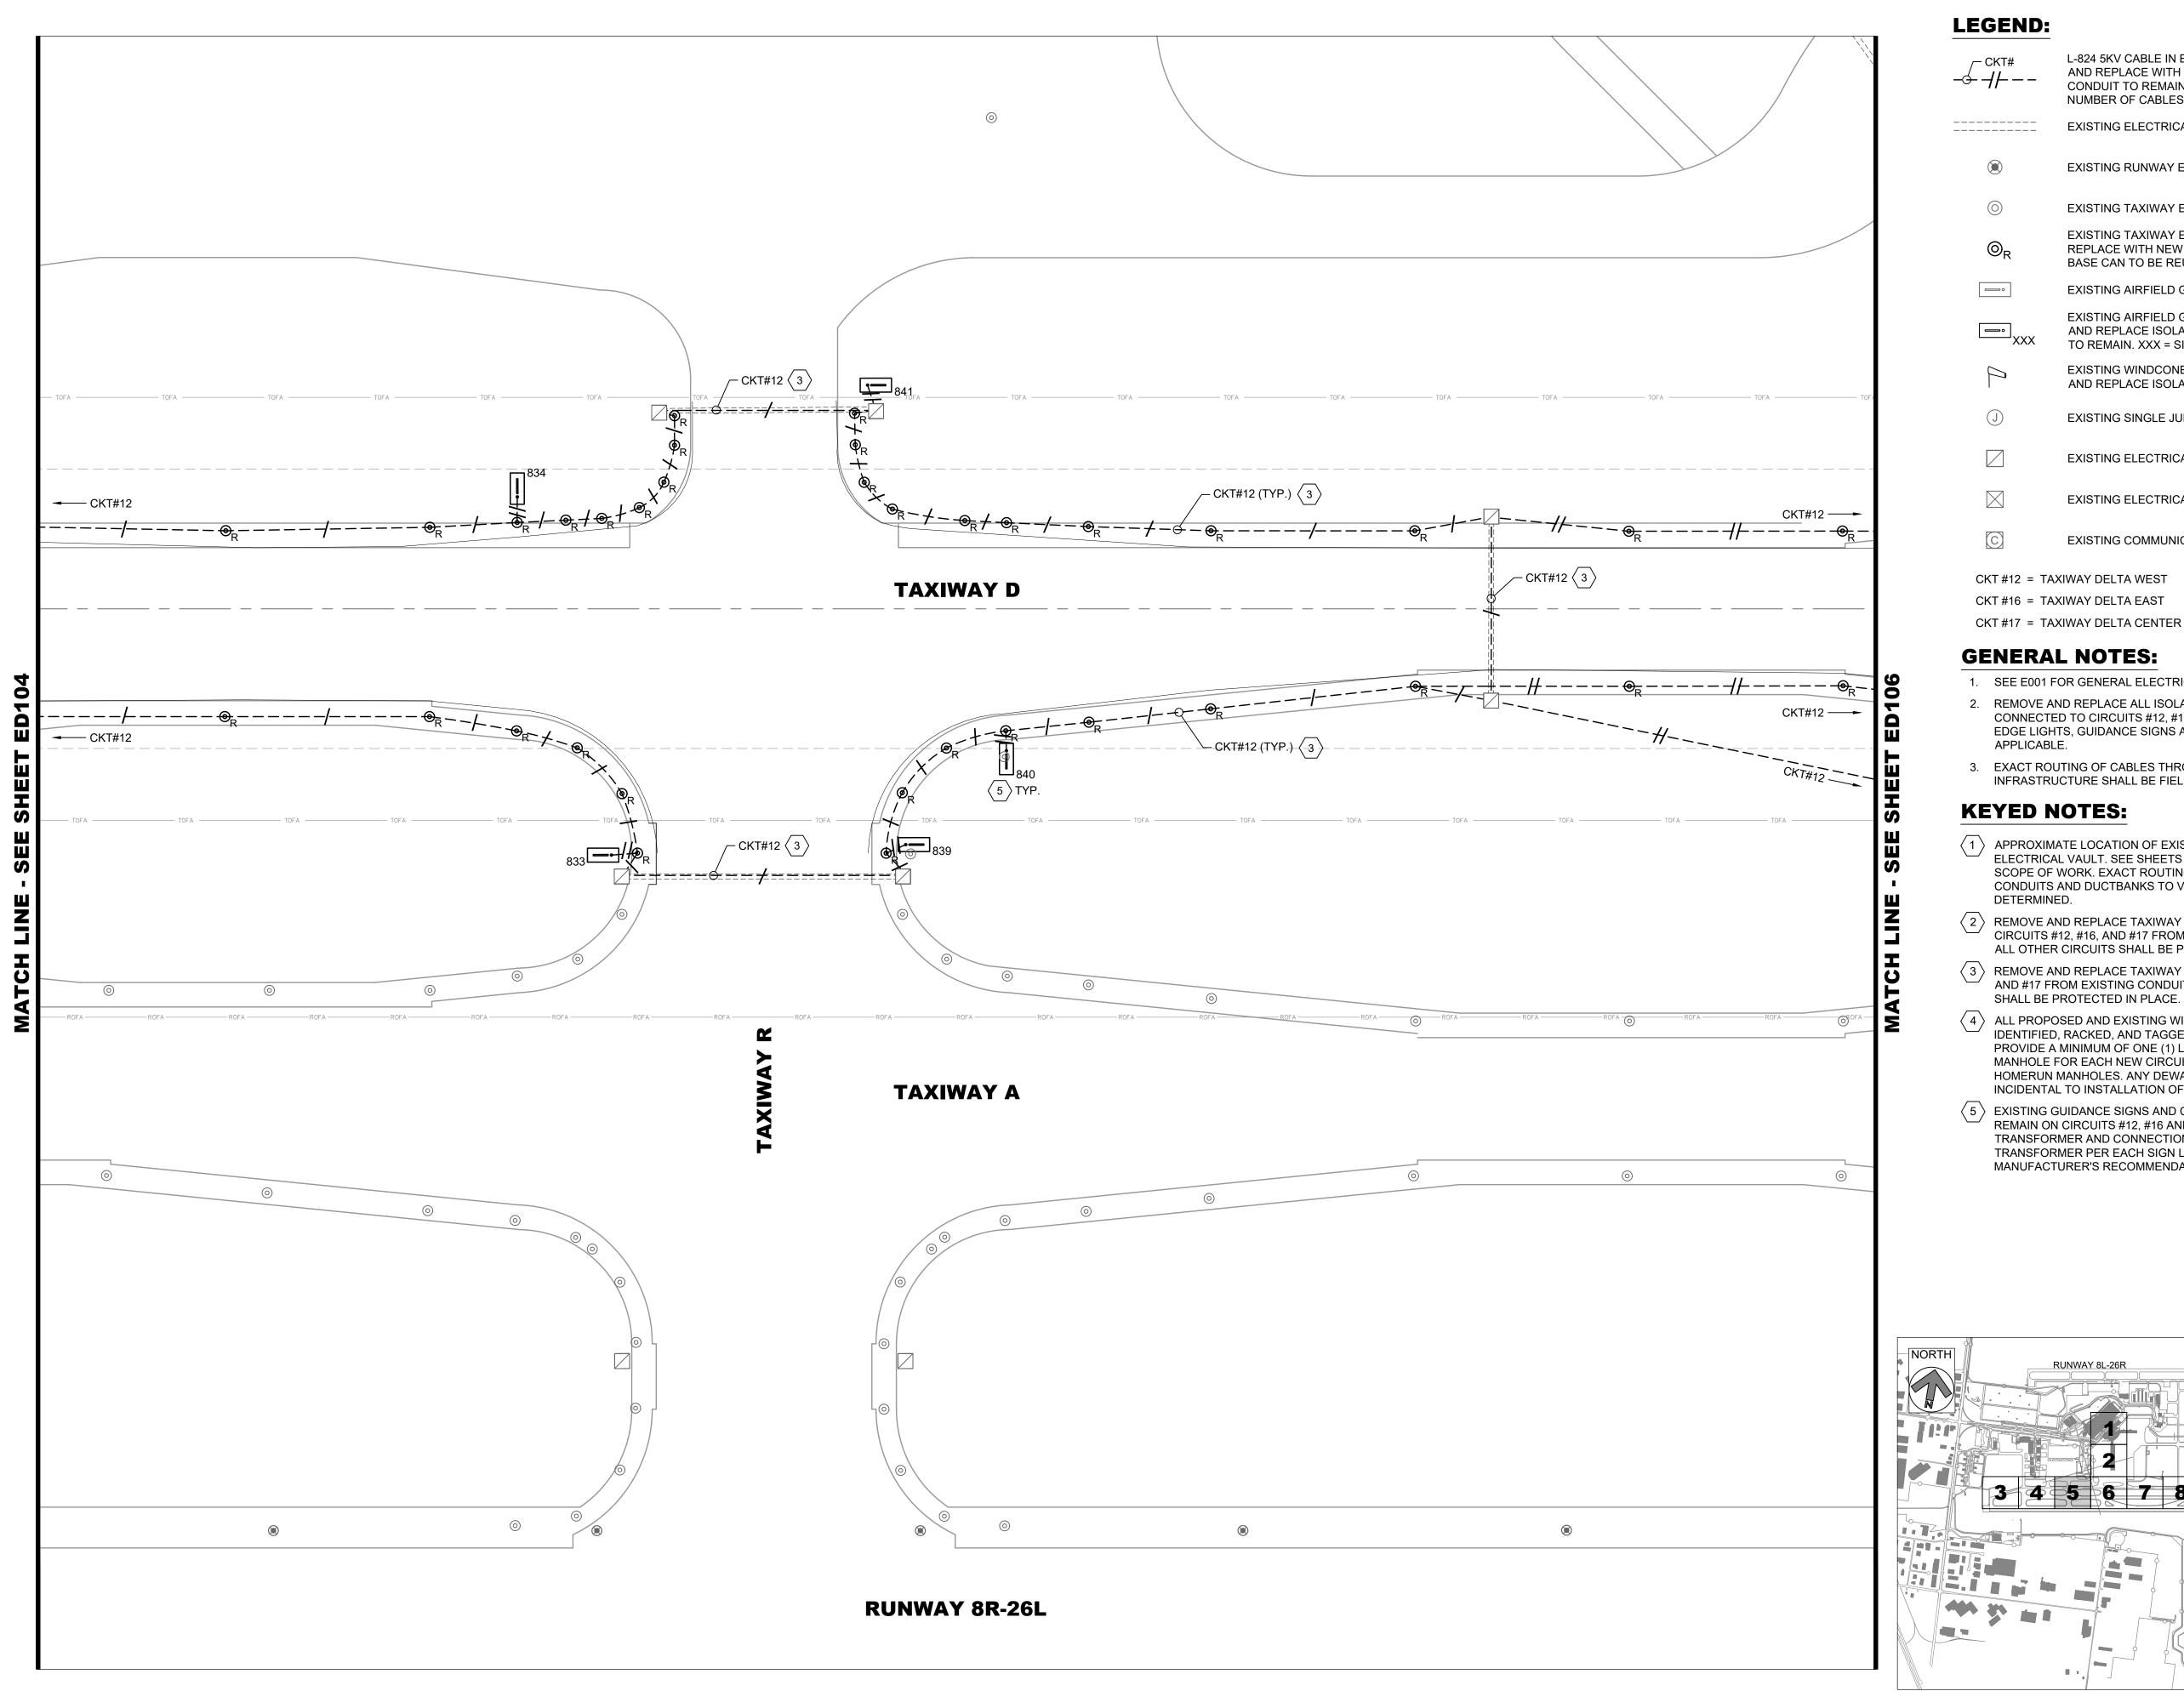

L-824 5KV CABLE IN EXISTING CONDUIT, REMOVE /-- CKT# AND REPLACE WITH NEW CABLE, EXISTING CONDUIT TO REMAIN. HASH MARKS INDICATE NUMBER OF CABLES, CKT # = CIRCUIT DESIGNATOR EXISTING ELECTRICAL DUCT BANK EXISTING RUNWAY EDGE LIGHT TO REMAIN EXISTING TAXIWAY EDGE LIGHT TO REMAIN EXISTING TAXIWAY EDGE LIGHT, REMOVE AND REPLACE WITH NEW LED FIXTURE, EXISTING BASE CAN TO BE REUSED EXISTING AIRFIELD GUIDANCE SIGN TO REMAIN EXISTING AIRFIELD GUIDANCE SIGN, REMOVE AND REPLACE ISOLATION TRANSFORMER, SIGN TO REMAIN. XXX = SIGN NUMBER EXISTING WINDCONE TO REMAIN, REMOVE AND REPLACE ISOLATION TRANSFORMER EXISTING SINGLE JUNCTION CAN TO REMAIN EXISTING ELECTRICAL HANDHOLE TO REMAIN EXISTING ELECTRICAL MANHOLE TO REMAIN EXISTING COMMUNICATIONS MANHOLE TO REMAIN CKT #12 = TAXIWAY DELTA WEST


GENERAL NOTES:

- 1. SEE E001 FOR GENERAL ELECTRICAL NOTES.
- 2. REMOVE AND REPLACE ALL ISOLATION TRANSFORMERS CONNECTED TO CIRCUITS #12, #16 AND #17, AT TAXIWAY EDGE LIGHTS, GUIDANCE SIGNS AND WINDCONES, AS APPLICABLE.
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KEY PLAN



3 4 5 6 7 8 9 10 11 12

RS&H PROJECT NUMBER 1010-5865-001
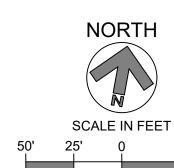
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NO. DESCRIPTION DATE

REVISIONS

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DATE ISSUED: MAY 2025 REVIEWED BY: MAR


DRAWN BY: AZ DESIGNED BY: EE

> SHEET TITLE **DEMOLITION**

AIRFIELD LIGHTING PLAN - AREA 5

SHEET NUMBER

ED105

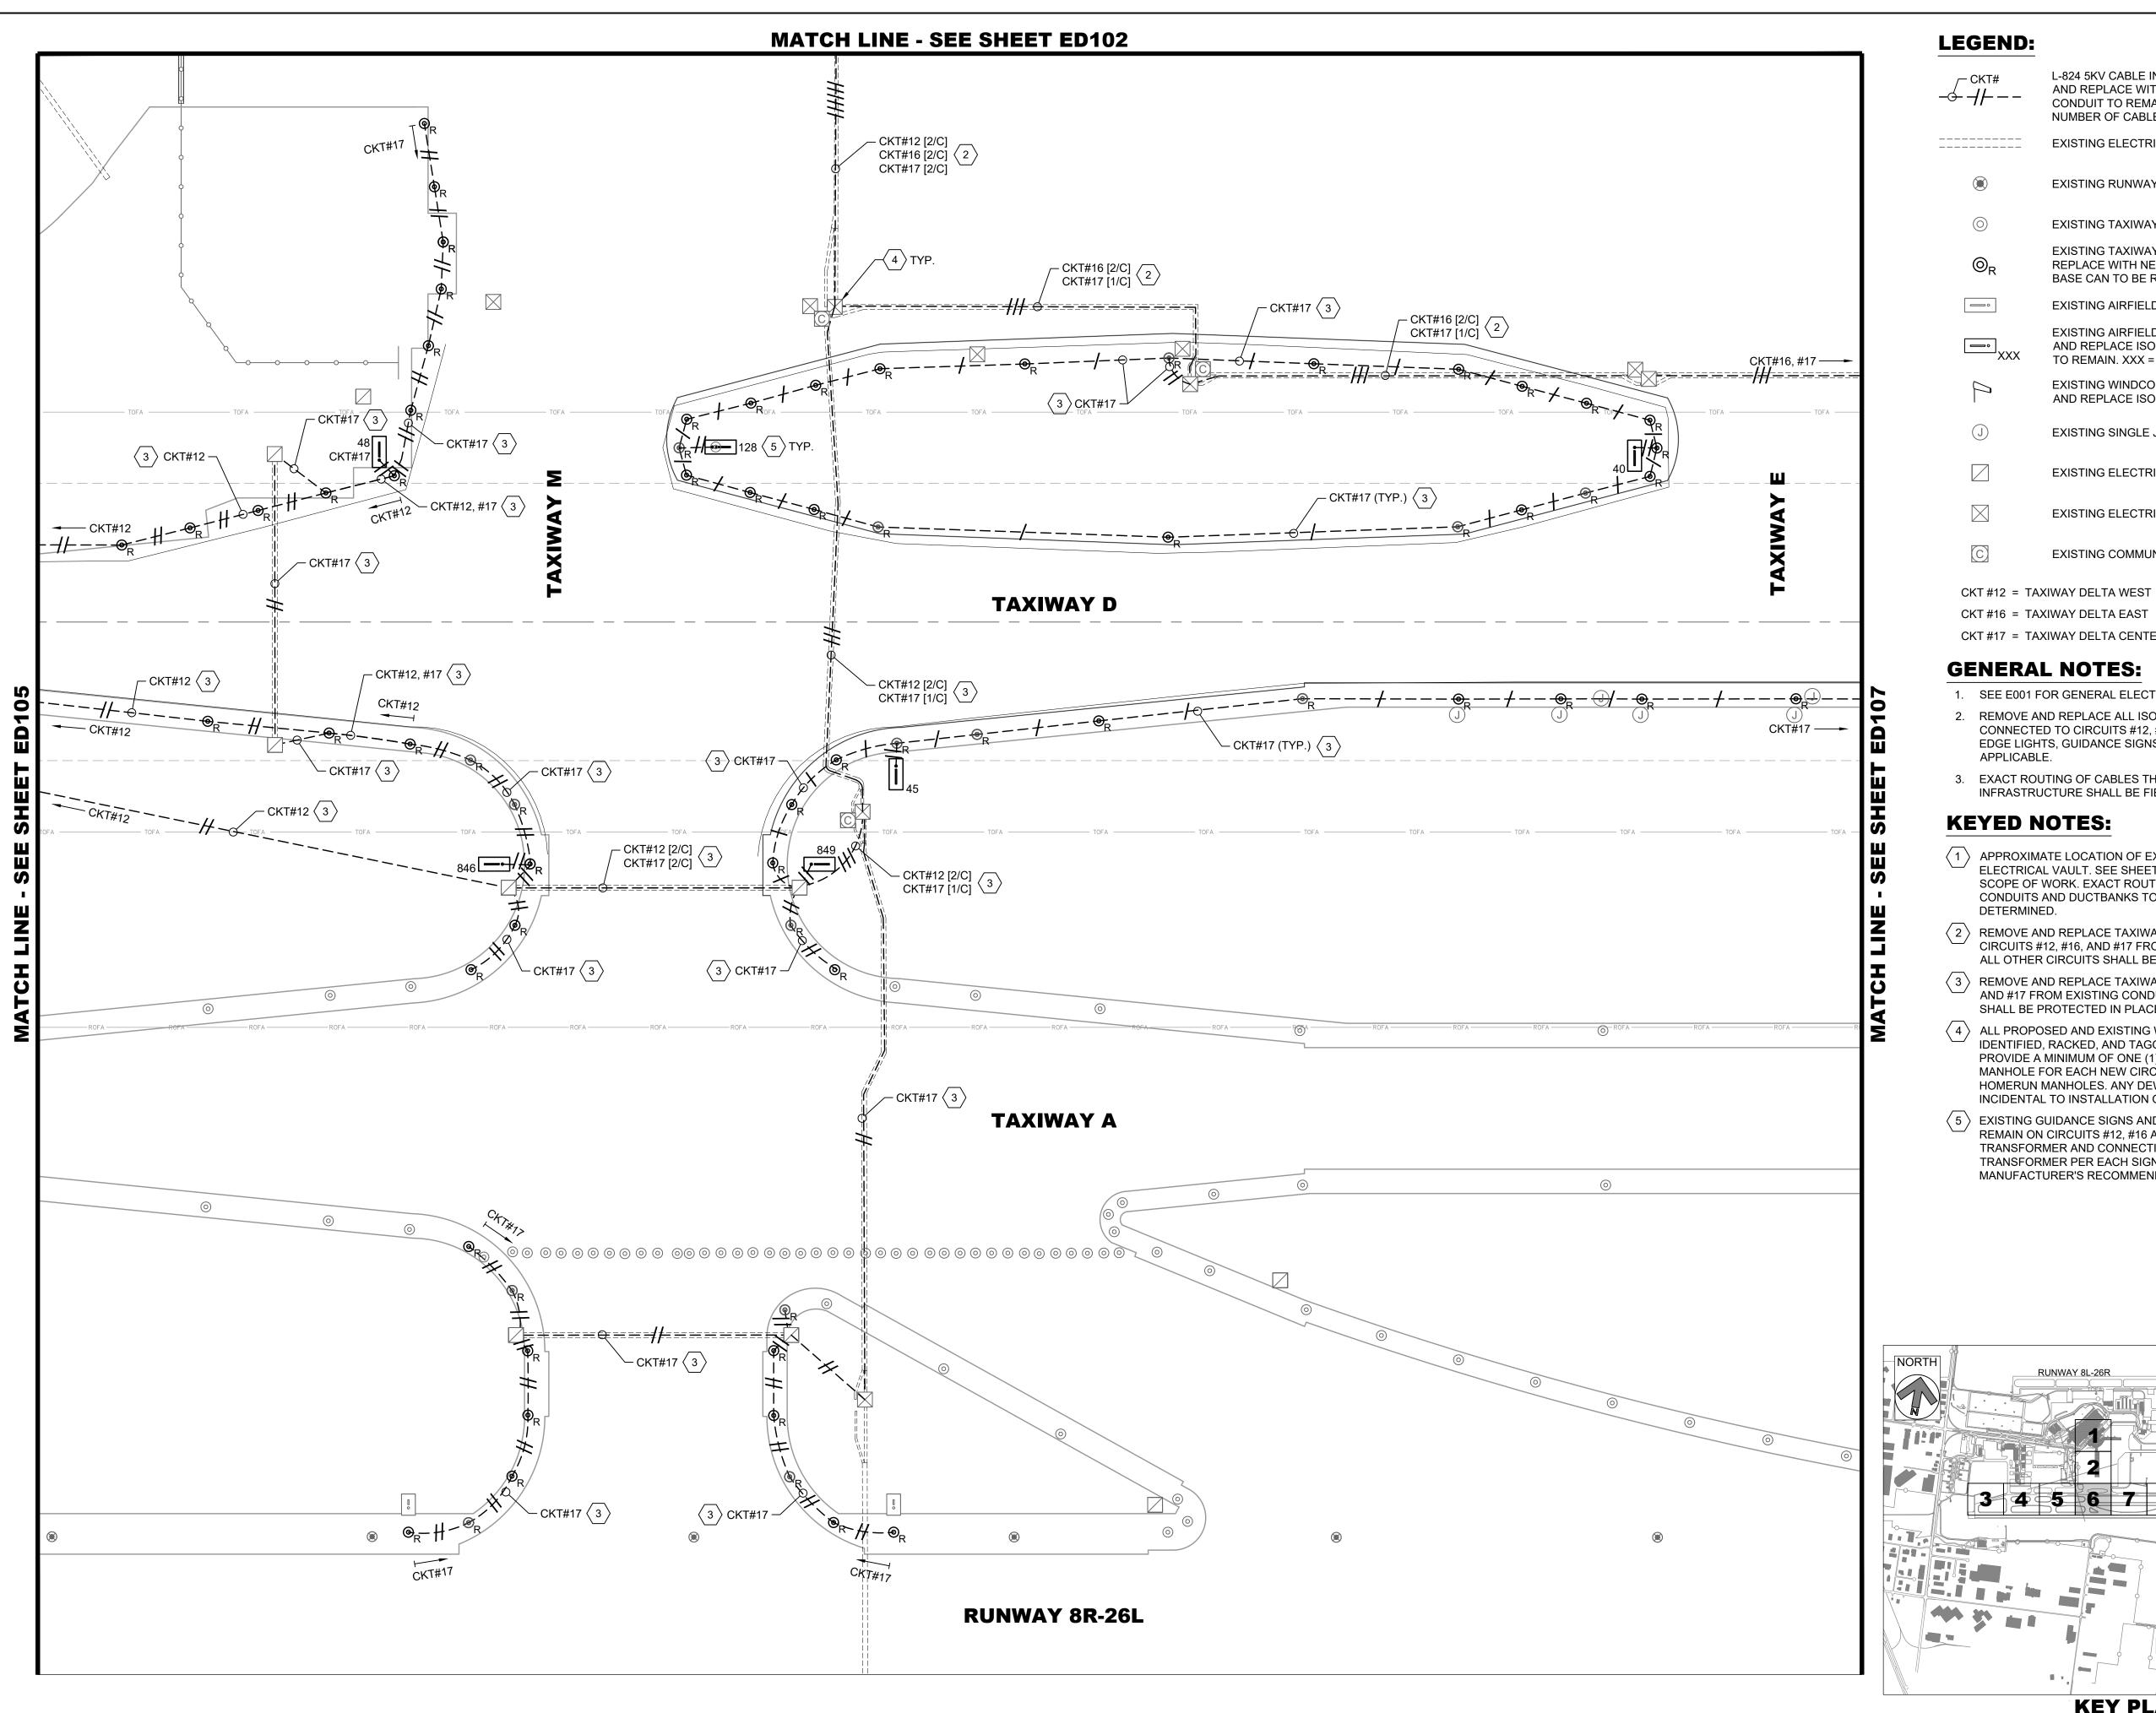


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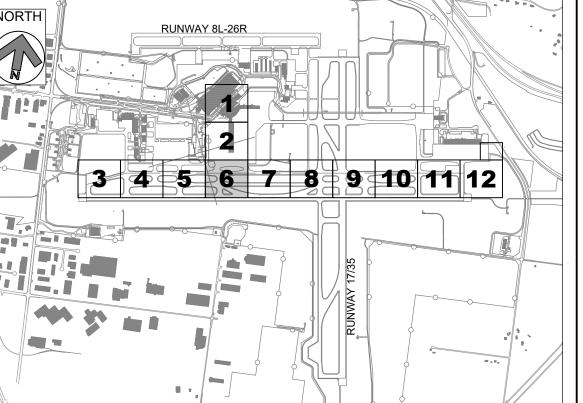
CKT #17 = TAXIWAY DELTA CENTER

- 1. SEE E001 FOR GENERAL ELECTRICAL NOTES.
- 2. REMOVE AND REPLACE ALL ISOLATION TRANSFORMERS CONNECTED TO CIRCUITS #12, #16 AND #17, AT TAXIWAY EDGE LIGHTS, GUIDANCE SIGNS AND WINDCONES, AS APPLICABLE.
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REVIEWED BY: MAR DRAWN BY: AZ DESIGNED BY: EE

> RS&H PROJECT NUMBER 1010-5865-001


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SHEET TITLE

DEMOLITION AIRFIELD LIGHTING PLAN - AREA 6

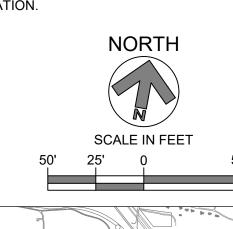SHEET NUMBER

ED106

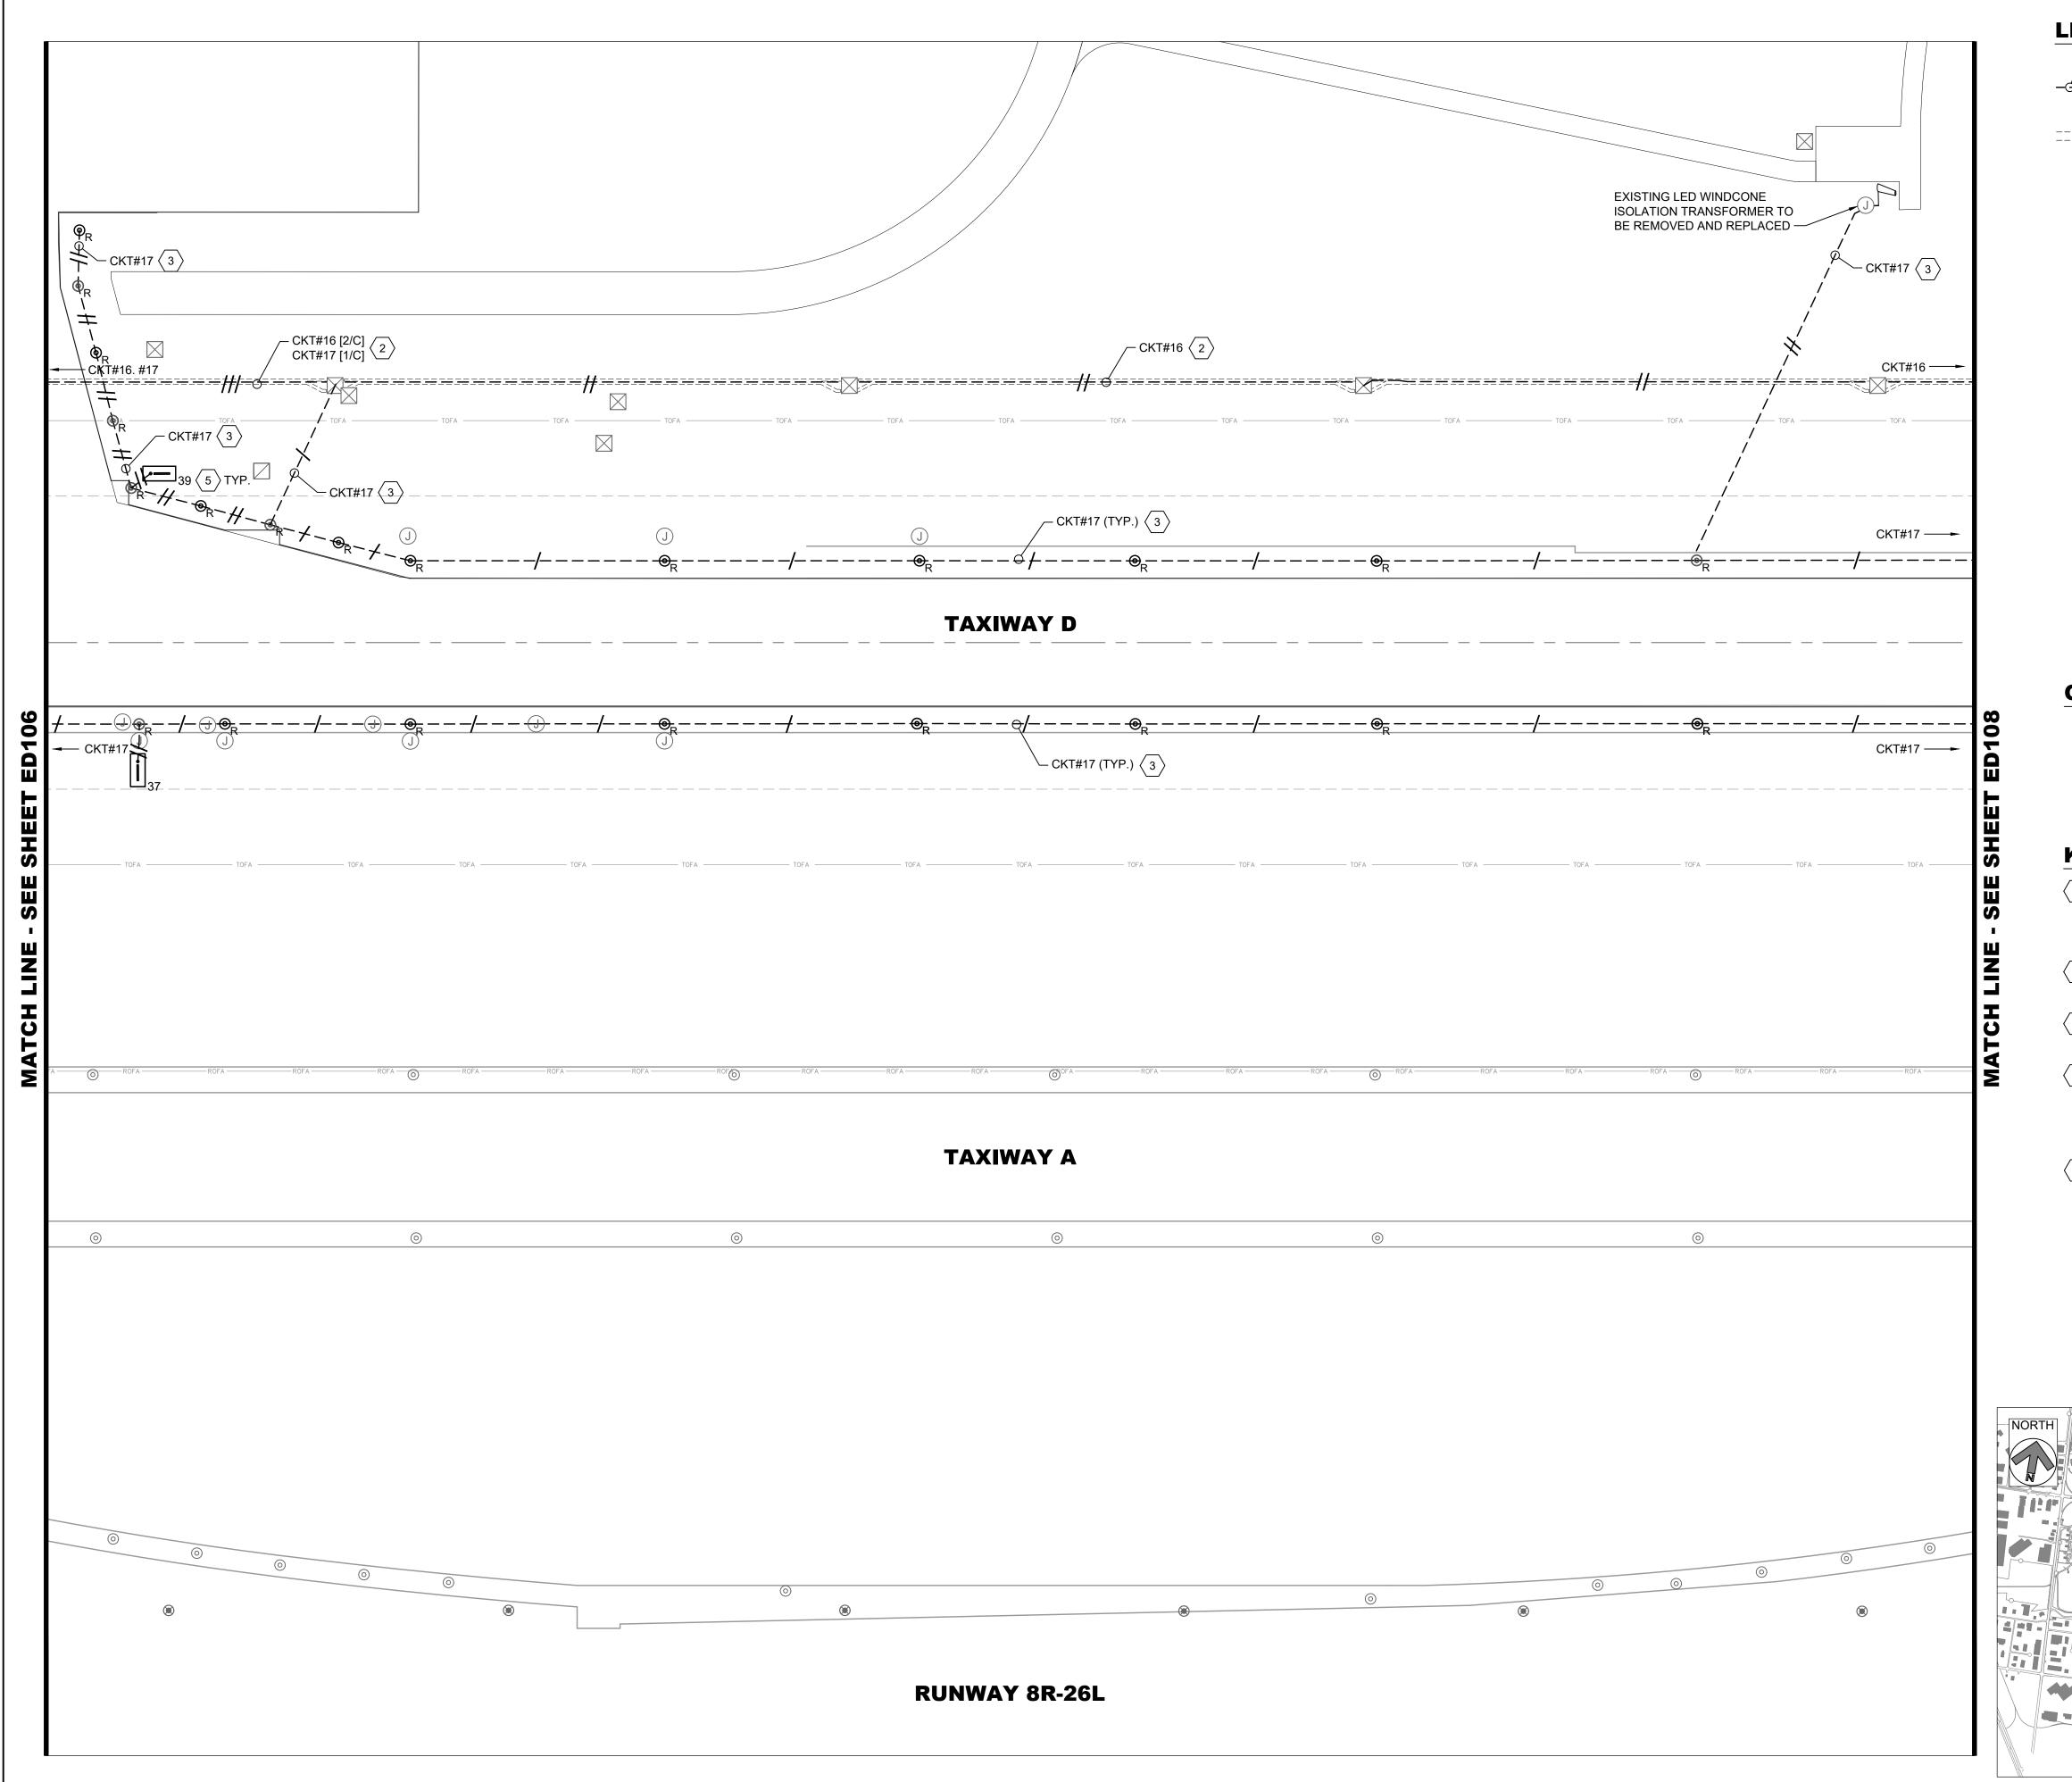

L-824 5KV CABLE IN EXISTING CONDUIT, REMOVE /-- CKT# AND REPLACE WITH NEW CABLE, EXISTING CONDUIT TO REMAIN. HASH MARKS INDICATE NUMBER OF CABLES, CKT # = CIRCUIT DESIGNATOR EXISTING ELECTRICAL DUCT BANK EXISTING RUNWAY EDGE LIGHT TO REMAIN EXISTING TAXIWAY EDGE LIGHT TO REMAIN EXISTING TAXIWAY EDGE LIGHT, REMOVE AND REPLACE WITH NEW LED FIXTURE, EXISTING BASE CAN TO BE REUSED EXISTING AIRFIELD GUIDANCE SIGN TO REMAIN EXISTING AIRFIELD GUIDANCE SIGN, REMOVE AND REPLACE ISOLATION TRANSFORMER, SIGN TO REMAIN. XXX = SIGN NUMBER EXISTING WINDCONE TO REMAIN, REMOVE AND REPLACE ISOLATION TRANSFORMER EXISTING SINGLE JUNCTION CAN TO REMAIN EXISTING ELECTRICAL HANDHOLE TO REMAIN EXISTING ELECTRICAL MANHOLE TO REMAIN EXISTING COMMUNICATIONS MANHOLE TO REMAIN CKT #12 = TAXIWAY DELTA WEST

GENERAL NOTES:


CKT #16 = TAXIWAY DELTA EAST


CKT #17 = TAXIWAY DELTA CENTER

- SEE E001 FOR GENERAL ELECTRICAL NOTES.
- 2. REMOVE AND REPLACE ALL ISOLATION TRANSFORMERS CONNECTED TO CIRCUITS #12, #16 AND #17, AT TAXIWAY EDGE LIGHTS, GUIDANCE SIGNS AND WINDCONES, AS APPLICABLE.
- 3. EXACT ROUTING OF CABLES THROUGH EXISTING INFRASTRUCTURE SHALL BE FIELD VERIFIED.

KEYED NOTES:

- APPROXIMATE LOCATION OF EXISTING AIRFIELD LIGHTING ELECTRICAL VAULT. SEE SHEETS ED201 FOR DEMOLITION SCOPE OF WORK. EXACT ROUTING OF "HOMERUN" CONDUITS AND DUCTBANKS TO VAULT SHALL BE FIELD DETERMINED.
- REMOVE AND REPLACE TAXIWAY DELTA "HOMERUN" CIRCUITS #12, #16, AND #17 FROM EXISTING DUCTBANKS. ALL OTHER CIRCUITS SHALL BE PROTECTED IN PLACE.
- REMOVE AND REPLACE TAXIWAY DELTA CIRCUITS #12, #16, AND #17 FROM EXISTING CONDUITS. ALL OTHER CIRCUITS SHALL BE PROTECTED IN PLACE.
- 4 ALL PROPOSED AND EXISTING WIRING TO BE PROPERLY IDENTIFIED, RACKED, AND TAGGED IN EACH MANHOLE. PROVIDE A MINIMUM OF ONE (1) LOOP OF WIRING IN EACH MANHOLE FOR EACH NEW CIRCUIT HOMERUN WIRE. CLEAN HOMERUN MANHOLES. ANY DEWATERING SHALL BE INCIDENTAL TO INSTALLATION OF NEW WIRING.
- EXISTING GUIDANCE SIGNS AND CONCRETE PADS TO REMAIN ON CIRCUITS #12, #16 AND #17. REPLACE ISOLATION TRANSFORMER AND CONNECTIONS. SIZE ISOLATION TRANSFORMER PER EACH SIGN LOAD, PER MANUFACTURER'S RECOMMENDATION.

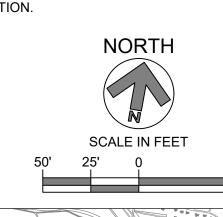

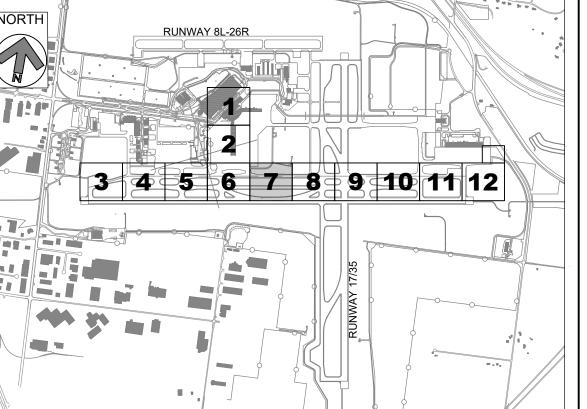

KEY PLAN

RS&H

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www.rsandh.com

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TAXIWAY D LIGHTING REHABILITATION

1-800-482-7171

REVISIONS				
NO.	DESCRI	PTION	DAT	
DAT	DATE ISSUED: MAY 2025			

DATE ISSUED: MAY 2025
REVIEWED BY: MAR
DRAWN BY: AZ
DESIGNED BY: EE

RS&H PROJECT NUMBER 1010-5865-001

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SHEET TITLE

DEMOLITION


DEMOLITION AIRFIELD LIGHTING PLAN - AREA 7

SHEET NUMBER
ED107

ISSUED FOR

BID

TTED BY: 5/30/2025
TTED BY: RAYCHERS: LOCATION:

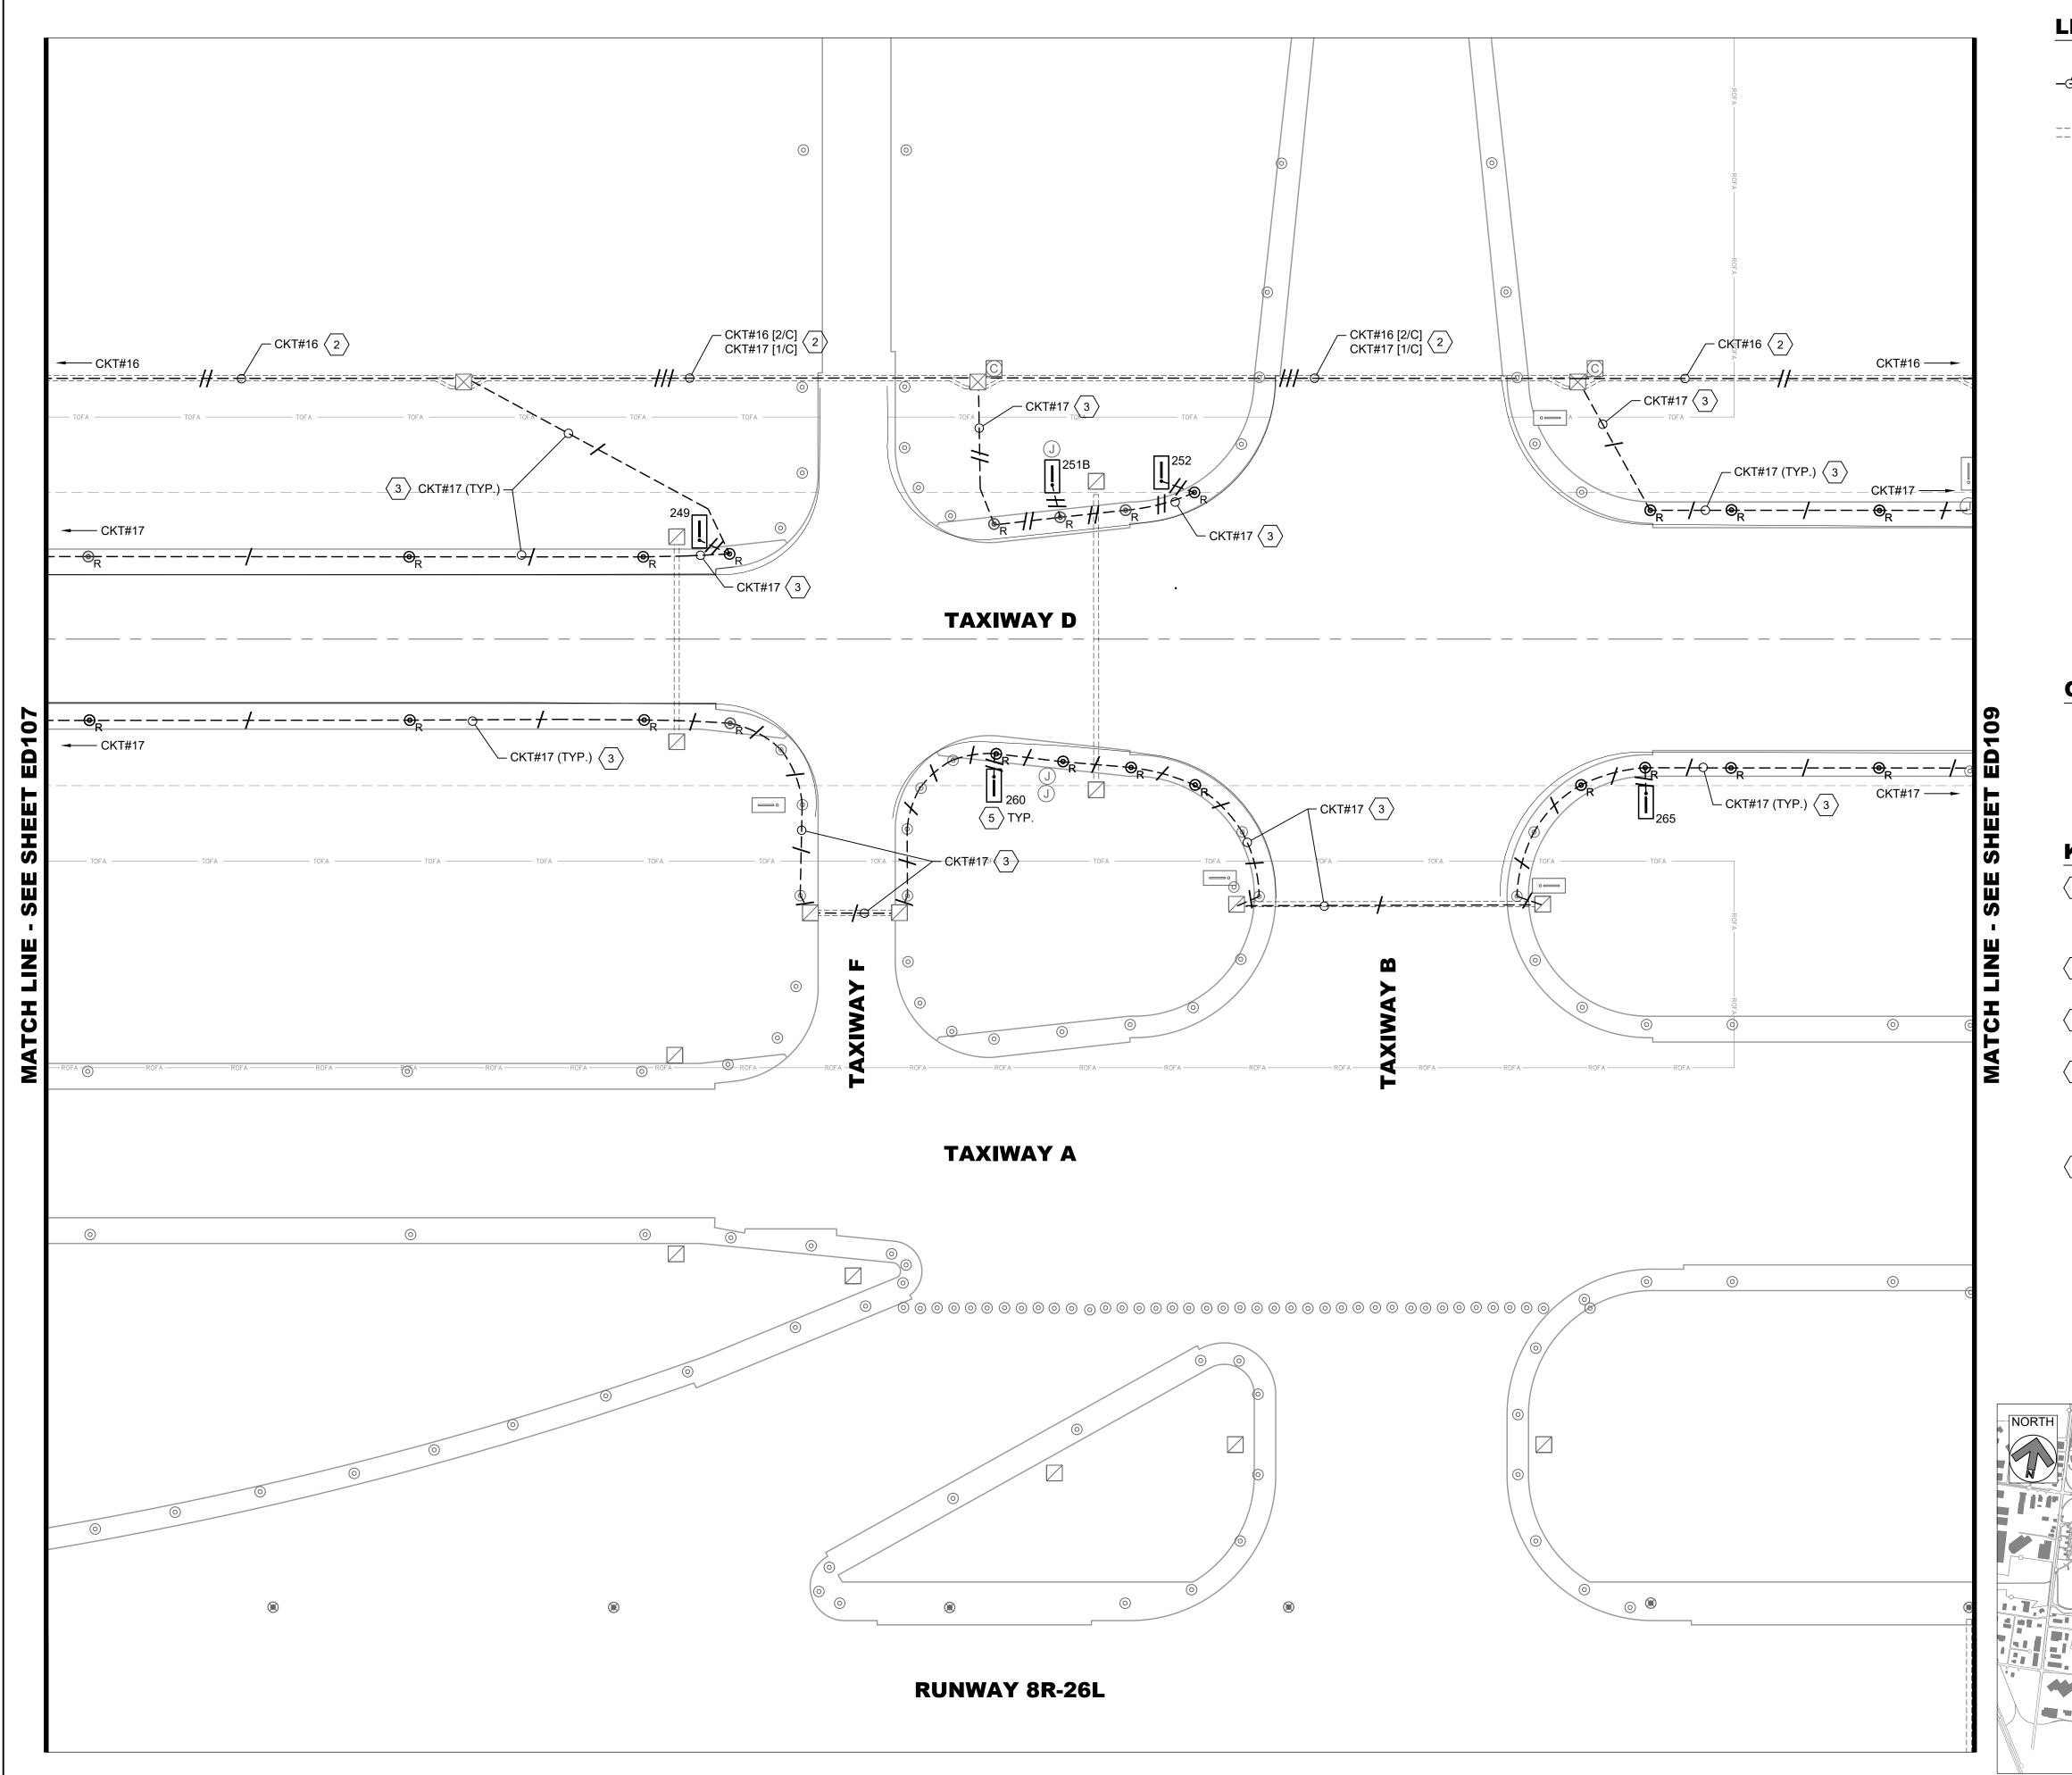

L-824 5KV CABLE IN EXISTING CONDUIT, REMOVE /-- CKT# AND REPLACE WITH NEW CABLE, EXISTING CONDUIT TO REMAIN. HASH MARKS INDICATE NUMBER OF CABLES, CKT # = CIRCUIT DESIGNATOR EXISTING ELECTRICAL DUCT BANK EXISTING RUNWAY EDGE LIGHT TO REMAIN EXISTING TAXIWAY EDGE LIGHT TO REMAIN EXISTING TAXIWAY EDGE LIGHT, REMOVE AND REPLACE WITH NEW LED FIXTURE, EXISTING BASE CAN TO BE REUSED EXISTING AIRFIELD GUIDANCE SIGN TO REMAIN EXISTING AIRFIELD GUIDANCE SIGN, REMOVE AND REPLACE ISOLATION TRANSFORMER, SIGN TO REMAIN. XXX = SIGN NUMBER EXISTING WINDCONE TO REMAIN, REMOVE AND REPLACE ISOLATION TRANSFORMER EXISTING SINGLE JUNCTION CAN TO REMAIN EXISTING ELECTRICAL HANDHOLE TO REMAIN EXISTING ELECTRICAL MANHOLE TO REMAIN

EXISTING COMMUNICATIONS MANHOLE TO REMAIN

CKT #12 = TAXIWAY DELTA WEST

CKT #16 = TAXIWAY DELTA EAST


CKT #17 = TAXIWAY DELTA CENTER


GENERAL NOTES:

- 1. SEE E001 FOR GENERAL ELECTRICAL NOTES.
- 2. REMOVE AND REPLACE ALL ISOLATION TRANSFORMERS CONNECTED TO CIRCUITS #12, #16 AND #17, AT TAXIWAY EDGE LIGHTS, GUIDANCE SIGNS AND WINDCONES, AS APPLICABLE.
- 3. EXACT ROUTING OF CABLES THROUGH EXISTING INFRASTRUCTURE SHALL BE FIELD VERIFIED.

KEYED NOTES:

- APPROXIMATE LOCATION OF EXISTING AIRFIELD LIGHTING ELECTRICAL VAULT. SEE SHEETS ED201 FOR DEMOLITION SCOPE OF WORK. EXACT ROUTING OF "HOMERUN" CONDUITS AND DUCTBANKS TO VAULT SHALL BE FIELD DETERMINED.
- 2 REMOVE AND REPLACE TAXIWAY DELTA "HOMERUN" CIRCUITS #12, #16, AND #17 FROM EXISTING DUCTBANKS. ALL OTHER CIRCUITS SHALL BE PROTECTED IN PLACE.
- REMOVE AND REPLACE TAXIWAY DELTA CIRCUITS #12, #16, AND #17 FROM EXISTING CONDUITS. ALL OTHER CIRCUITS SHALL BE PROTECTED IN PLACE.
- 4 ALL PROPOSED AND EXISTING WIRING TO BE PROPERLY IDENTIFIED, RACKED, AND TAGGED IN EACH MANHOLE. PROVIDE A MINIMUM OF ONE (1) LOOP OF WIRING IN EACH MANHOLE FOR EACH NEW CIRCUIT HOMERUN WIRE. CLEAN HOMERUN MANHOLES. ANY DEWATERING SHALL BE INCIDENTAL TO INSTALLATION OF NEW WIRING.
- EXISTING GUIDANCE SIGNS AND CONCRETE PADS TO REMAIN ON CIRCUITS #12, #16 AND #17. REPLACE ISOLATION TRANSFORMER AND CONNECTIONS. SIZE ISOLATION TRANSFORMER PER EACH SIGN LOAD, PER MANUFACTURER'S RECOMMENDATION.

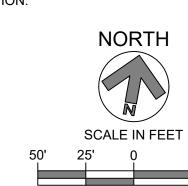

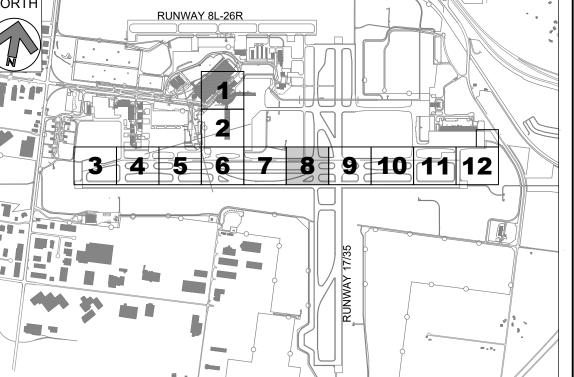

KEY PLAN

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REVISIONS			
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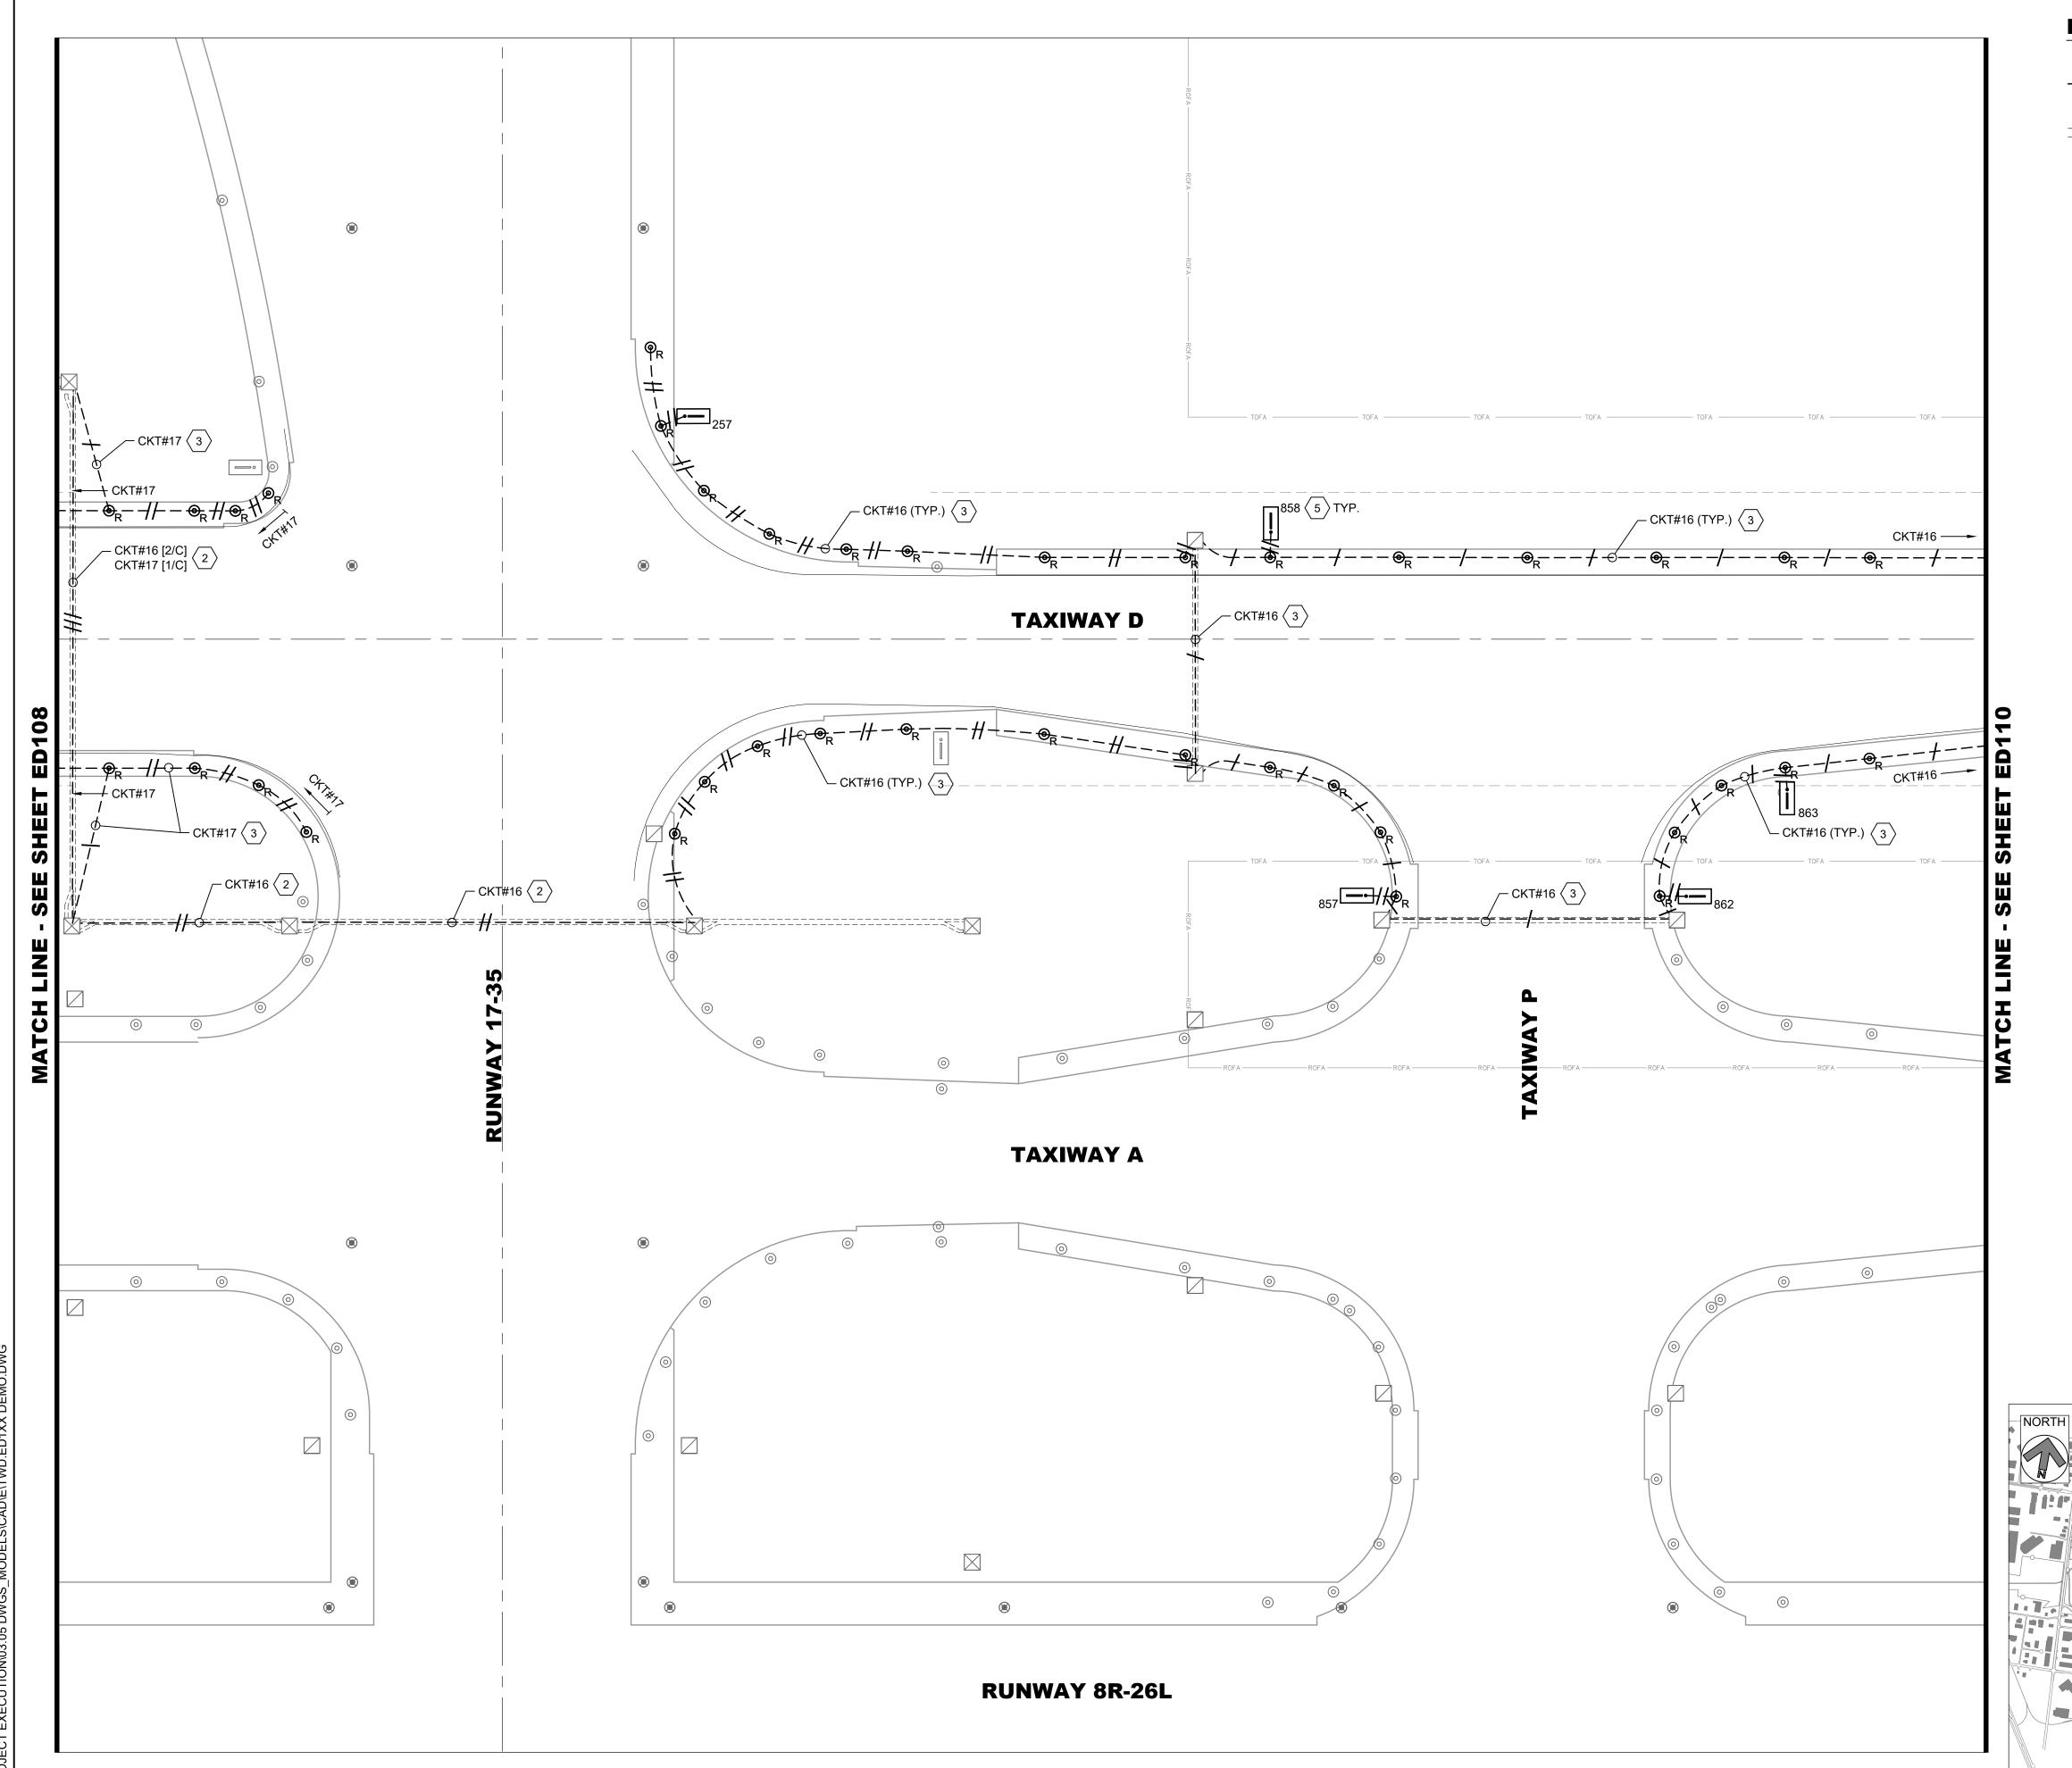
RS&H PROJECT NUMBER 1010-5865-001

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DEMOLITION AIRFIELD LIGHTING PLAN - AREA 8

SHEET NUMBER

ED108



L-824 5KV CABLE IN EXISTING CONDUIT, REMOVE /-- CKT# AND REPLACE WITH NEW CABLE, EXISTING CONDUIT TO REMAIN. HASH MARKS INDICATE NUMBER OF CABLES, CKT # = CIRCUIT DESIGNATOR EXISTING ELECTRICAL DUCT BANK EXISTING RUNWAY EDGE LIGHT TO REMAIN EXISTING TAXIWAY EDGE LIGHT TO REMAIN EXISTING TAXIWAY EDGE LIGHT, REMOVE AND REPLACE WITH NEW LED FIXTURE, EXISTING BASE CAN TO BE REUSED EXISTING AIRFIELD GUIDANCE SIGN TO REMAIN EXISTING AIRFIELD GUIDANCE SIGN, REMOVE AND REPLACE ISOLATION TRANSFORMER, SIGN TO REMAIN. XXX = SIGN NUMBER EXISTING WINDCONE TO REMAIN, REMOVE AND REPLACE ISOLATION TRANSFORMER EXISTING SINGLE JUNCTION CAN TO REMAIN EXISTING ELECTRICAL HANDHOLE TO REMAIN EXISTING ELECTRICAL MANHOLE TO REMAIN EXISTING COMMUNICATIONS MANHOLE TO REMAIN CKT #12 = TAXIWAY DELTA WEST

GENERAL NOTES:


CKT #16 = TAXIWAY DELTA EAST


CKT #17 = TAXIWAY DELTA CENTER

- 1. SEE E001 FOR GENERAL ELECTRICAL NOTES.
- 2. REMOVE AND REPLACE ALL ISOLATION TRANSFORMERS CONNECTED TO CIRCUITS #12, #16 AND #17, AT TAXIWAY EDGE LIGHTS, GUIDANCE SIGNS AND WINDCONES, AS APPLICABLE.
- 3. EXACT ROUTING OF CABLES THROUGH EXISTING INFRASTRUCTURE SHALL BE FIELD VERIFIED.

KEYED NOTES:

- 1 APPROXIMATE LOCATION OF EXISTING AIRFIELD LIGHTING ELECTRICAL VAULT. SEE SHEETS ED201 FOR DEMOLITION SCOPE OF WORK. EXACT ROUTING OF "HOMERUN" CONDUITS AND DUCTBANKS TO VAULT SHALL BE FIELD DETERMINED.
- REMOVE AND REPLACE TAXIWAY DELTA "HOMERUN" CIRCUITS #12, #16, AND #17 FROM EXISTING DUCTBANKS. ALL OTHER CIRCUITS SHALL BE PROTECTED IN PLACE.
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- EXISTING GUIDANCE SIGNS AND CONCRETE PADS TO REMAIN ON CIRCUITS #12, #16 AND #17. REPLACE ISOLATION TRANSFORMER AND CONNECTIONS. SIZE ISOLATION TRANSFORMER PER EACH SIGN LOAD, PER MANUFACTURER'S RECOMMENDATION.

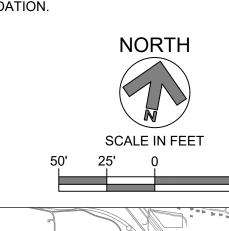

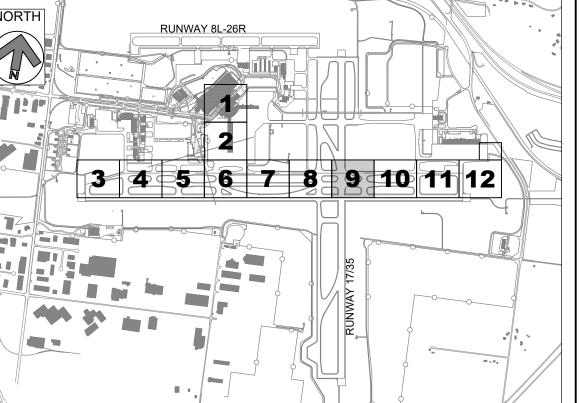

KEY PLAN

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MSS DIG System, Inc. 1-800-482-7171

REVISIONS			
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REVIEWED BY: MAR
DRAWN BY: AZ
DESIGNED BY: EE

RS&H PROJECT NUMBER 1010-5865-001

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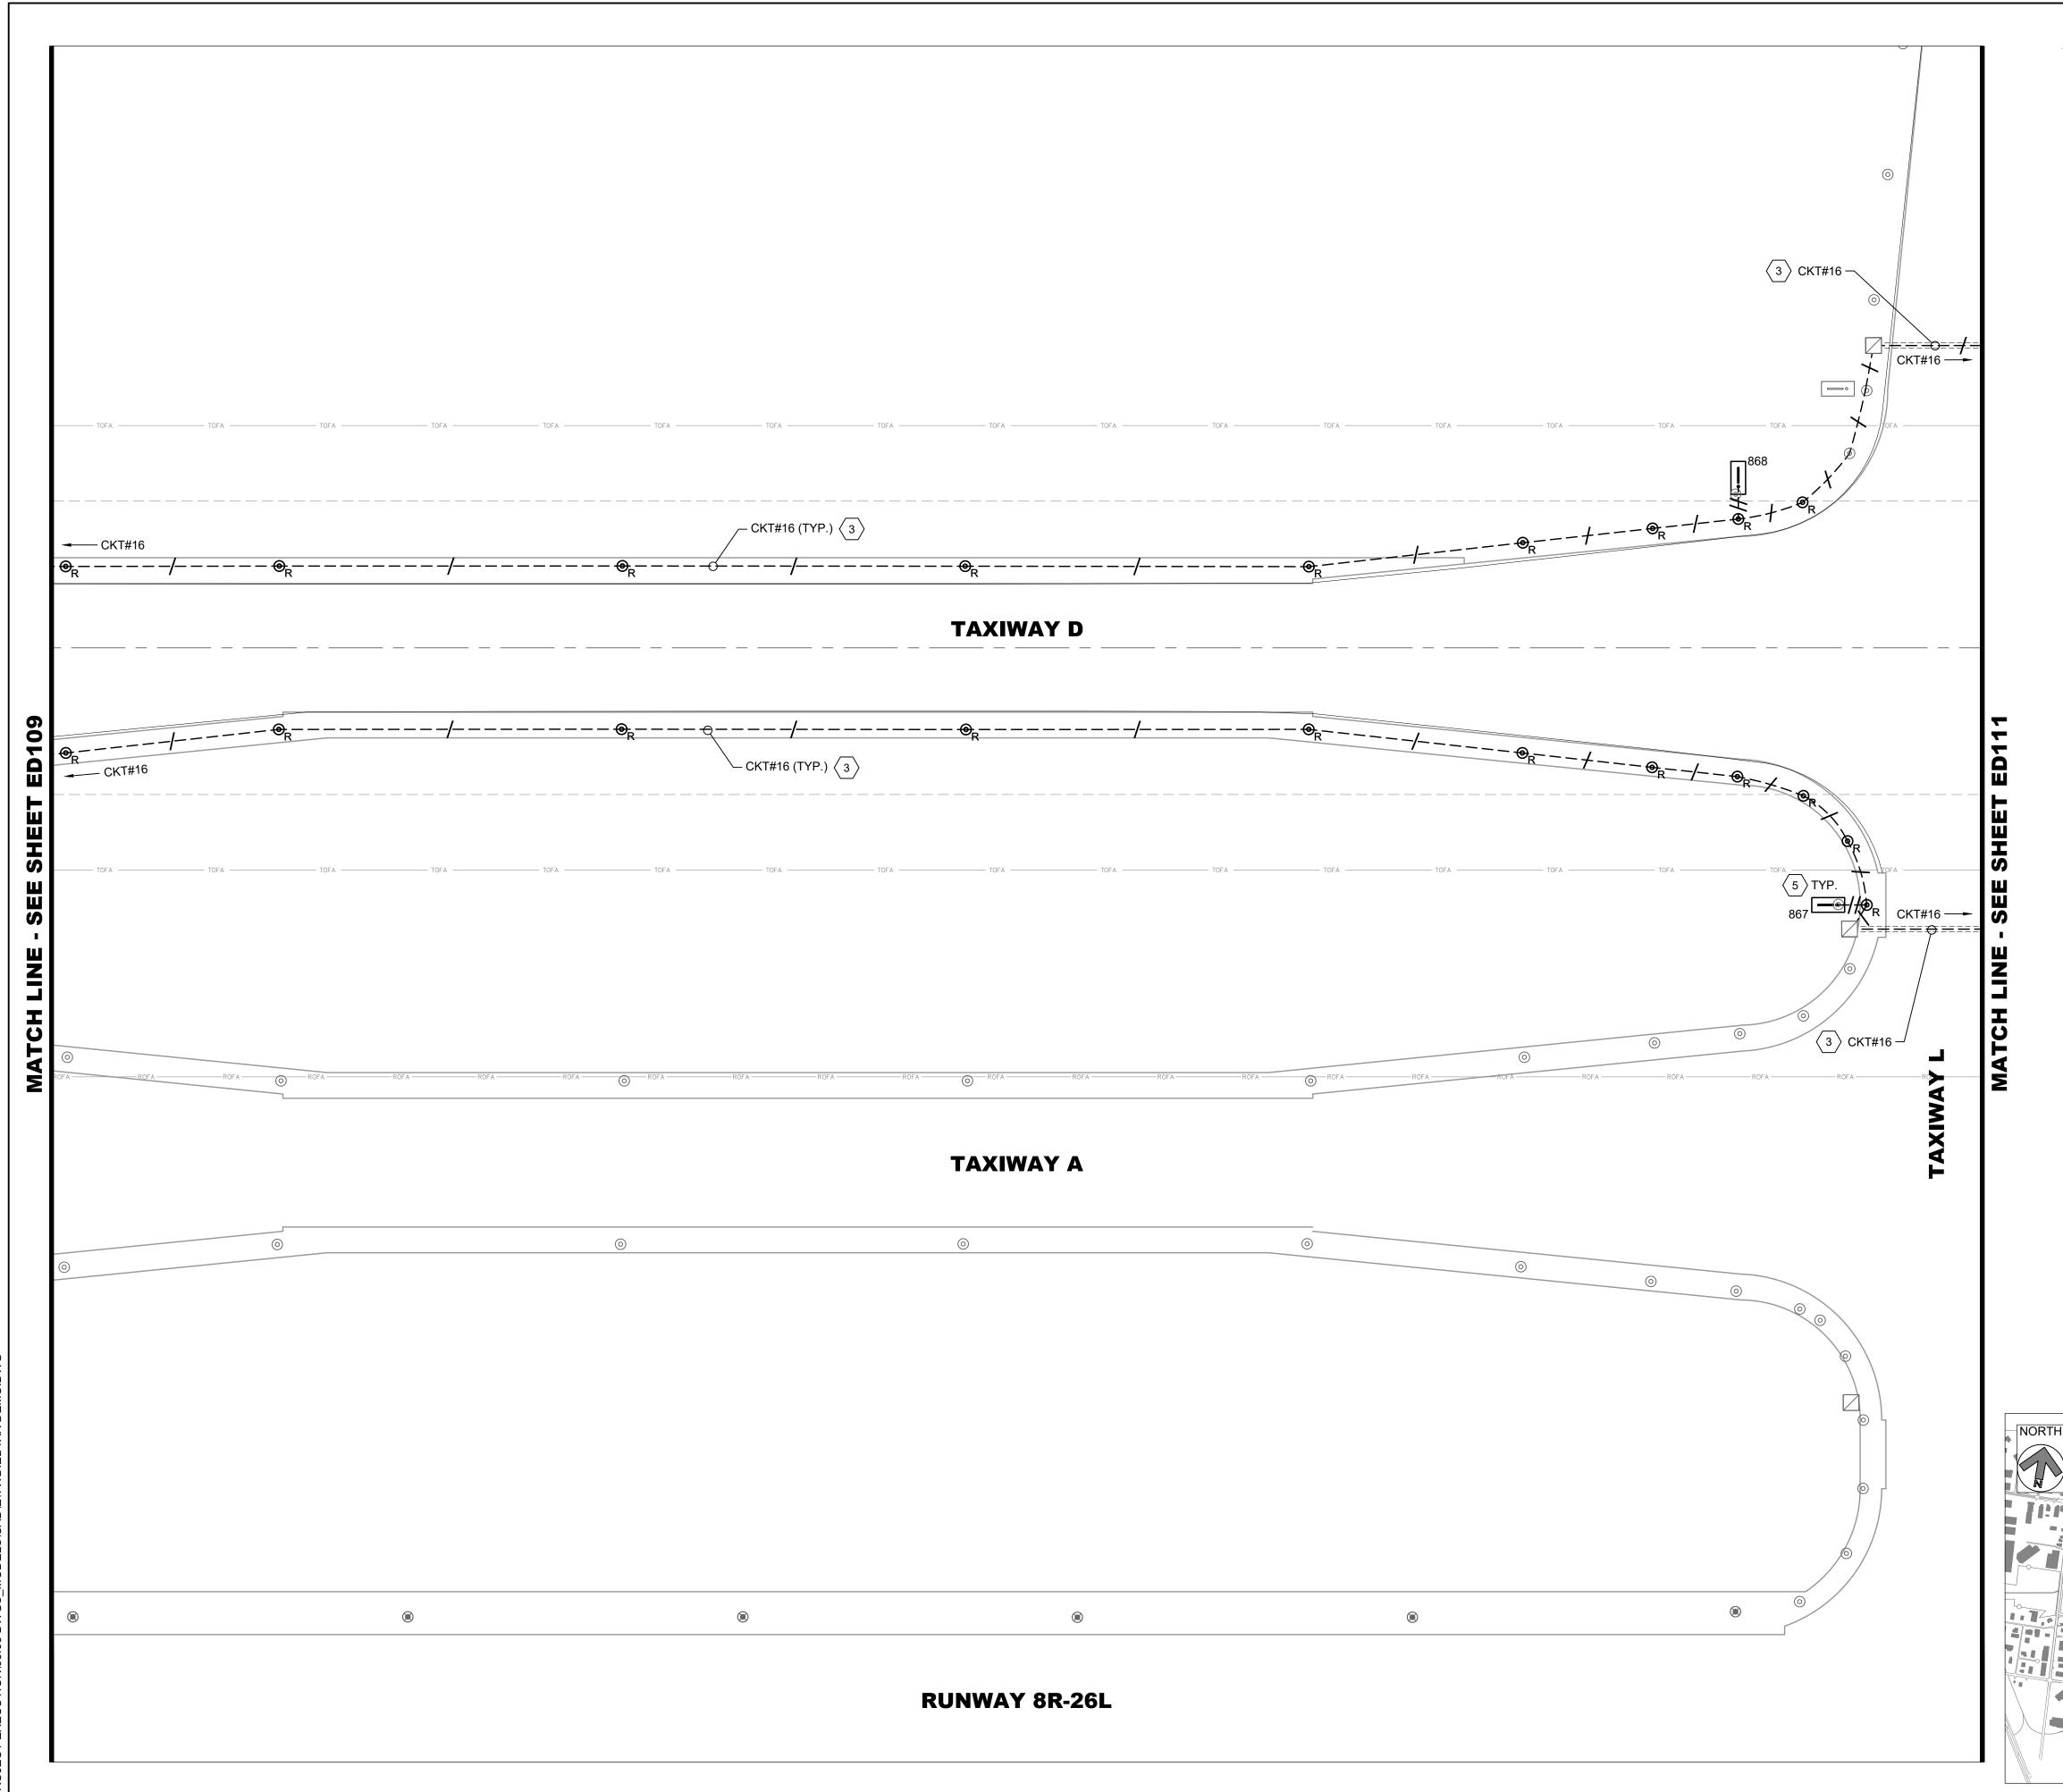
SHEET TITLE

DEMOLITION

DEMOLITION AIRFIELD LIGHTING PLAN - AREA 9

SHEET NUMBER

ED109



LEGEND: L-824 5KV CABLE IN EXISTING CONDUIT, REMOVE /-- CKT# AND REPLACE WITH NEW CABLE, EXISTING CONDUIT TO REMAIN. HASH MARKS INDICATE NUMBER OF CABLES, CKT # = CIRCUIT DESIGNATOR EXISTING ELECTRICAL DUCT BANK EXISTING RUNWAY EDGE LIGHT TO REMAIN EXISTING TAXIWAY EDGE LIGHT TO REMAIN EXISTING TAXIWAY EDGE LIGHT, REMOVE AND REPLACE WITH NEW LED FIXTURE, EXISTING BASE CAN TO BE REUSED EXISTING AIRFIELD GUIDANCE SIGN TO REMAIN EXISTING AIRFIELD GUIDANCE SIGN, REMOVE AND REPLACE ISOLATION TRANSFORMER, SIGN TO REMAIN. XXX = SIGN NUMBER EXISTING WINDCONE TO REMAIN, REMOVE AND REPLACE ISOLATION TRANSFORMER EXISTING SINGLE JUNCTION CAN TO REMAIN EXISTING ELECTRICAL HANDHOLE TO REMAIN EXISTING ELECTRICAL MANHOLE TO REMAIN EXISTING COMMUNICATIONS MANHOLE TO REMAIN CKT #12 = TAXIWAY DELTA WEST

GENERAL NOTES:


CKT #16 = TAXIWAY DELTA EAST


CKT #17 = TAXIWAY DELTA CENTER

- 1. SEE E001 FOR GENERAL ELECTRICAL NOTES.
- 2. REMOVE AND REPLACE ALL ISOLATION TRANSFORMERS CONNECTED TO CIRCUITS #12, #16 AND #17, AT TAXIWAY EDGE LIGHTS, GUIDANCE SIGNS AND WINDCONES, AS APPLICABLE.
- 3. EXACT ROUTING OF CABLES THROUGH EXISTING INFRASTRUCTURE SHALL BE FIELD VERIFIED.

KEYED NOTES:

- \langle 1 \rangle APPROXIMATE LOCATION OF EXISTING AIRFIELD LIGHTING ELECTRICAL VAULT. SEE SHEETS ED201 FOR DEMOLITION SCOPE OF WORK. EXACT ROUTING OF "HOMERUN" CONDUITS AND DUCTBANKS TO VAULT SHALL BE FIELD DETERMINED.
- (2) REMOVE AND REPLACE TAXIWAY DELTA "HOMERUN" CIRCUITS #12, #16, AND #17 FROM EXISTING DUCTBANKS. ALL OTHER CIRCUITS SHALL BE PROTECTED IN PLACE.
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- (5) EXISTING GUIDANCE SIGNS AND CONCRETE PADS TO REMAIN ON CIRCUITS #12, #16 AND #17. REPLACE ISOLATION TRANSFORMER AND CONNECTIONS. SIZE ISOLATION TRANSFORMER PER EACH SIGN LOAD, PER MANUFACTURER'S RECOMMENDATION.

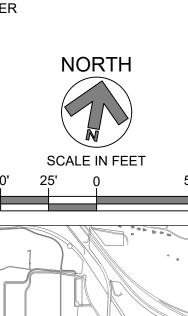

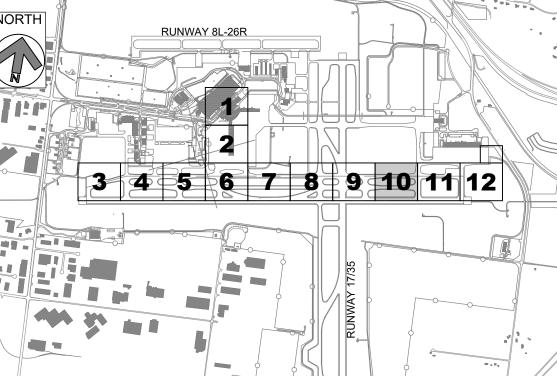

KEY PLAN

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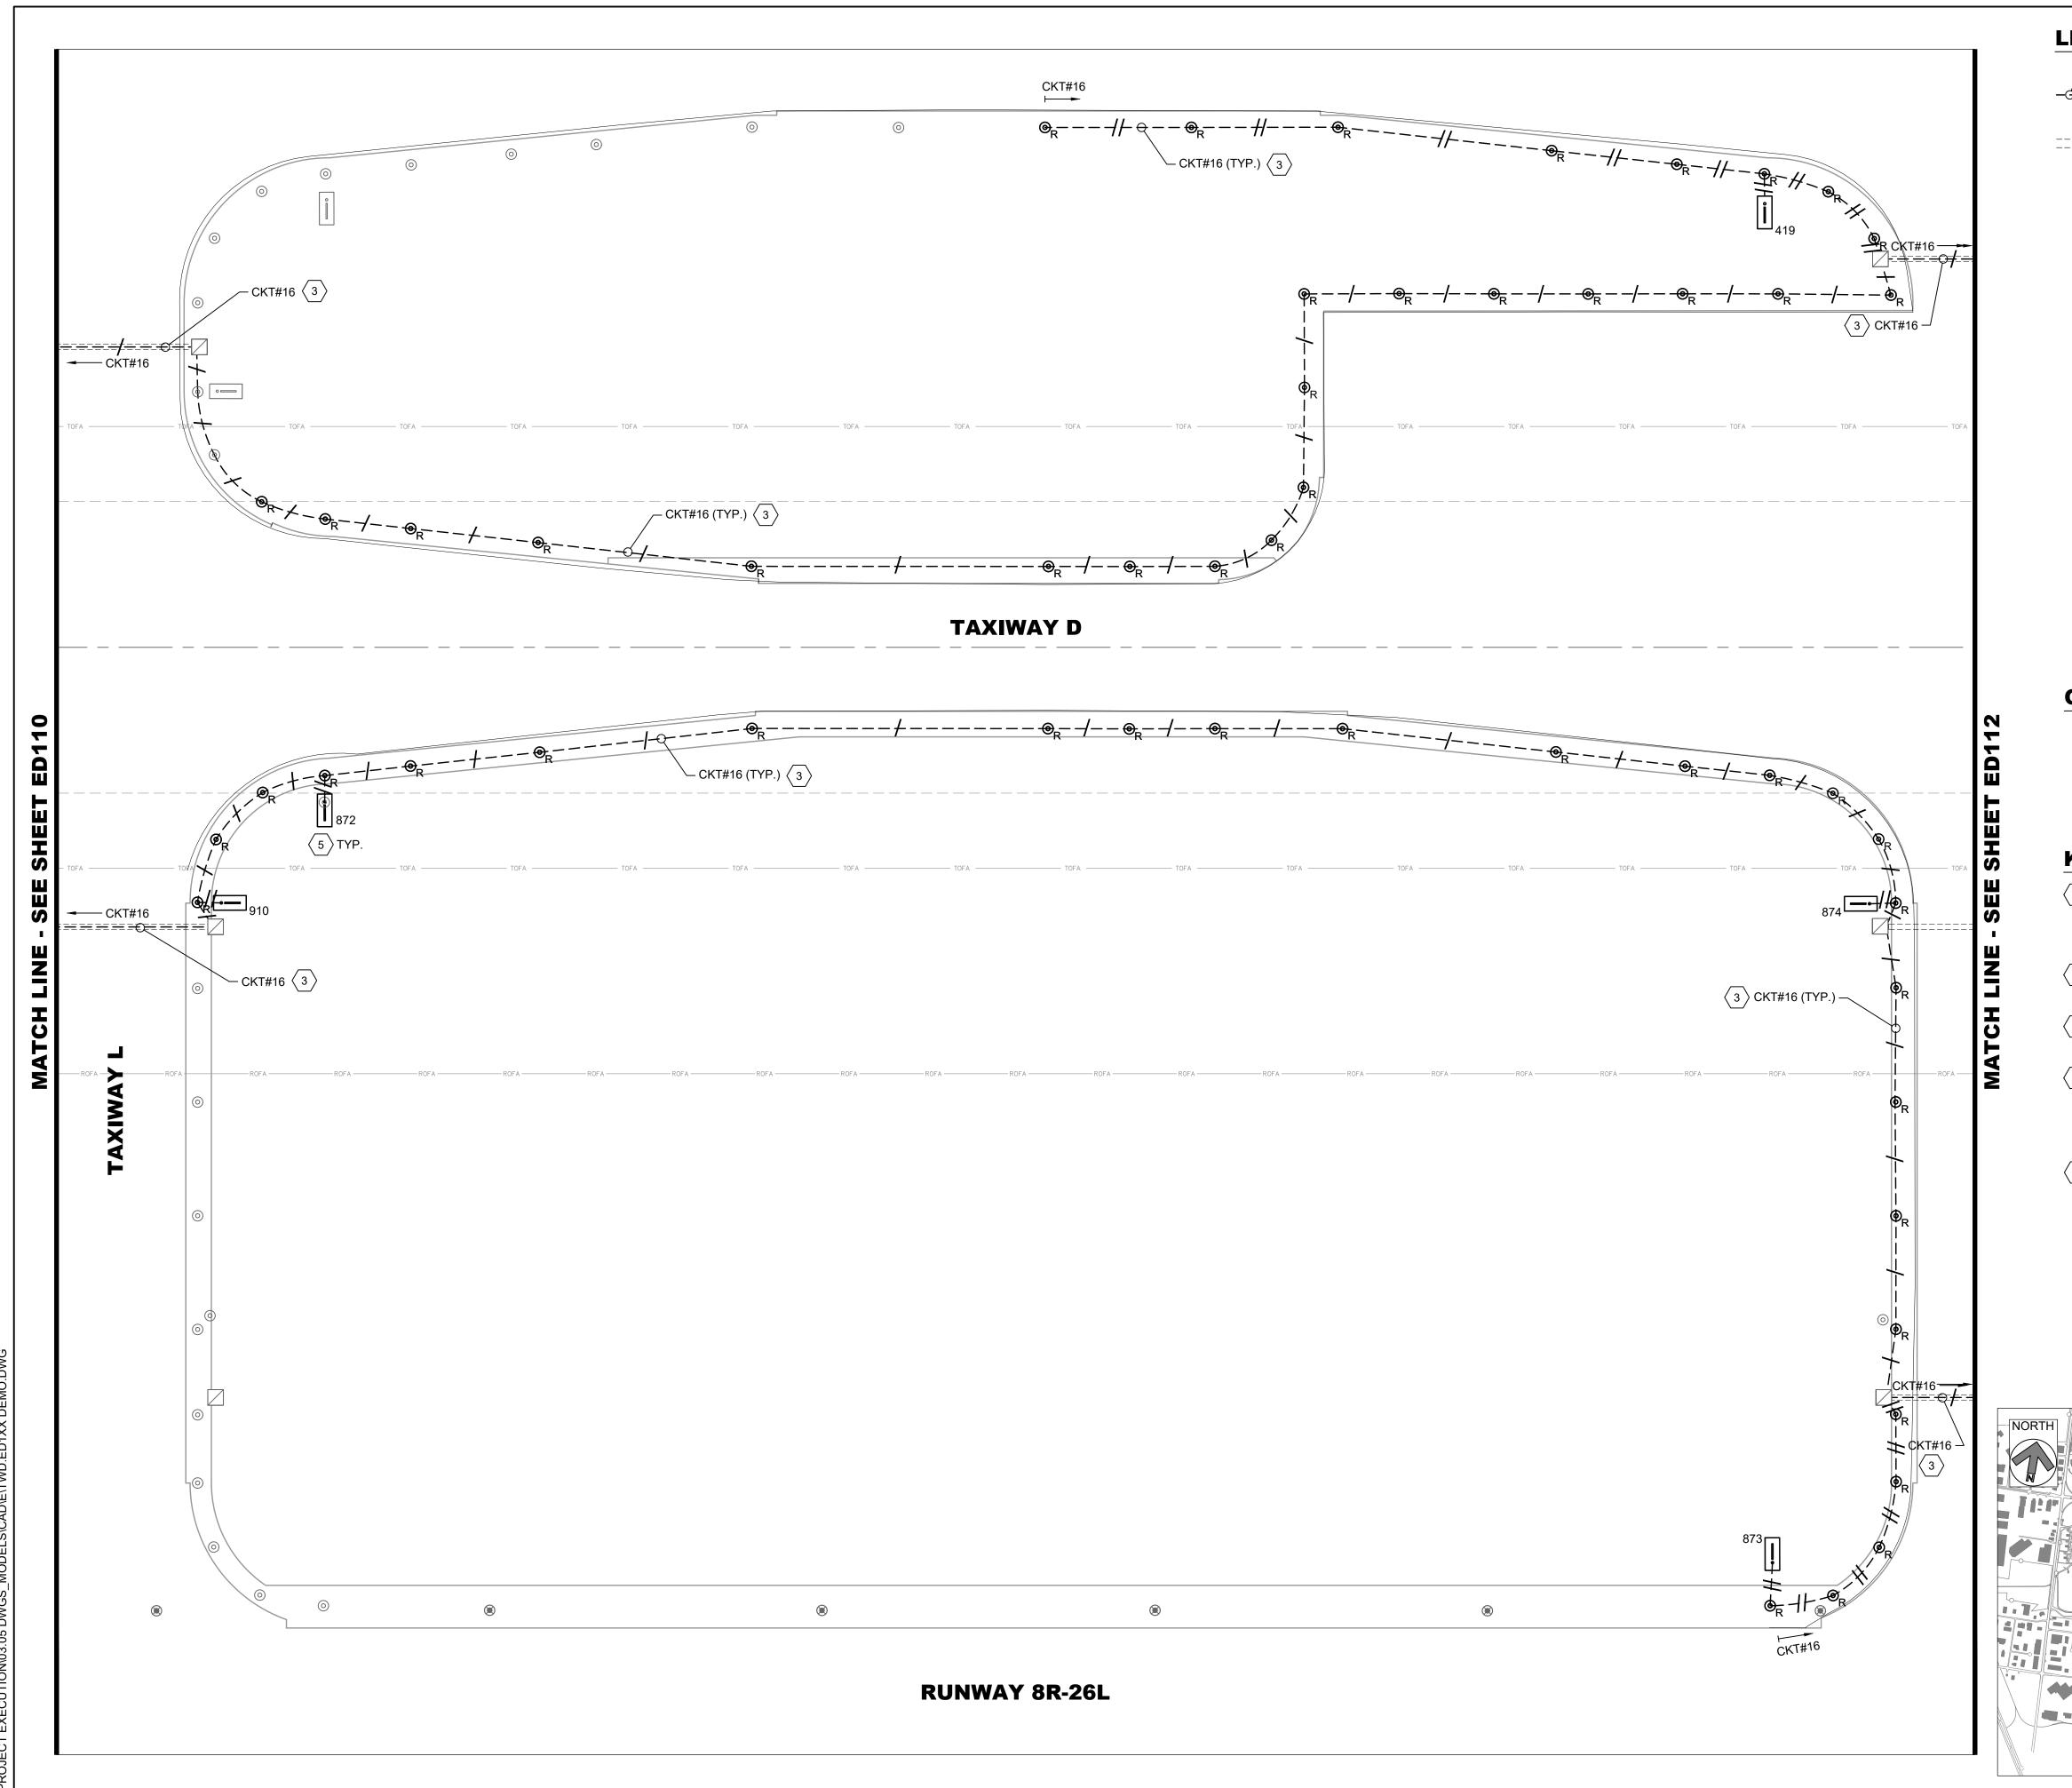
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SHEET TITLE **DEMOLITION**

AIRFIELD LIGHTING PLAN - AREA 10

SHEET NUMBER

ED110



L-824 5KV CABLE IN EXISTING CONDUIT, REMOVE /-- CKT# AND REPLACE WITH NEW CABLE, EXISTING CONDUIT TO REMAIN. HASH MARKS INDICATE NUMBER OF CABLES, CKT # = CIRCUIT DESIGNATOR EXISTING ELECTRICAL DUCT BANK EXISTING RUNWAY EDGE LIGHT TO REMAIN EXISTING TAXIWAY EDGE LIGHT TO REMAIN EXISTING TAXIWAY EDGE LIGHT, REMOVE AND REPLACE WITH NEW LED FIXTURE, EXISTING BASE CAN TO BE REUSED EXISTING AIRFIELD GUIDANCE SIGN TO REMAIN EXISTING AIRFIELD GUIDANCE SIGN, REMOVE AND REPLACE ISOLATION TRANSFORMER, SIGN TO REMAIN. XXX = SIGN NUMBER EXISTING WINDCONE TO REMAIN, REMOVE AND REPLACE ISOLATION TRANSFORMER EXISTING SINGLE JUNCTION CAN TO REMAIN EXISTING ELECTRICAL HANDHOLE TO REMAIN EXISTING ELECTRICAL MANHOLE TO REMAIN EXISTING COMMUNICATIONS MANHOLE TO REMAIN

GENERAL NOTES:

CKT #12 = TAXIWAY DELTA WEST


CKT #16 = TAXIWAY DELTA EAST


CKT #17 = TAXIWAY DELTA CENTER

- 1. SEE E001 FOR GENERAL ELECTRICAL NOTES.
- 2. REMOVE AND REPLACE ALL ISOLATION TRANSFORMERS CONNECTED TO CIRCUITS #12, #16 AND #17, AT TAXIWAY EDGE LIGHTS, GUIDANCE SIGNS AND WINDCONES, AS APPLICABLE.
- 3. EXACT ROUTING OF CABLES THROUGH EXISTING INFRASTRUCTURE SHALL BE FIELD VERIFIED.

KEYED NOTES:

- APPROXIMATE LOCATION OF EXISTING AIRFIELD LIGHTING ELECTRICAL VAULT. SEE SHEETS ED201 FOR DEMOLITION SCOPE OF WORK. EXACT ROUTING OF "HOMERUN" CONDUITS AND DUCTBANKS TO VAULT SHALL BE FIELD DETERMINED.
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- REMOVE AND REPLACE TAXIWAY DELTA CIRCUITS #12, #16, AND #17 FROM EXISTING CONDUITS. ALL OTHER CIRCUITS SHALL BE PROTECTED IN PLACE.
- 4 ALL PROPOSED AND EXISTING WIRING TO BE PROPERLY IDENTIFIED, RACKED, AND TAGGED IN EACH MANHOLE. PROVIDE A MINIMUM OF ONE (1) LOOP OF WIRING IN EACH MANHOLE FOR EACH NEW CIRCUIT HOMERUN WIRE. CLEAN HOMERUN MANHOLES. ANY DEWATERING SHALL BE INCIDENTAL TO INSTALLATION OF NEW WIRING.
- 5 EXISTING GUIDANCE SIGNS AND CONCRETE PADS TO REMAIN ON CIRCUITS #12, #16 AND #17. REPLACE ISOLATION TRANSFORMER AND CONNECTIONS. SIZE ISOLATION TRANSFORMER PER EACH SIGN LOAD, PER MANUFACTURER'S RECOMMENDATION.

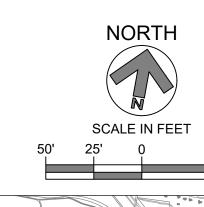

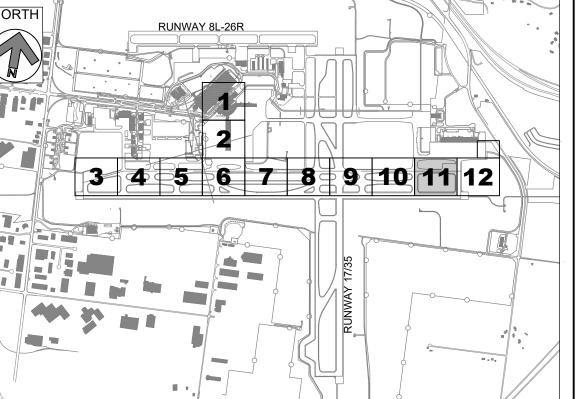

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DATE	DATE ISSUED: MAY 2025		

REVIEWED BY: MAR

DRAWN BY: AZ

DESIGNED BY: EE

RS&H PROJECT NUMBER 1010-5865-001

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SHEET TITLE

DEMOLITION

DEMOLITION
AIRFIELD
LIGHTING PLAN
- AREA 11

SHEET NUMBER

ED111

L-824 5KV CABLE IN EXISTING CONDUIT, REMOVE
AND REPLACE WITH NEW CABLE, EXISTING
CONDUIT TO REMAIN. HASH MARKS INDICATE
NUMBER OF CABLES, CKT # = CIRCUIT DESIGNATOR

EXISTING ELECTRICAL DUCT BANK

EXISTING RUNWAY EDGE LIGHT TO REMAIN

EXISTING TAXIWAY EDGE LIGHT TO REMAIN

BASE CAN TO BE REUSED

EXISTING AIRFIELD GUIDANCE SIGN TO REMAIN

EXISTING TAXIWAY EDGE LIGHT, REMOVE AND REPLACE WITH NEW LED FIXTURE, EXISTING

EXISTING AIRFIELD GUIDANCE SIGN, REMOVE
AND REPLACE ISOLATION TRANSFORMER, SIGN
TO REMAIN. XXX = SIGN NUMBER

EXISTING WINDCONE TO REMAIN, REMOVE

AND REPLACE ISOLATION TRANSFORMER

EXISTING WINDCONE TO REMAIN, REMOVE AND REPLACE ISOLATION TRANSFORMER

EXISTING WINDCONE TO REMAIN, REMOVE AND REPLACE ISOLATION TRANSFORMER

Z EXISTING ELECTRICAL HANDHOLE TO REMAIN

EXISTING ELECTRICAL MANHOLE TO REMAIN

EXISTING COMMUNICATIONS MANHOLE TO REMAIN

CKT #12 = TAXIWAY DELTA WEST
CKT #16 = TAXIWAY DELTA EAST


CKT #17 = TAXIWAY DELTA CENTER

GENERAL NOTES:

- 1. SEE E001 FOR GENERAL ELECTRICAL NOTES.
- REMOVE AND REPLACE ALL ISOLATION TRANSFORMERS CONNECTED TO CIRCUITS #12, #16 AND #17, AT TAXIWAY EDGE LIGHTS, GUIDANCE SIGNS AND WINDCONES, AS APPLICABLE.
- 3. EXACT ROUTING OF CABLES THROUGH EXISTING INFRASTRUCTURE SHALL BE FIELD VERIFIED.

KEYED NOTES:

- APPROXIMATE LOCATION OF EXISTING AIRFIELD LIGHTING ELECTRICAL VAULT. SEE SHEETS ED201 FOR DEMOLITION SCOPE OF WORK. EXACT ROUTING OF "HOMERUN" CONDUITS AND DUCTBANKS TO VAULT SHALL BE FIELD DETERMINED.
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- 5 EXISTING GUIDANCE SIGNS AND CONCRETE PADS TO REMAIN ON CIRCUITS #12, #16 AND #17. REPLACE ISOLATION TRANSFORMER AND CONNECTIONS. SIZE ISOLATION TRANSFORMER PER EACH SIGN LOAD, PER MANUFACTURER'S RECOMMENDATION.

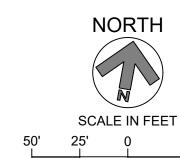

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KEY PLAN

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MSS DIG System, Inc. 1-800-482-7171

REVISIONS			
NO.	DESCRIPTION	DATE	
DATE	ISSUED: MAY 20	25	

DATE ISSUED: MAY 2025
REVIEWED BY: MAR
DRAWN BY: AZ
DESIGNED BY: EE

RS&H PROJECT NUMBER 1010-5865-001

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SHEET TITLE

DEMOLITION AIRFIELD LIGHTING PLAN - AREA 12

SHEET NUMBER

ED112

PROPOSED L-824 5KV CABLE IN EXISTING CONDUIT /-- CKT# HASH MARKS INDICATE NUMBER OF NEW L-824 CABLES INSTALLED IN EXISTING CONDUIT, CKT # = CIRCUIT DESIGNATOR EXISTING ELECTRICAL DUCT BANK EXISTING RUNWAY EDGE LIGHT TO REMAIN EXISTING TAXIWAY EDGE LIGHT TO REMAIN PROPOSED L-861T(L) ELEVATED OMNI-DIRECTIONAL MEDIUM INTENSITY TAXIWAY EDGE LIGHT (MITL)

INSTALLED ON EXISTING BASE CAN

EXISTING AIRFIELD GUIDANCE SIGN TO REMAIN

EXISTING ELECTRICAL HANDHOLE TO REMAIN

EXISTING AIRFIELD GUIDANCE SIGN, PROVIDE NEW ISOLATION TRANSFORMER, SIGN TO REMAIN. XXX = SIGN NUMBER

EXISTING WINDCONE TO REMAIN, PROVIDE NEW ISOLATION TRANSFORMER

EXISTING SINGLE JUNCTION CAN TO REMAIN

EXISTING ELECTRICAL MANHOLE TO REMAIN

EXISTING COMMUNICATIONS MANHOLE TO REMAIN

CKT #12 = TAXIWAY DELTA WEST

CKT #16 = TAXIWAY DELTA EAST


CKT #17 = TAXIWAY DELTA CENTER

GENERAL NOTES:

- 1. SEE E001 FOR GENERAL ELECTRICAL NOTES.
- 2. PROVIDE NEW ISOLATION TRANSFORMERS CONNECTED TO CIRCUITS #12, #16 AND #17, AT TAXIWAY EDGE LIGHTS, GUIDANCE SIGNS AND WINDCONES, AS APPLICABLE.
- 3. EXACT ROUTING OF CABLES THROUGH EXISTING INFRASTRUCTURE SHALL BE FIELD VERIFIED.
- 4. ALL CIRCUIT FEEDERS TO GUIDANCE SIGNS SHALL CONSIST OF 2/C L-824 5KV CABLES.

KEYED NOTES:

- (1) APPROXIMATE LOCATION OF EXISTING AIRFIELD LIGHTING ELECTRICAL VAULT. SEE SHEET E201 FOR PROPOSED SCOPE OF WORK. EXACT ROUTING OF "HOMERUN" CONDUITS AND DUCTBANKS TO VAULT SHALL BE FIELD DETERMINED.
- (2) TAXIWAY DELTA "HOMERUN" CABLES IN EXISTING DUCTBANK. PROPOSED L-824 CABLES FOR CIRCUITS #12, #16, AND #17 SHALL BE INSTALLED IN EXISTING CONDUIT. ALL OTHER CIRCUITS SHALL BE PROTECTED IN PLACE.
- (3) TAXIWAY DELTA CABLES IN EXISTING CONDUIT. PROPOSED L-824 5KV CABLES FOR CIRCUITS #12, #16, AND #17, AS MARKED, SHALL BE INSTALLED IN EXISTING CONDUITS. ALL OTHER CIRCUITS SHALL BE PROTECTED IN PLACE.
- \langle 4 \rangle ALL PROPOSED AND EXISTING WIRING TO BE PROPERLY IDENTIFIED, RACKED, AND TAGGED IN EACH MANHOLE. PROVIDE A MINIMUM OF ONE (1) LOOP OF WIRING IN EACH MANHOLE FOR EACH NEW CIRCUIT HOMERUN WIRE. CLEAN HOMERUN MANHOLES. ANY DEWATERING SHALL BE INCIDENTAL TO INSTALLATION OF NEW WIRING.
- \langle 5 \rangle EXISTING GUIDANCE SIGNS AND CONCRETE PADS TO REMAIN ON CIRCUITS #12, #16 AND #17. PROVIDE NEW ISOLATION TRANSFORMER AND CONNECTIONS. SIZE ISOLATION TRANSFORMER PER EACH SIGN LOAD, PER MANUFACTURER'S RECOMMENDATION.

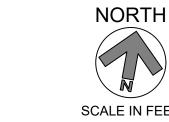

SCALE IN FEET

RS&H PROJECT NUMBER 1010-5865-001

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DATE ISSUED: MAY 2025 REVIEWED BY: MAR

DRAWN BY: AZ DESIGNED BY: EE

RS&H Michigan, Inc.

436 S. MAIN STREET PLYMOUTH, MICHIGAN 48170 PH: 734-456-7060

FAX: 1-800-464-4358 www.rsandh.com

GERALD R. FORD

INTERNATIONAL AIRPORT

TAXIWAY D

LIGHTING

REHABILITATION

1-800-482-7171

NO. DESCRIPTION DATE

REVISIONS

SHEET TITLE

PROPOSED AIRFIELD LIGHTING PLAN-AREA 1


SHEET NUMBER

E101

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KEY PLAN



RSSH

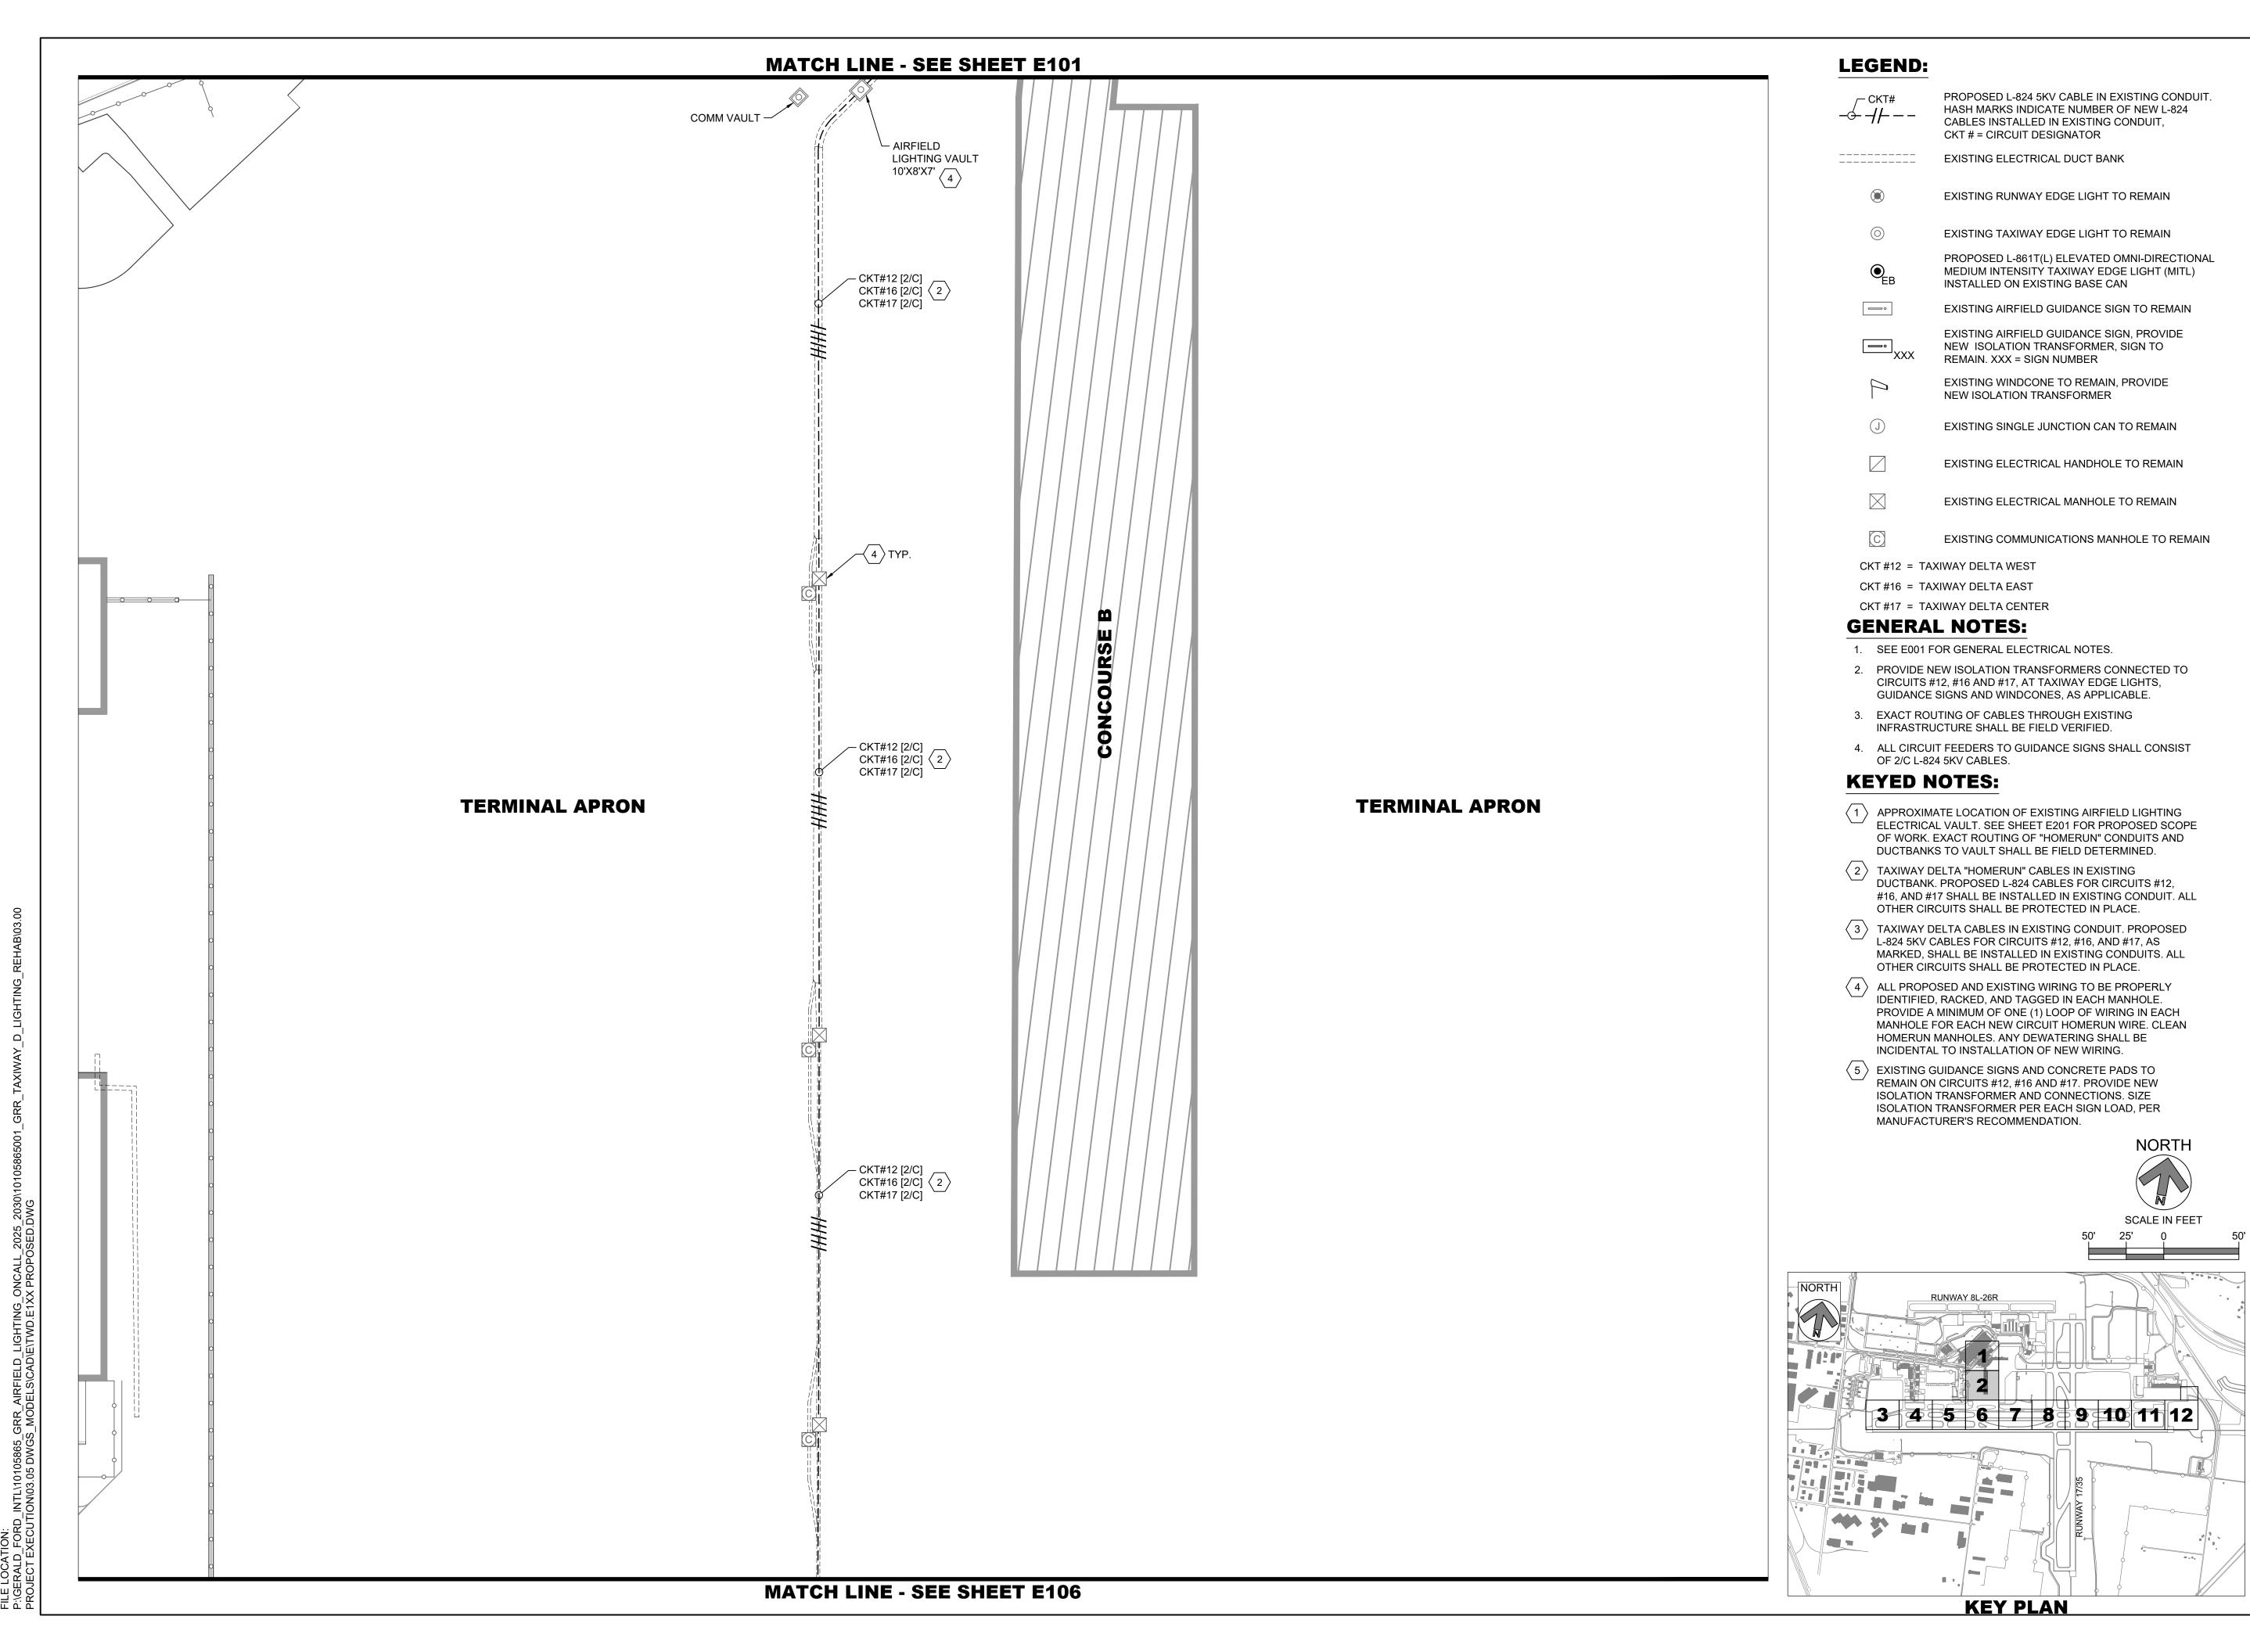RS&H Michigan, Inc.

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TAXIWAY D LIGHTING REHABILITATION

1-800-482-7171

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DATE ISSUED: MAY 2025
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RS&H PROJECT NUMBER 1010-5865-001


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SHEET TITLE

PROPOSED
AIRFIELD
LIGHTING PLANAREA 2

SHEET NUMBER

E102

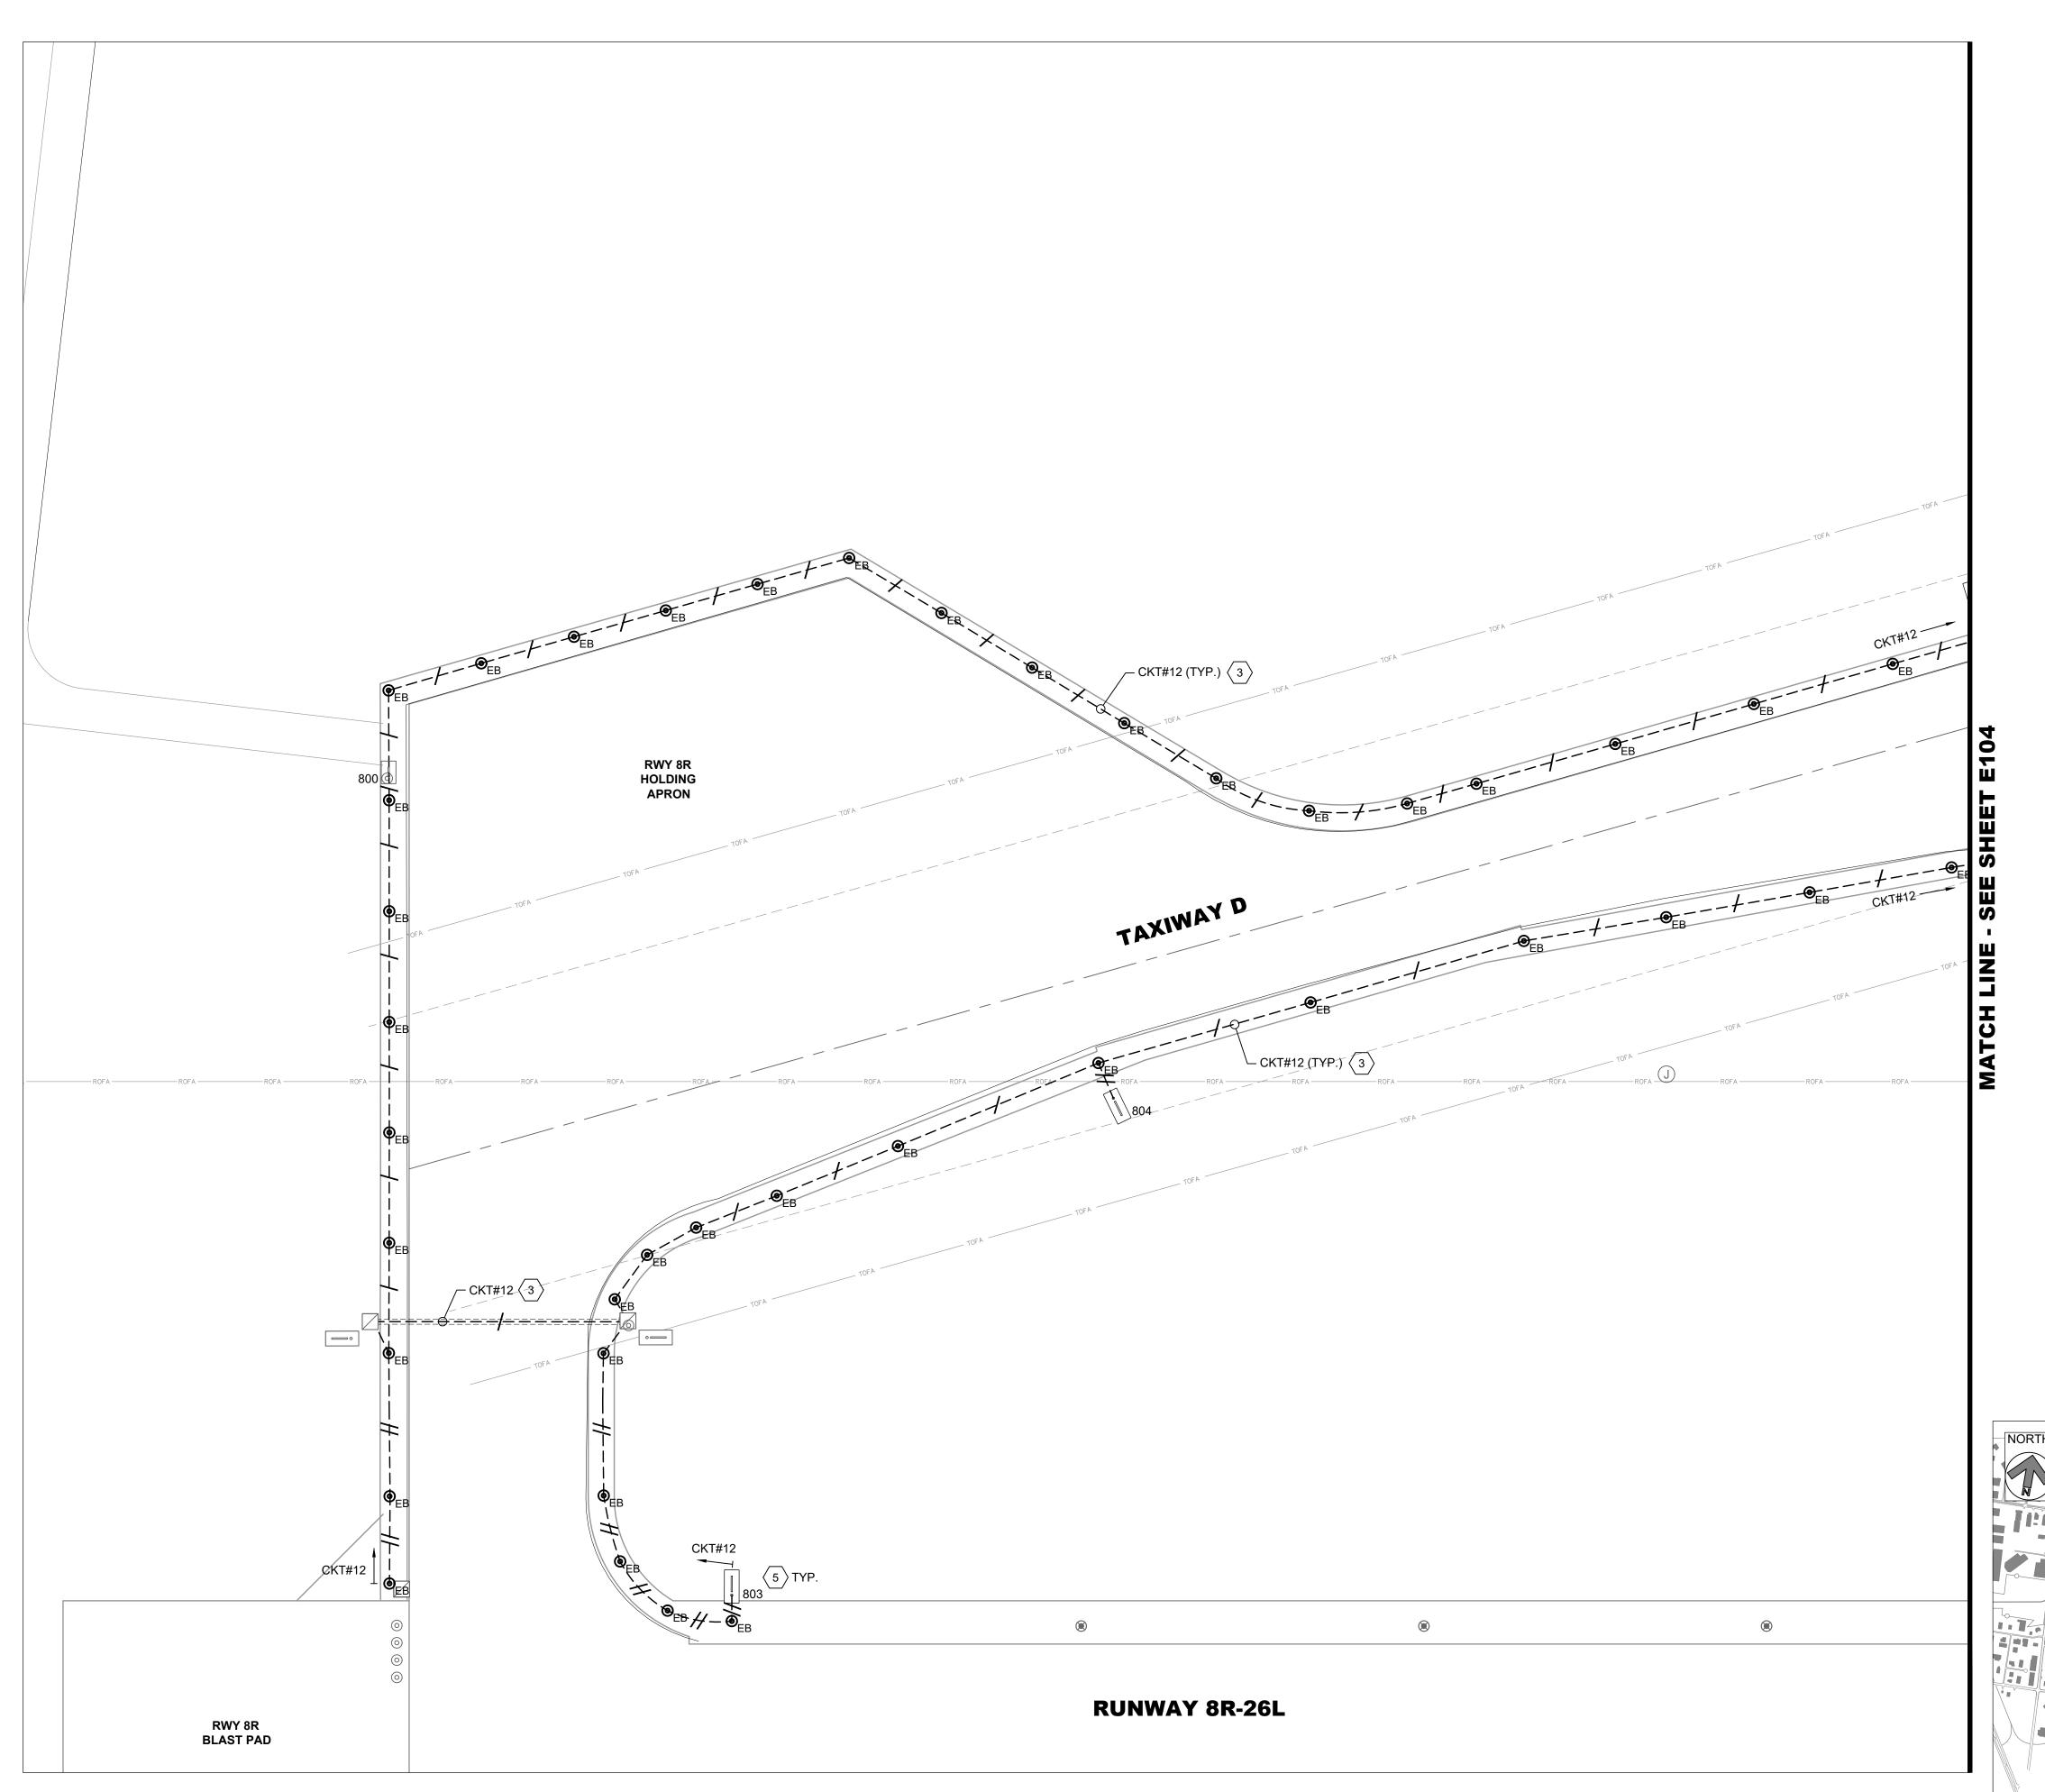

LEGEND: PROPOSED L-824 5KV CABLE IN EXISTING CONDUIT. /-- CKT# HASH MARKS INDICATE NUMBER OF NEW L-824 CABLES INSTALLED IN EXISTING CONDUIT, CKT # = CIRCUIT DESIGNATOR EXISTING ELECTRICAL DUCT BANK EXISTING RUNWAY EDGE LIGHT TO REMAIN EXISTING TAXIWAY EDGE LIGHT TO REMAIN PROPOSED L-861T(L) ELEVATED OMNI-DIRECTIONAL MEDIUM INTENSITY TAXIWAY EDGE LIGHT (MITL) INSTALLED ON EXISTING BASE CAN EXISTING AIRFIELD GUIDANCE SIGN TO REMAIN EXISTING AIRFIELD GUIDANCE SIGN, PROVIDE NEW ISOLATION TRANSFORMER, SIGN TO REMAIN. XXX = SIGN NUMBER EXISTING WINDCONE TO REMAIN, PROVIDE NEW ISOLATION TRANSFORMER EXISTING SINGLE JUNCTION CAN TO REMAIN EXISTING ELECTRICAL HANDHOLE TO REMAIN EXISTING ELECTRICAL MANHOLE TO REMAIN EXISTING COMMUNICATIONS MANHOLE TO REMAIN

CKT #12 = TAXIWAY DELTA WEST CKT #16 = TAXIWAY DELTA EAST

CKT #17 = TAXIWAY DELTA CENTER

GENERAL NOTES:


- 1. SEE E001 FOR GENERAL ELECTRICAL NOTES.
- 2. PROVIDE NEW ISOLATION TRANSFORMERS CONNECTED TO CIRCUITS #12, #16 AND #17, AT TAXIWAY EDGE LIGHTS, GUIDANCE SIGNS AND WINDCONES, AS APPLICABLE.
- 3. EXACT ROUTING OF CABLES THROUGH EXISTING INFRASTRUCTURE SHALL BE FIELD VERIFIED.
- 4. ALL CIRCUIT FEEDERS TO GUIDANCE SIGNS SHALL CONSIST OF 2/C L-824 5KV CABLES.

KEYED NOTES:

- (1) APPROXIMATE LOCATION OF EXISTING AIRFIELD LIGHTING ELECTRICAL VAULT. SEE SHEET E201 FOR PROPOSED SCOPE OF WORK. EXACT ROUTING OF "HOMERUN" CONDUITS AND DUCTBANKS TO VAULT SHALL BE FIELD DETERMINED.
- \langle 2 \rangle TAXIWAY DELTA "HOMERUN" CABLES IN EXISTING DUCTBANK. PROPOSED L-824 CABLES FOR CIRCUITS #12, #16, AND #17 SHALL BE INSTALLED IN EXISTING CONDUIT. ALL OTHER CIRCUITS SHALL BE PROTECTED IN PLACE.
- (3) TAXIWAY DELTA CABLES IN EXISTING CONDUIT. PROPOSED L-824 5KV CABLES FOR CIRCUITS #12, #16, AND #17, AS MARKED, SHALL BE INSTALLED IN EXISTING CONDUITS. ALL OTHER CIRCUITS SHALL BE PROTECTED IN PLACE.
- \langle 4 \rangle ALL PROPOSED AND EXISTING WIRING TO BE PROPERLY IDENTIFIED, RACKED, AND TAGGED IN EACH MANHOLE. PROVIDE A MINIMUM OF ONE (1) LOOP OF WIRING IN EACH MANHOLE FOR EACH NEW CIRCUIT HOMERUN WIRE. CLEAN HOMERUN MANHOLES. ANY DEWATERING SHALL BE INCIDENTAL TO INSTALLATION OF NEW WIRING.
- \langle 5 \rangle EXISTING GUIDANCE SIGNS AND CONCRETE PADS TO REMAIN ON CIRCUITS #12, #16 AND #17. PROVIDE NEW ISOLATION TRANSFORMER AND CONNECTIONS. SIZE ISOLATION TRANSFORMER PER EACH SIGN LOAD, PER MANUFACTURER'S RECOMMENDATION.



SCALE IN FEET

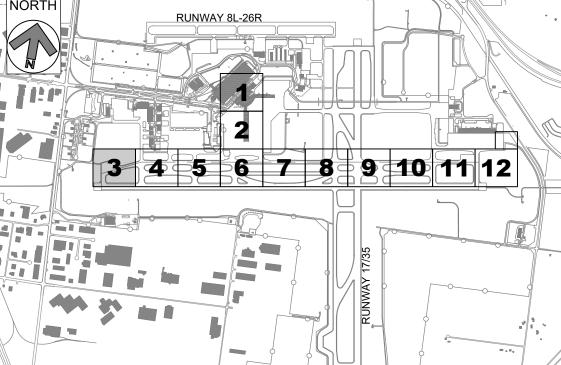

KEY PLAN

RS&H Michigan, Inc.

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www.rsandh.com



GERALD R. FORD INTERNATIONAL AIRPORT

TAXIWAY D LIGHTING REHABILITATION



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REVIEWED BY: MAR DRAWN BY: AZ DESIGNED BY: EE

> RS&H PROJECT NUMBER 1010-5865-001


> > © 2025 RS&H, INC.

SHEET TITLE

PROPOSED AIRFIELD LIGHTING PLAN-AREA 3

SHEET NUMBER

E103

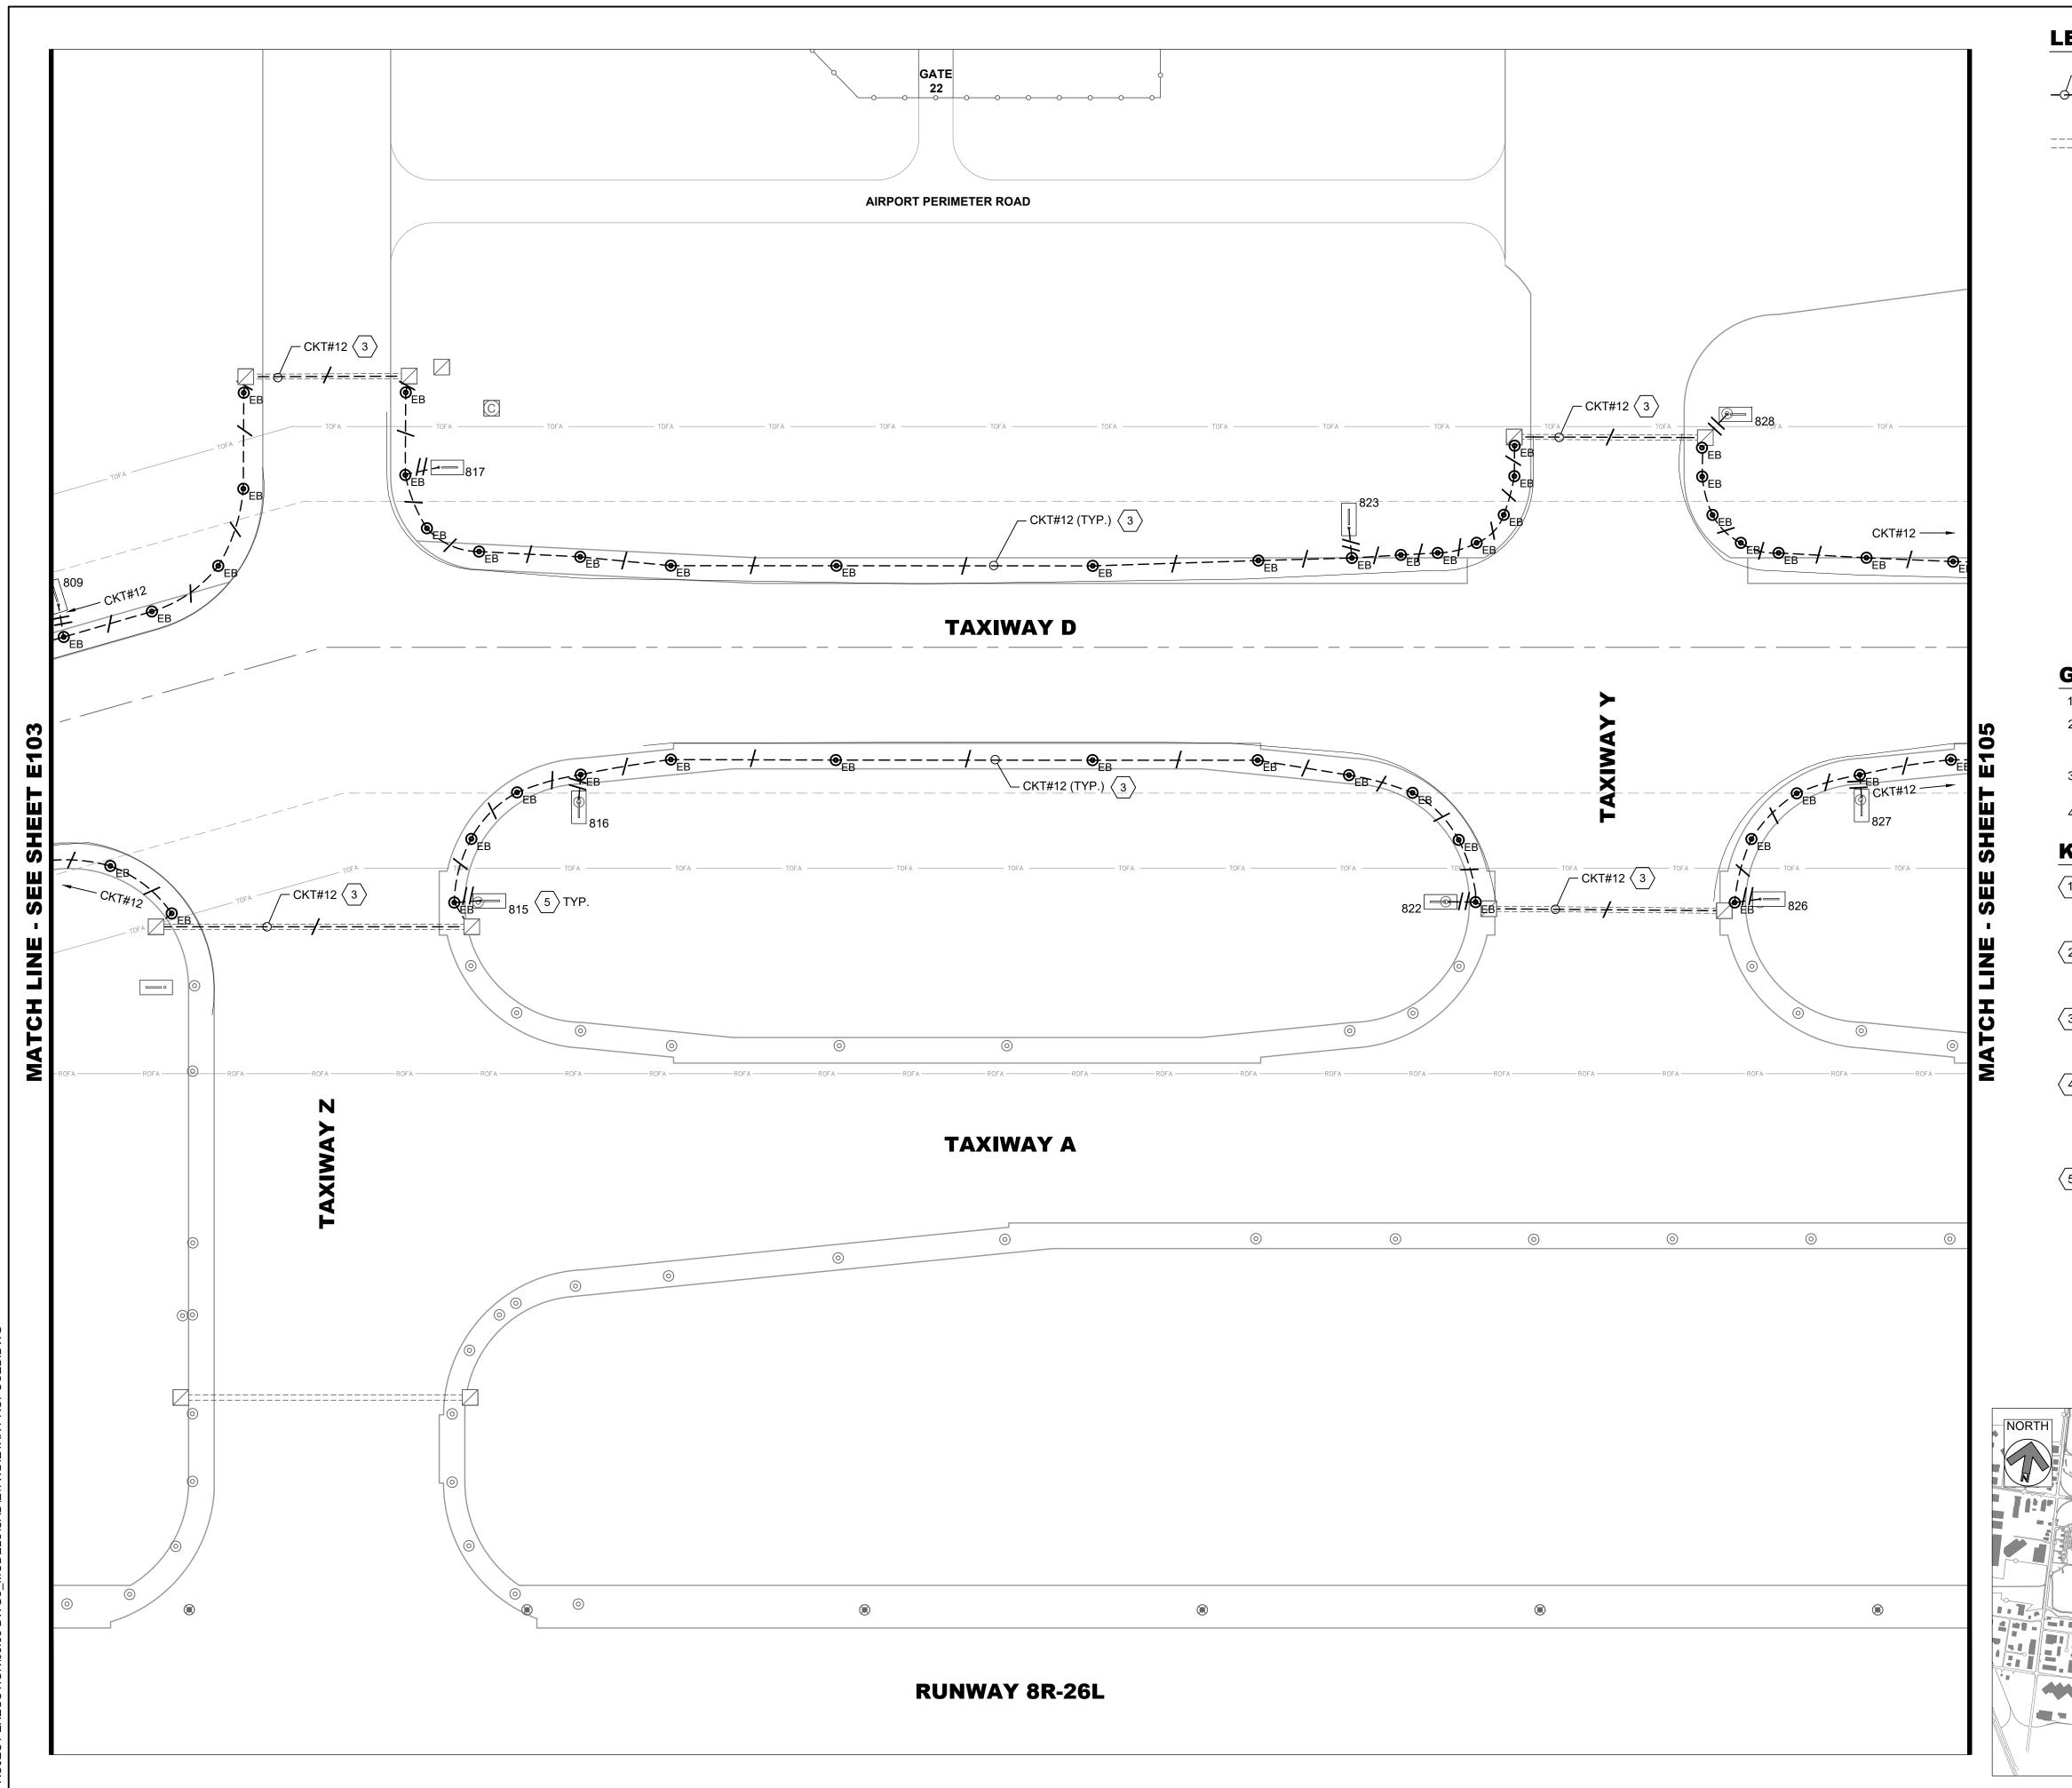

LEGEND: PROPOSED L-824 5KV CABLE IN EXISTING CONDUIT /-- CKT# HASH MARKS INDICATE NUMBER OF NEW L-824 CABLES INSTALLED IN EXISTING CONDUIT, CKT # = CIRCUIT DESIGNATOR EXISTING ELECTRICAL DUCT BANK EXISTING RUNWAY EDGE LIGHT TO REMAIN EXISTING TAXIWAY EDGE LIGHT TO REMAIN PROPOSED L-861T(L) ELEVATED OMNI-DIRECTIONAL MEDIUM INTENSITY TAXIWAY EDGE LIGHT (MITL) INSTALLED ON EXISTING BASE CAN EXISTING AIRFIELD GUIDANCE SIGN TO REMAIN EXISTING AIRFIELD GUIDANCE SIGN, PROVIDE NEW ISOLATION TRANSFORMER, SIGN TO REMAIN. XXX = SIGN NUMBER EXISTING WINDCONE TO REMAIN, PROVIDE NEW ISOLATION TRANSFORMER EXISTING SINGLE JUNCTION CAN TO REMAIN EXISTING ELECTRICAL HANDHOLE TO REMAIN

CKT #12 = TAXIWAY DELTA WEST

CKT #16 = TAXIWAY DELTA EAST

CKT #17 = TAXIWAY DELTA CENTER

GENERAL NOTES:

- 1. SEE E001 FOR GENERAL ELECTRICAL NOTES.
- 2. PROVIDE NEW ISOLATION TRANSFORMERS CONNECTED TO CIRCUITS #12, #16 AND #17, AT TAXIWAY EDGE LIGHTS, GUIDANCE SIGNS AND WINDCONES, AS APPLICABLE.


EXISTING ELECTRICAL MANHOLE TO REMAIN


EXISTING COMMUNICATIONS MANHOLE TO REMAIN

- 3. EXACT ROUTING OF CABLES THROUGH EXISTING INFRASTRUCTURE SHALL BE FIELD VERIFIED.
- 4. ALL CIRCUIT FEEDERS TO GUIDANCE SIGNS SHALL CONSIST OF 2/C L-824 5KV CABLES.

KEYED NOTES:

- (1) APPROXIMATE LOCATION OF EXISTING AIRFIELD LIGHTING ELECTRICAL VAULT. SEE SHEET E201 FOR PROPOSED SCOPE OF WORK. EXACT ROUTING OF "HOMERUN" CONDUITS AND DUCTBANKS TO VAULT SHALL BE FIELD DETERMINED.
- 2 TAXIWAY DELTA "HOMERUN" CABLES IN EXISTING DUCTBANK. PROPOSED L-824 CABLES FOR CIRCUITS #12, #16, AND #17 SHALL BE INSTALLED IN EXISTING CONDUIT. ALL OTHER CIRCUITS SHALL BE PROTECTED IN PLACE.
- (3) TAXIWAY DELTA CABLES IN EXISTING CONDUIT. PROPOSED L-824 5KV CABLES FOR CIRCUITS #12, #16, AND #17, AS MARKED, SHALL BE INSTALLED IN EXISTING CONDUITS. ALL OTHER CIRCUITS SHALL BE PROTECTED IN PLACE.
- \langle 4 \rangle ALL PROPOSED AND EXISTING WIRING TO BE PROPERLY IDENTIFIED, RACKED, AND TAGGED IN EACH MANHOLE. PROVIDE A MINIMUM OF ONE (1) LOOP OF WIRING IN EACH MANHOLE FOR EACH NEW CIRCUIT HOMERUN WIRE. CLEAN HOMERUN MANHOLES. ANY DEWATERING SHALL BE INCIDENTAL TO INSTALLATION OF NEW WIRING.
- \langle 5 \rangle EXISTING GUIDANCE SIGNS AND CONCRETE PADS TO REMAIN ON CIRCUITS #12, #16 AND #17. PROVIDE NEW ISOLATION TRANSFORMER AND CONNECTIONS. SIZE ISOLATION TRANSFORMER PER EACH SIGN LOAD, PER MANUFACTURER'S RECOMMENDATION.

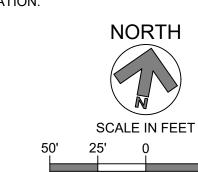

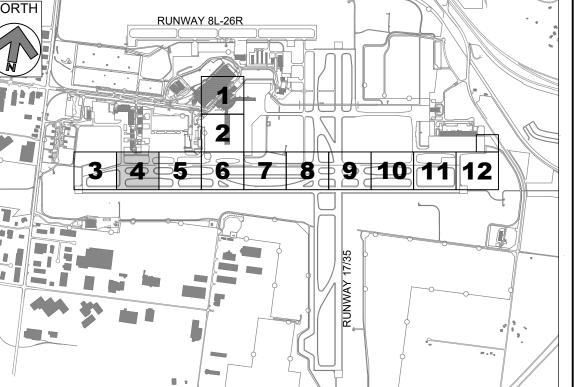

KEY PLAN

RS&H Michigan, Inc.

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TAXIWAY D LIGHTING REHABILITATION

1-800-482-7171

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DRAWN BY: AZ DESIGNED BY: EE

> RS&H PROJECT NUMBER 1010-5865-001


> > © 2025 RS&H, INC.

SHEET TITLE

PROPOSED AIRFIELD LIGHTING PLAN-AREA 4

SHEET NUMBER

E104

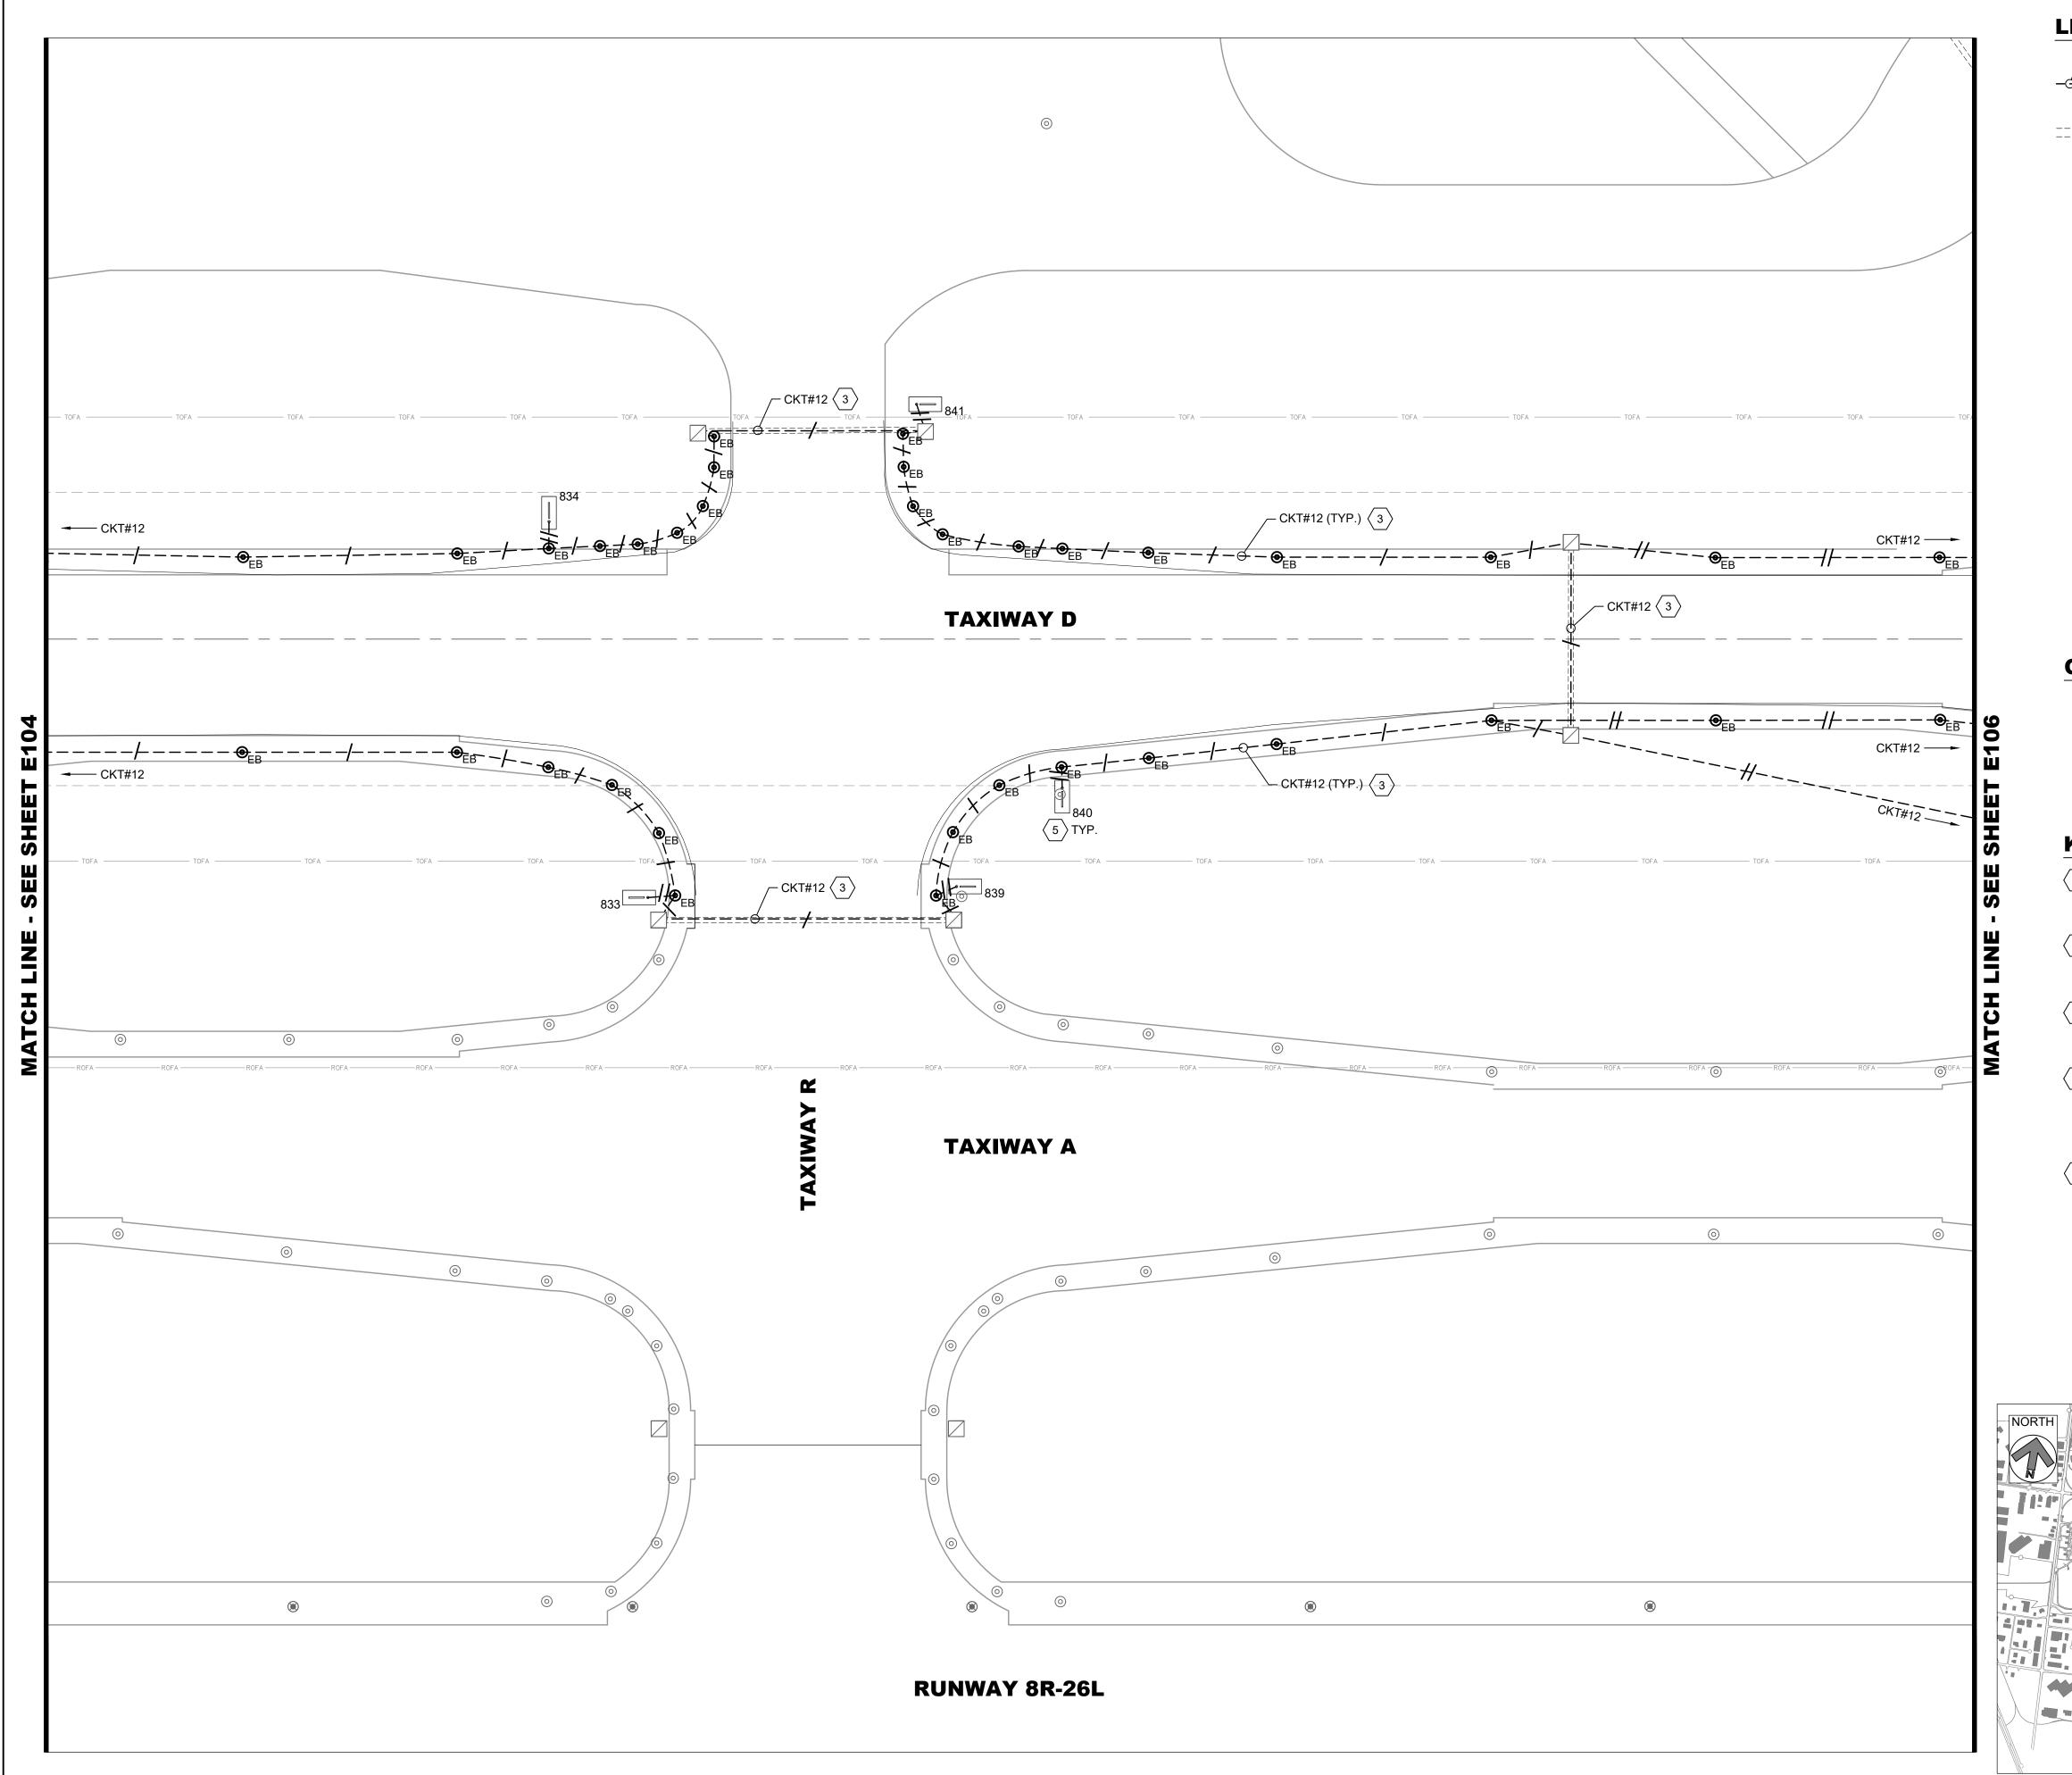

LEGEND: PROPOSED L-824 5KV CABLE IN EXISTING CONDUIT /-- CKT# HASH MARKS INDICATE NUMBER OF NEW L-824 CABLES INSTALLED IN EXISTING CONDUIT. CKT # = CIRCUIT DESIGNATOR EXISTING ELECTRICAL DUCT BANK EXISTING RUNWAY EDGE LIGHT TO REMAIN EXISTING TAXIWAY EDGE LIGHT TO REMAIN PROPOSED L-861T(L) ELEVATED OMNI-DIRECTIONAL MEDIUM INTENSITY TAXIWAY EDGE LIGHT (MITL) INSTALLED ON EXISTING BASE CAN EXISTING AIRFIELD GUIDANCE SIGN TO REMAIN EXISTING AIRFIELD GUIDANCE SIGN, PROVIDE NEW ISOLATION TRANSFORMER, SIGN TO REMAIN. XXX = SIGN NUMBER EXISTING WINDCONE TO REMAIN, PROVIDE NEW ISOLATION TRANSFORMER EXISTING SINGLE JUNCTION CAN TO REMAIN EXISTING ELECTRICAL HANDHOLE TO REMAIN EXISTING ELECTRICAL MANHOLE TO REMAIN EXISTING COMMUNICATIONS MANHOLE TO REMAIN

CKT #12 = TAXIWAY DELTA WEST

CKT #16 = TAXIWAY DELTA EAST

CKT #17 = TAXIWAY DELTA CENTER

GENERAL NOTES:


- 1. SEE E001 FOR GENERAL ELECTRICAL NOTES.
- 2. PROVIDE NEW ISOLATION TRANSFORMERS CONNECTED TO CIRCUITS #12, #16 AND #17, AT TAXIWAY EDGE LIGHTS, GUIDANCE SIGNS AND WINDCONES, AS APPLICABLE.
- 3. EXACT ROUTING OF CABLES THROUGH EXISTING INFRASTRUCTURE SHALL BE FIELD VERIFIED.
- 4. ALL CIRCUIT FEEDERS TO GUIDANCE SIGNS SHALL CONSIST OF 2/C L-824 5KV CABLES.

KEYED NOTES:

- (1) APPROXIMATE LOCATION OF EXISTING AIRFIELD LIGHTING ELECTRICAL VAULT. SEE SHEET E201 FOR PROPOSED SCOPE OF WORK. EXACT ROUTING OF "HOMERUN" CONDUITS AND DUCTBANKS TO VAULT SHALL BE FIELD DETERMINED.
- 2 TAXIWAY DELTA "HOMERUN" CABLES IN EXISTING DUCTBANK. PROPOSED L-824 CABLES FOR CIRCUITS #12, #16, AND #17 SHALL BE INSTALLED IN EXISTING CONDUIT. ALL OTHER CIRCUITS SHALL BE PROTECTED IN PLACE.
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- \langle 5 \rangle EXISTING GUIDANCE SIGNS AND CONCRETE PADS TO REMAIN ON CIRCUITS #12, #16 AND #17. PROVIDE NEW ISOLATION TRANSFORMER AND CONNECTIONS. SIZE ISOLATION TRANSFORMER PER EACH SIGN LOAD, PER MANUFACTURER'S RECOMMENDATION.

3 4 5 6 7 8 9 10 11 12

KEY PLAN

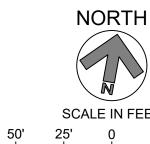

SCALE IN FEET

SHEET TITLE

PROPOSED AIRFIELD LIGHTING PLAN-

SHEET NUMBER

E105

BID

REVISIONS

NO. DESCRIPTION DATE

1-800-482-7171

RS&H Michigan, Inc.

436 S. MAIN STREET PLYMOUTH, MICHIGAN 48170 PH: 734-456-7060

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DATE ISSUED: MAY 2025 REVIEWED BY: MAR DRAWN BY: AZ


DESIGNED BY: EE

RS&H PROJECT NUMBER 1010-5865-001

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AREA 5

ISSUED FOR

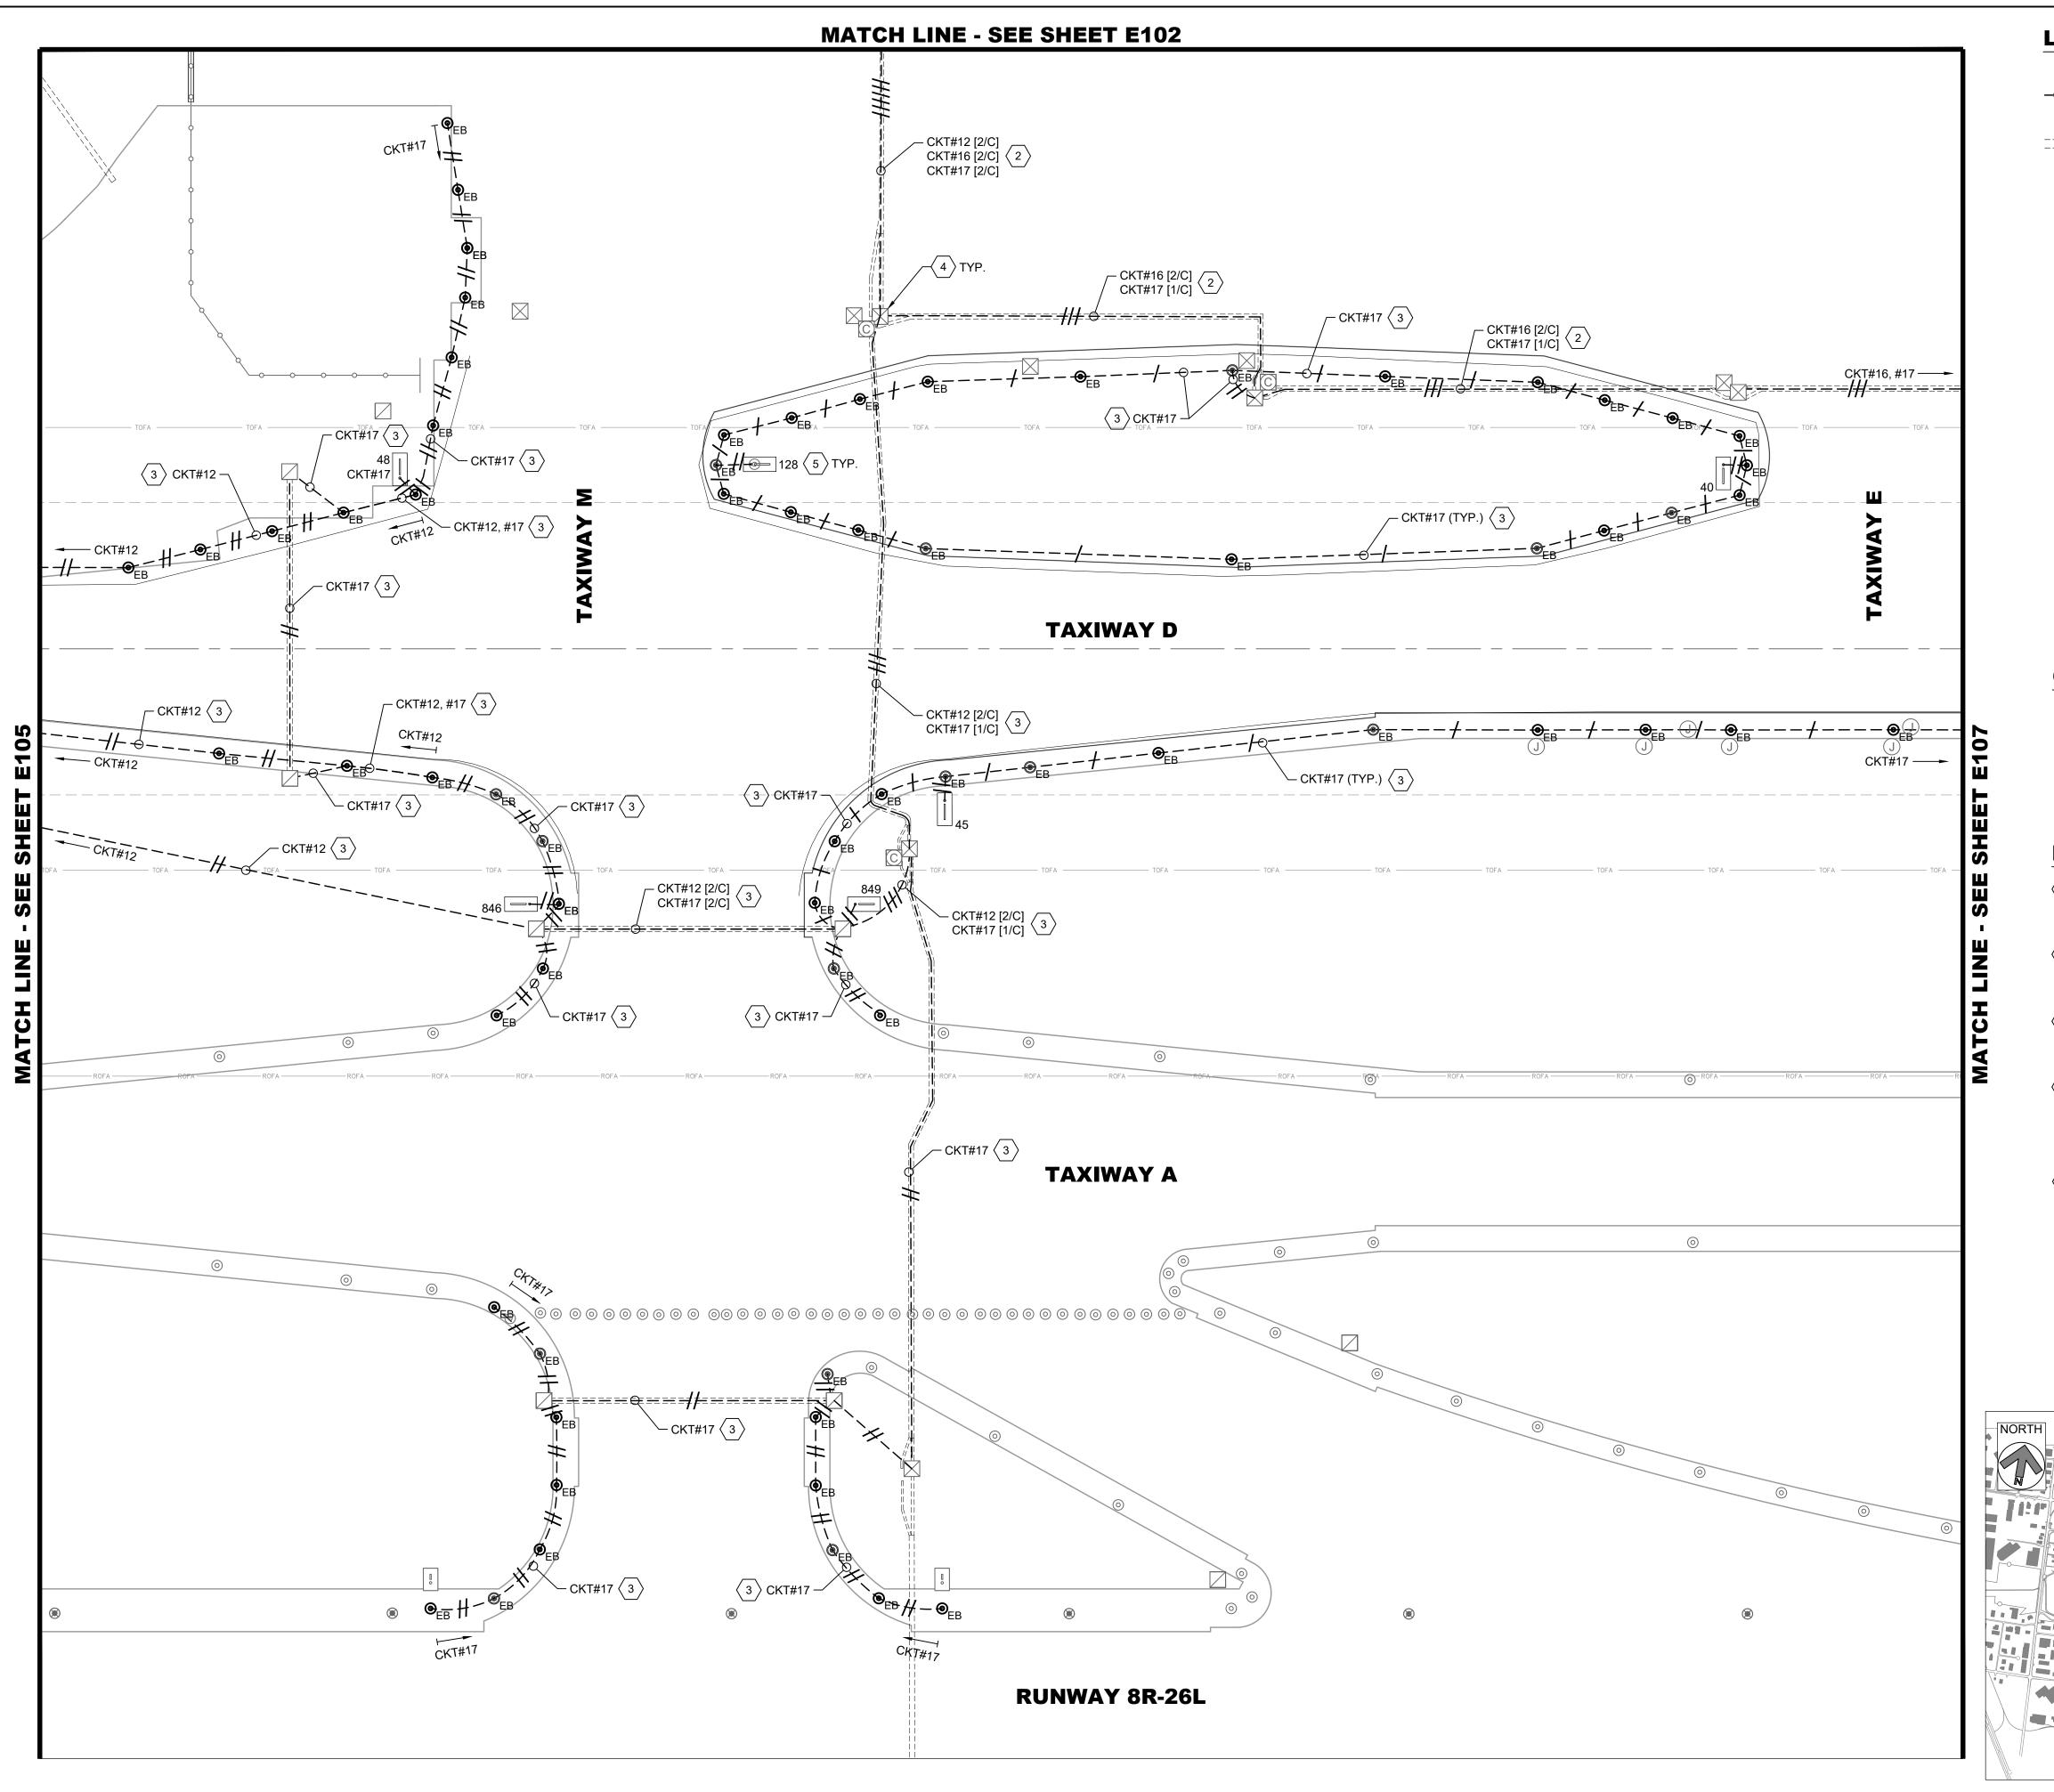

LEGEND: PROPOSED L-824 5KV CABLE IN EXISTING CONDUIT /-- CKT# HASH MARKS INDICATE NUMBER OF NEW L-824 CABLES INSTALLED IN EXISTING CONDUIT, CKT # = CIRCUIT DESIGNATOR EXISTING ELECTRICAL DUCT BANK EXISTING RUNWAY EDGE LIGHT TO REMAIN EXISTING TAXIWAY EDGE LIGHT TO REMAIN PROPOSED L-861T(L) ELEVATED OMNI-DIRECTIONAL MEDIUM INTENSITY TAXIWAY EDGE LIGHT (MITL) INSTALLED ON EXISTING BASE CAN EXISTING AIRFIELD GUIDANCE SIGN TO REMAIN EXISTING AIRFIELD GUIDANCE SIGN, PROVIDE NEW ISOLATION TRANSFORMER, SIGN TO REMAIN. XXX = SIGN NUMBER EXISTING WINDCONE TO REMAIN, PROVIDE **NEW ISOLATION TRANSFORMER EXISTING SINGLE JUNCTION CAN TO REMAIN** EXISTING ELECTRICAL HANDHOLE TO REMAIN EXISTING ELECTRICAL MANHOLE TO REMAIN

EXISTING COMMUNICATIONS MANHOLE TO REMAIN

CKT #12 = TAXIWAY DELTA WEST

CKT #16 = TAXIWAY DELTA EAST


CKT #17 = TAXIWAY DELTA CENTER


GENERAL NOTES:

- 1. SEE E001 FOR GENERAL ELECTRICAL NOTES.
- 2. PROVIDE NEW ISOLATION TRANSFORMERS CONNECTED TO CIRCUITS #12, #16 AND #17, AT TAXIWAY EDGE LIGHTS, GUIDANCE SIGNS AND WINDCONES, AS APPLICABLE.
- 3. EXACT ROUTING OF CABLES THROUGH EXISTING INFRASTRUCTURE SHALL BE FIELD VERIFIED.
- 4. ALL CIRCUIT FEEDERS TO GUIDANCE SIGNS SHALL CONSIST OF 2/C L-824 5KV CABLES.

KEYED NOTES:

- (1) APPROXIMATE LOCATION OF EXISTING AIRFIELD LIGHTING ELECTRICAL VAULT. SEE SHEET E201 FOR PROPOSED SCOPE OF WORK. EXACT ROUTING OF "HOMERUN" CONDUITS AND DUCTBANKS TO VAULT SHALL BE FIELD DETERMINED.
- \langle 2 \rangle TAXIWAY DELTA "HOMERUN" CABLES IN EXISTING DUCTBANK. PROPOSED L-824 CABLES FOR CIRCUITS #12, #16, AND #17 SHALL BE INSTALLED IN EXISTING CONDUIT. ALL OTHER CIRCUITS SHALL BE PROTECTED IN PLACE.
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KEY PLAN
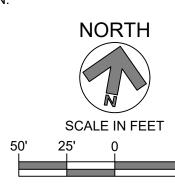
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DRAWN BY: AZ DESIGNED BY: EE
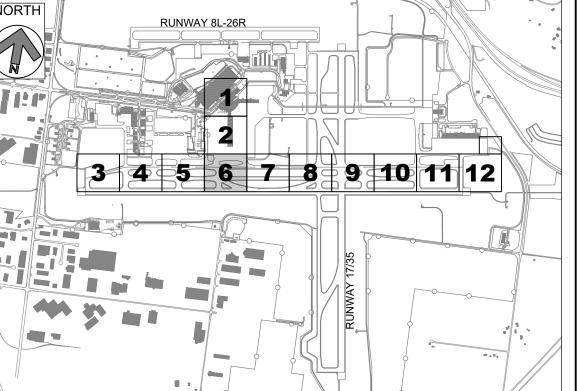
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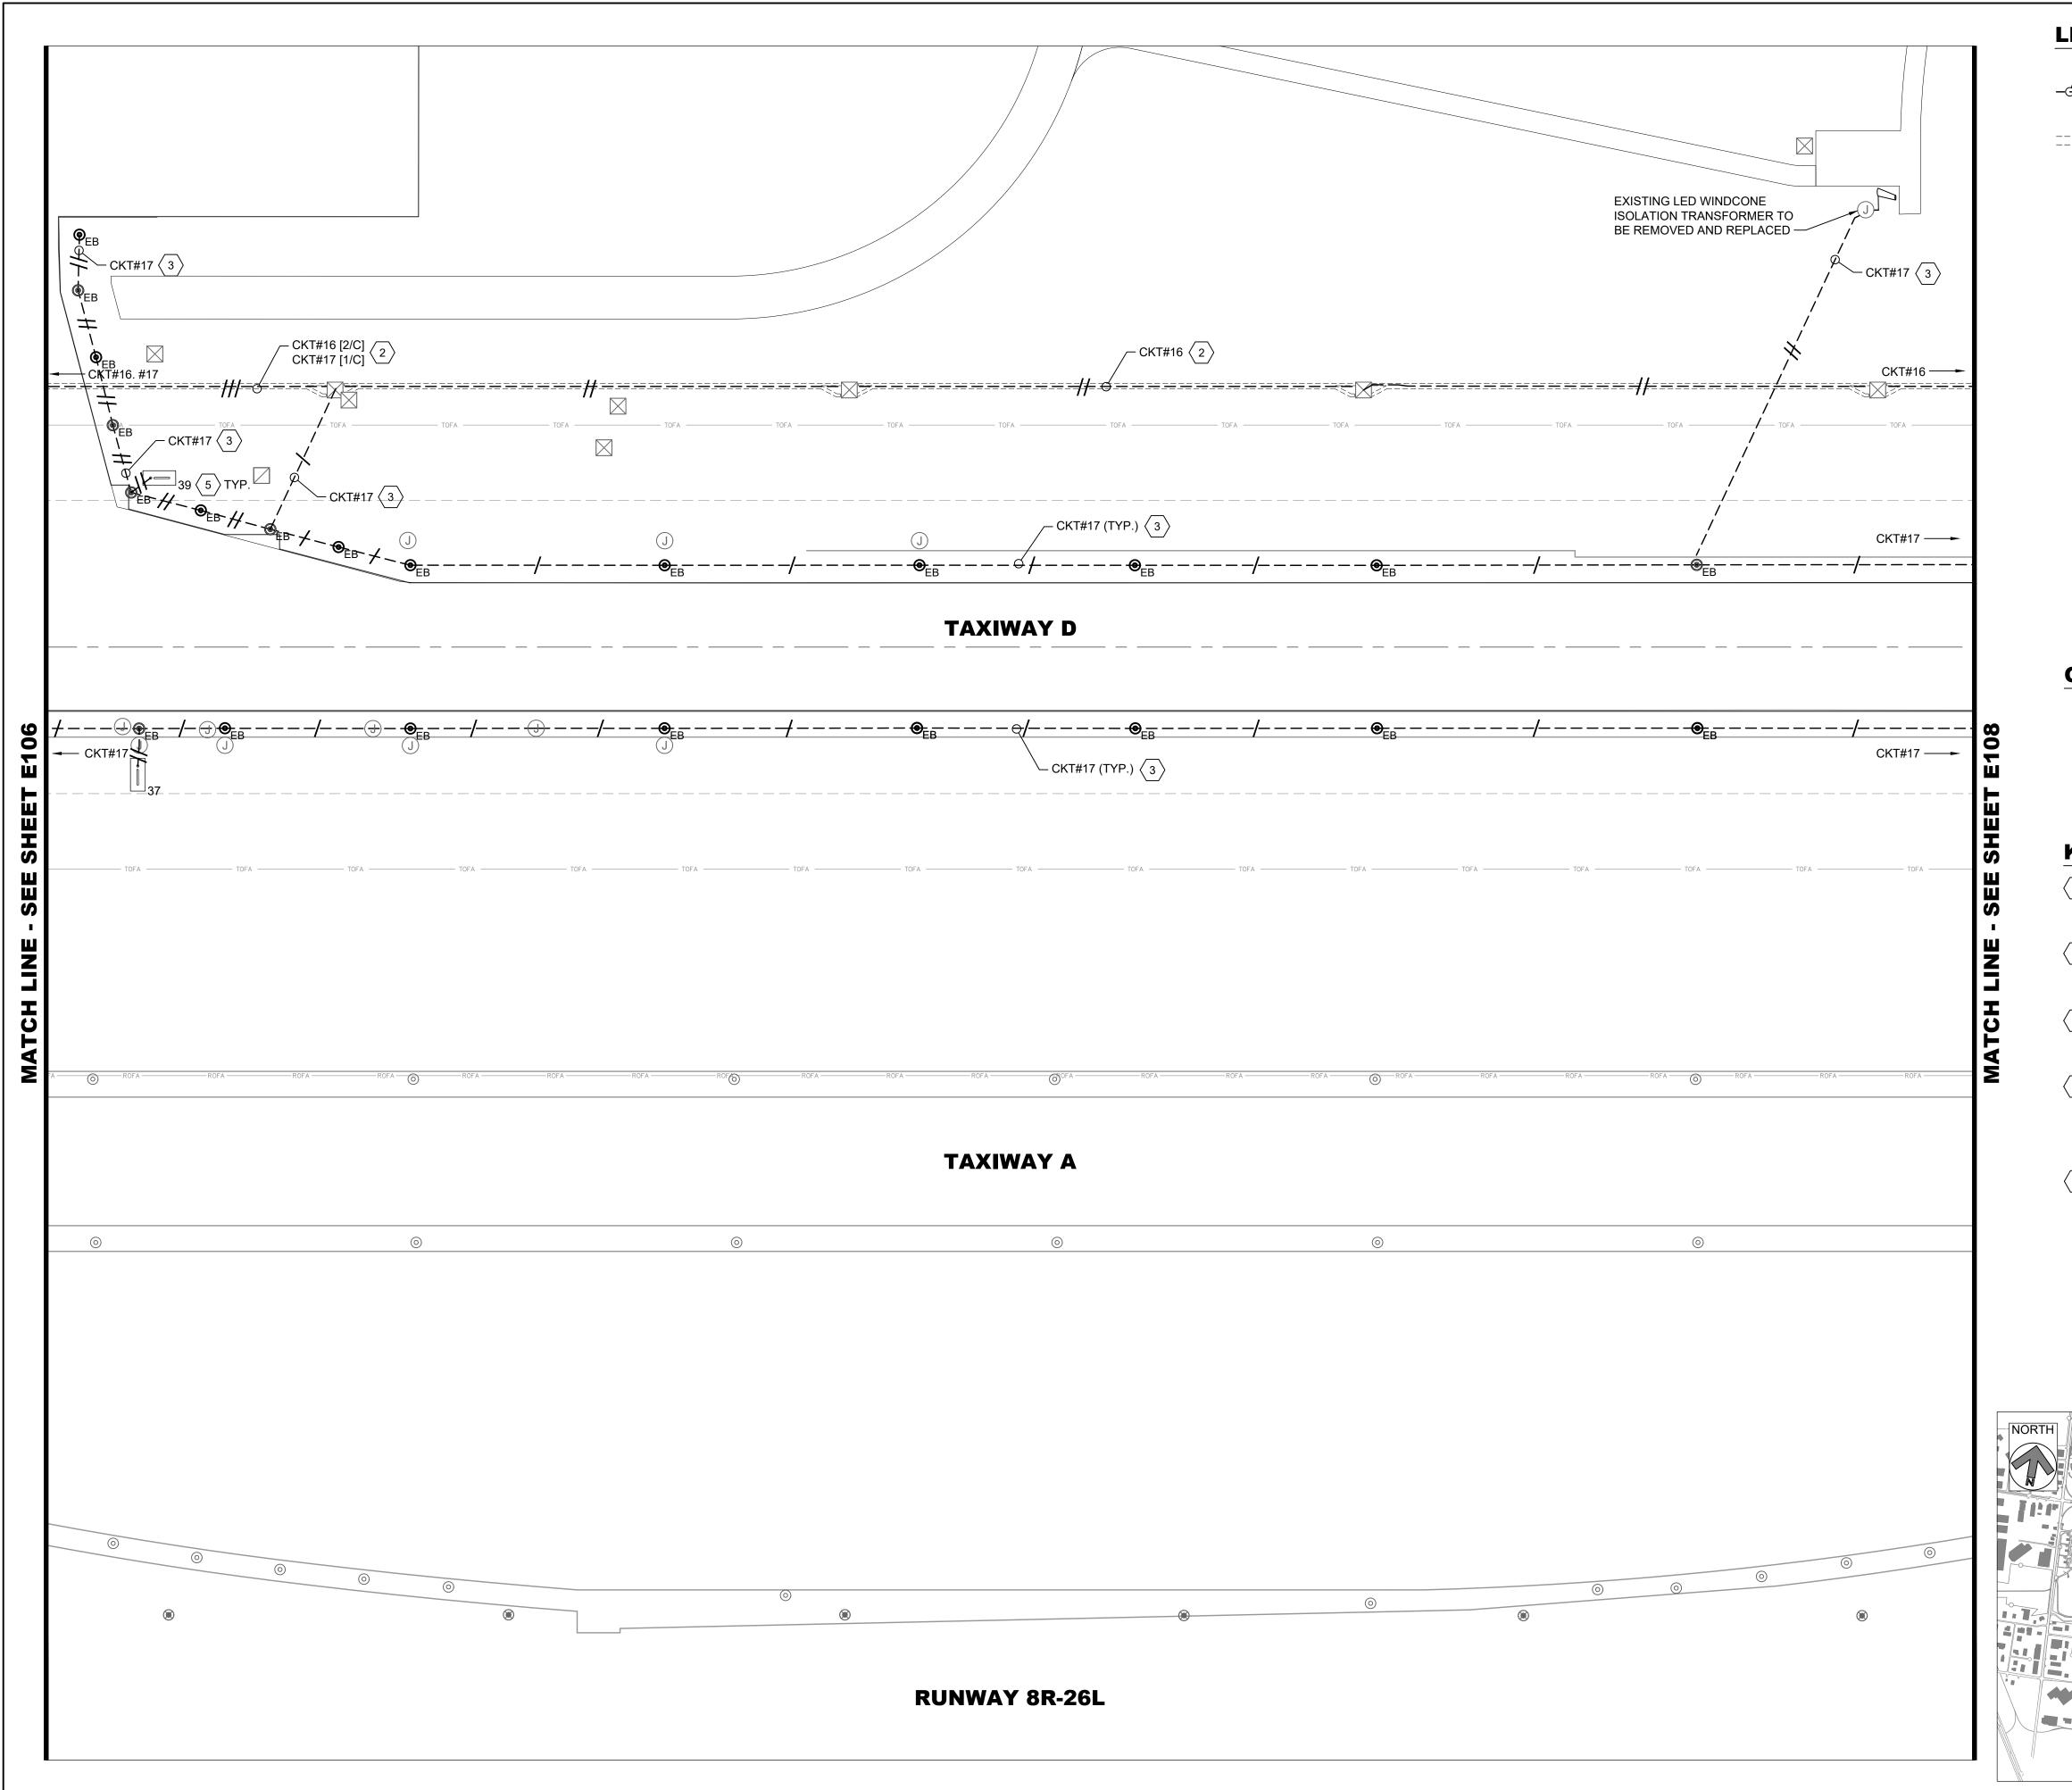
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SHEET TITLE

PROPOSED AIRFIELD LIGHTING PLAN-AREA 6

SHEET NUMBER

E106



LEGEND: PROPOSED L-824 5KV CABLE IN EXISTING CONDUIT /-- CKT# HASH MARKS INDICATE NUMBER OF NEW L-824 CABLES INSTALLED IN EXISTING CONDUIT, CKT # = CIRCUIT DESIGNATOR EXISTING ELECTRICAL DUCT BANK EXISTING RUNWAY EDGE LIGHT TO REMAIN EXISTING TAXIWAY EDGE LIGHT TO REMAIN PROPOSED L-861T(L) ELEVATED OMNI-DIRECTIONAL MEDIUM INTENSITY TAXIWAY EDGE LIGHT (MITL) INSTALLED ON EXISTING BASE CAN EXISTING AIRFIELD GUIDANCE SIGN TO REMAIN EXISTING AIRFIELD GUIDANCE SIGN, PROVIDE NEW ISOLATION TRANSFORMER, SIGN TO REMAIN. XXX = SIGN NUMBER EXISTING WINDCONE TO REMAIN, PROVIDE NEW ISOLATION TRANSFORMER EXISTING SINGLE JUNCTION CAN TO REMAIN EXISTING ELECTRICAL HANDHOLE TO REMAIN

EXISTING ELECTRICAL MANHOLE TO REMAIN

EXISTING COMMUNICATIONS MANHOLE TO REMAIN

CKT #12 = TAXIWAY DELTA WEST

CKT #16 = TAXIWAY DELTA EAST

CKT #17 = TAXIWAY DELTA CENTER

GENERAL NOTES:


- 1. SEE E001 FOR GENERAL ELECTRICAL NOTES.
- 2. PROVIDE NEW ISOLATION TRANSFORMERS CONNECTED TO CIRCUITS #12, #16 AND #17, AT TAXIWAY EDGE LIGHTS, GUIDANCE SIGNS AND WINDCONES, AS APPLICABLE.
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KEYED NOTES:

- (1) APPROXIMATE LOCATION OF EXISTING AIRFIELD LIGHTING ELECTRICAL VAULT. SEE SHEET E201 FOR PROPOSED SCOPE OF WORK. EXACT ROUTING OF "HOMERUN" CONDUITS AND DUCTBANKS TO VAULT SHALL BE FIELD DETERMINED.
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- \langle 5 \rangle EXISTING GUIDANCE SIGNS AND CONCRETE PADS TO REMAIN ON CIRCUITS #12, #16 AND #17. PROVIDE NEW ISOLATION TRANSFORMER AND CONNECTIONS. SIZE ISOLATION TRANSFORMER PER EACH SIGN LOAD, PER MANUFACTURER'S RECOMMENDATION.

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KEY PLAN



SCALE IN FEET

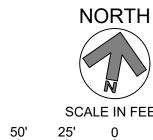RS&H PROJECT NUMBER 1010-5865-001

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SHEET TITLE

PROPOSED AIRFIELD LIGHTING PLAN-AREA 7

SHEET NUMBER

BID

1-800-482-7171 **REVISIONS** NO. DESCRIPTION DATE

RS&H Michigan, Inc.

436 S. MAIN STREET PLYMOUTH, MICHIGAN 48170 PH: 734-456-7060

FAX: 1-800-464-4358

www.rsandh.com

GERALD R. FORD

INTERNATIONAL AIRPORT

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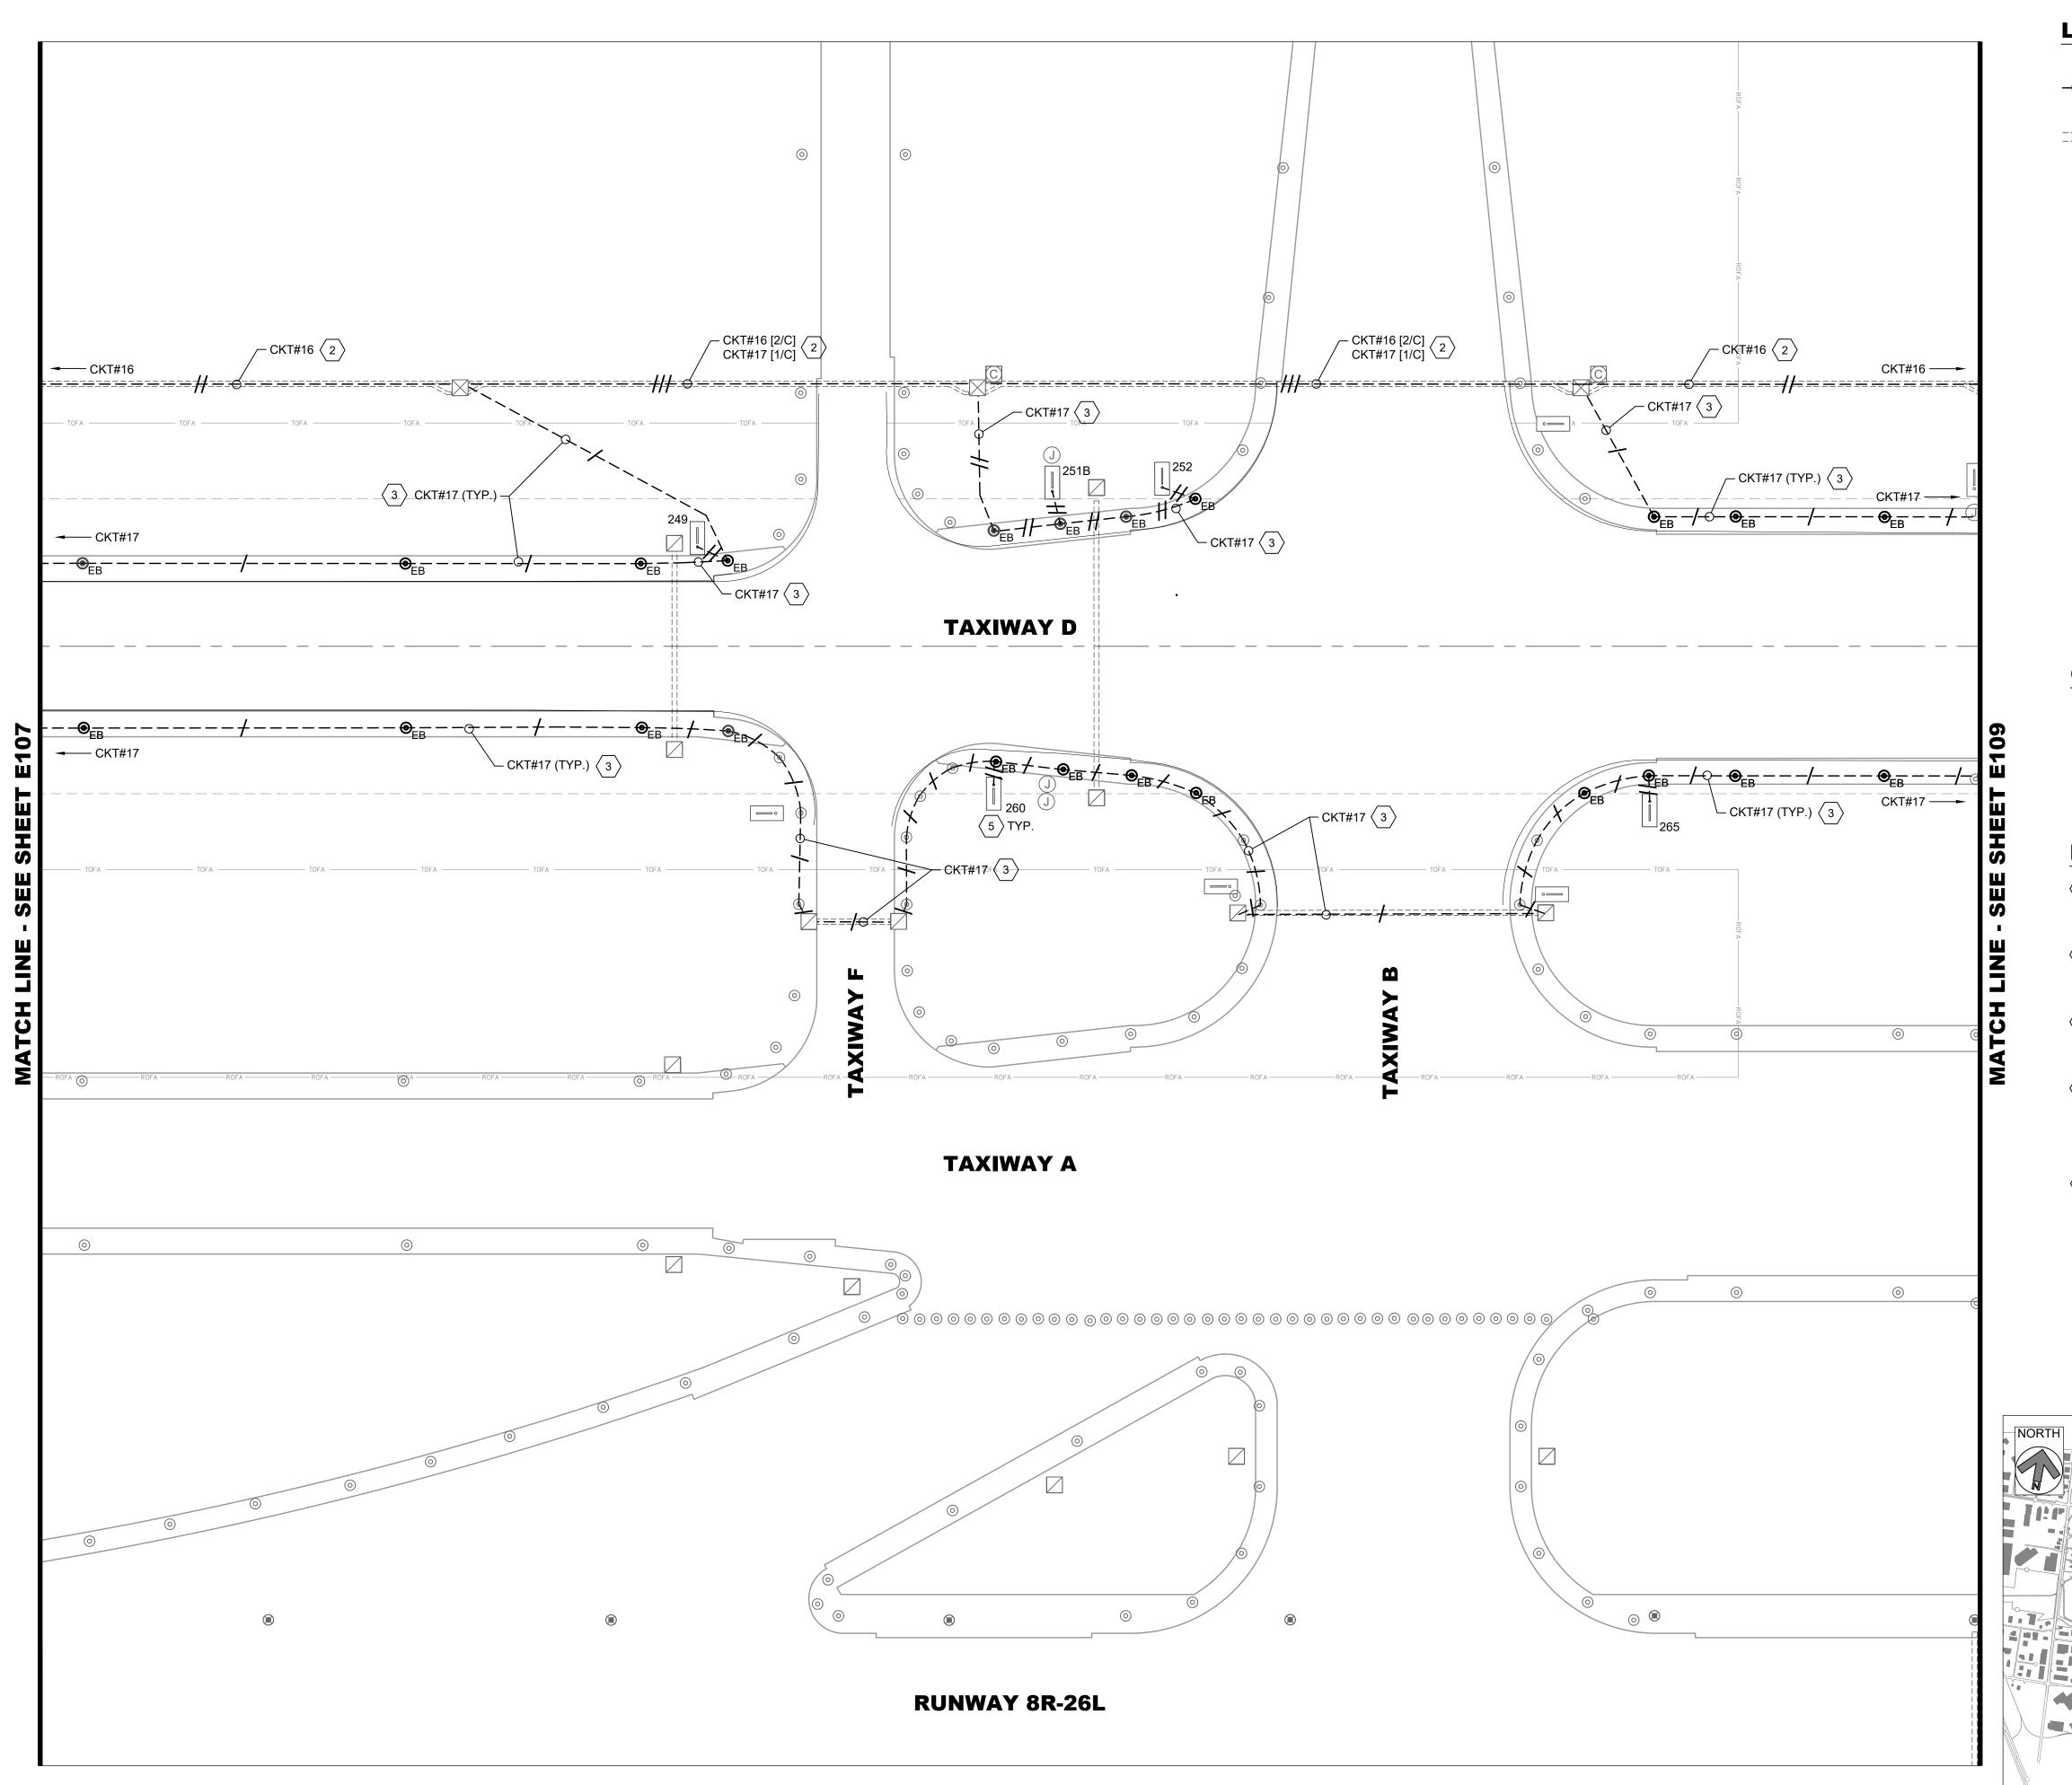
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DATE ISSUED: MAY 2025 REVIEWED BY: MAR DRAWN BY: AZ

DESIGNED BY: EE

E107

ISSUED FOR



PROPOSED L-824 5KV CABLE IN EXISTING CONDUIT /-- CKT# HASH MARKS INDICATE NUMBER OF NEW L-824 CABLES INSTALLED IN EXISTING CONDUIT, CKT # = CIRCUIT DESIGNATOR EXISTING ELECTRICAL DUCT BANK EXISTING RUNWAY EDGE LIGHT TO REMAIN EXISTING TAXIWAY EDGE LIGHT TO REMAIN PROPOSED L-861T(L) ELEVATED OMNI-DIRECTIONAL MEDIUM INTENSITY TAXIWAY EDGE LIGHT (MITL)

EXISTING AIRFIELD GUIDANCE SIGN TO REMAIN EXISTING AIRFIELD GUIDANCE SIGN, PROVIDE NEW ISOLATION TRANSFORMER, SIGN TO REMAIN. XXX = SIGN NUMBER

EXISTING WINDCONE TO REMAIN, PROVIDE NEW ISOLATION TRANSFORMER

INSTALLED ON EXISTING BASE CAN

EXISTING ELECTRICAL HANDHOLE TO REMAIN

EXISTING SINGLE JUNCTION CAN TO REMAIN

EXISTING ELECTRICAL MANHOLE TO REMAIN

EXISTING COMMUNICATIONS MANHOLE TO REMAIN CKT #12 = TAXIWAY DELTA WEST

CKT #16 = TAXIWAY DELTA EAST


CKT #17 = TAXIWAY DELTA CENTER

GENERAL NOTES:

- 1. SEE E001 FOR GENERAL ELECTRICAL NOTES.
- 2. PROVIDE NEW ISOLATION TRANSFORMERS CONNECTED TO CIRCUITS #12, #16 AND #17, AT TAXIWAY EDGE LIGHTS, GUIDANCE SIGNS AND WINDCONES, AS APPLICABLE.
- 3. EXACT ROUTING OF CABLES THROUGH EXISTING INFRASTRUCTURE SHALL BE FIELD VERIFIED.
- 4. ALL CIRCUIT FEEDERS TO GUIDANCE SIGNS SHALL CONSIST OF 2/C L-824 5KV CABLES.

KEYED NOTES:

- (1) APPROXIMATE LOCATION OF EXISTING AIRFIELD LIGHTING ELECTRICAL VAULT. SEE SHEET E201 FOR PROPOSED SCOPE OF WORK. EXACT ROUTING OF "HOMERUN" CONDUITS AND DUCTBANKS TO VAULT SHALL BE FIELD DETERMINED.
- 2 TAXIWAY DELTA "HOMERUN" CABLES IN EXISTING DUCTBANK. PROPOSED L-824 CABLES FOR CIRCUITS #12, #16, AND #17 SHALL BE INSTALLED IN EXISTING CONDUIT. ALL OTHER CIRCUITS SHALL BE PROTECTED IN PLACE.
- (3) TAXIWAY DELTA CABLES IN EXISTING CONDUIT. PROPOSED L-824 5KV CABLES FOR CIRCUITS #12, #16, AND #17, AS MARKED, SHALL BE INSTALLED IN EXISTING CONDUITS. ALL OTHER CIRCUITS SHALL BE PROTECTED IN PLACE.
- 4 ALL PROPOSED AND EXISTING WIRING TO BE PROPERLY IDENTIFIED, RACKED, AND TAGGED IN EACH MANHOLE. PROVIDE A MINIMUM OF ONE (1) LOOP OF WIRING IN EACH MANHOLE FOR EACH NEW CIRCUIT HOMERUN WIRE. CLEAN HOMERUN MANHOLES. ANY DEWATERING SHALL BE INCIDENTAL TO INSTALLATION OF NEW WIRING.
- \langle 5 \rangle EXISTING GUIDANCE SIGNS AND CONCRETE PADS TO REMAIN ON CIRCUITS #12, #16 AND #17. PROVIDE NEW ISOLATION TRANSFORMER AND CONNECTIONS. SIZE ISOLATION TRANSFORMER PER EACH SIGN LOAD, PER

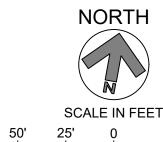

PROPOSED AIRFIELD LIGHTING PLAN-

SHEET NUMBER

BID

1-800-482-7171 **REVISIONS** NO. DESCRIPTION DATE

RS&H Michigan, Inc.

436 S. MAIN STREET **PLYMOUTH, MICHIGAN 48170** PH: 734-456-7060

FAX: 1-800-464-4358 www.rsandh.com

GERALD R. FORD

INTERNATIONAL

AIRPORT

TAXIWAY D

LIGHTING

REHABILITATION

DATE ISSUED: MAY 2025 REVIEWED BY: MAR DRAWN BY: AZ

DESIGNED BY: EE

RS&H PROJECT NUMBER 1010-5865-001


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SHEET TITLE

AREA 8

E108

ISSUED FOR

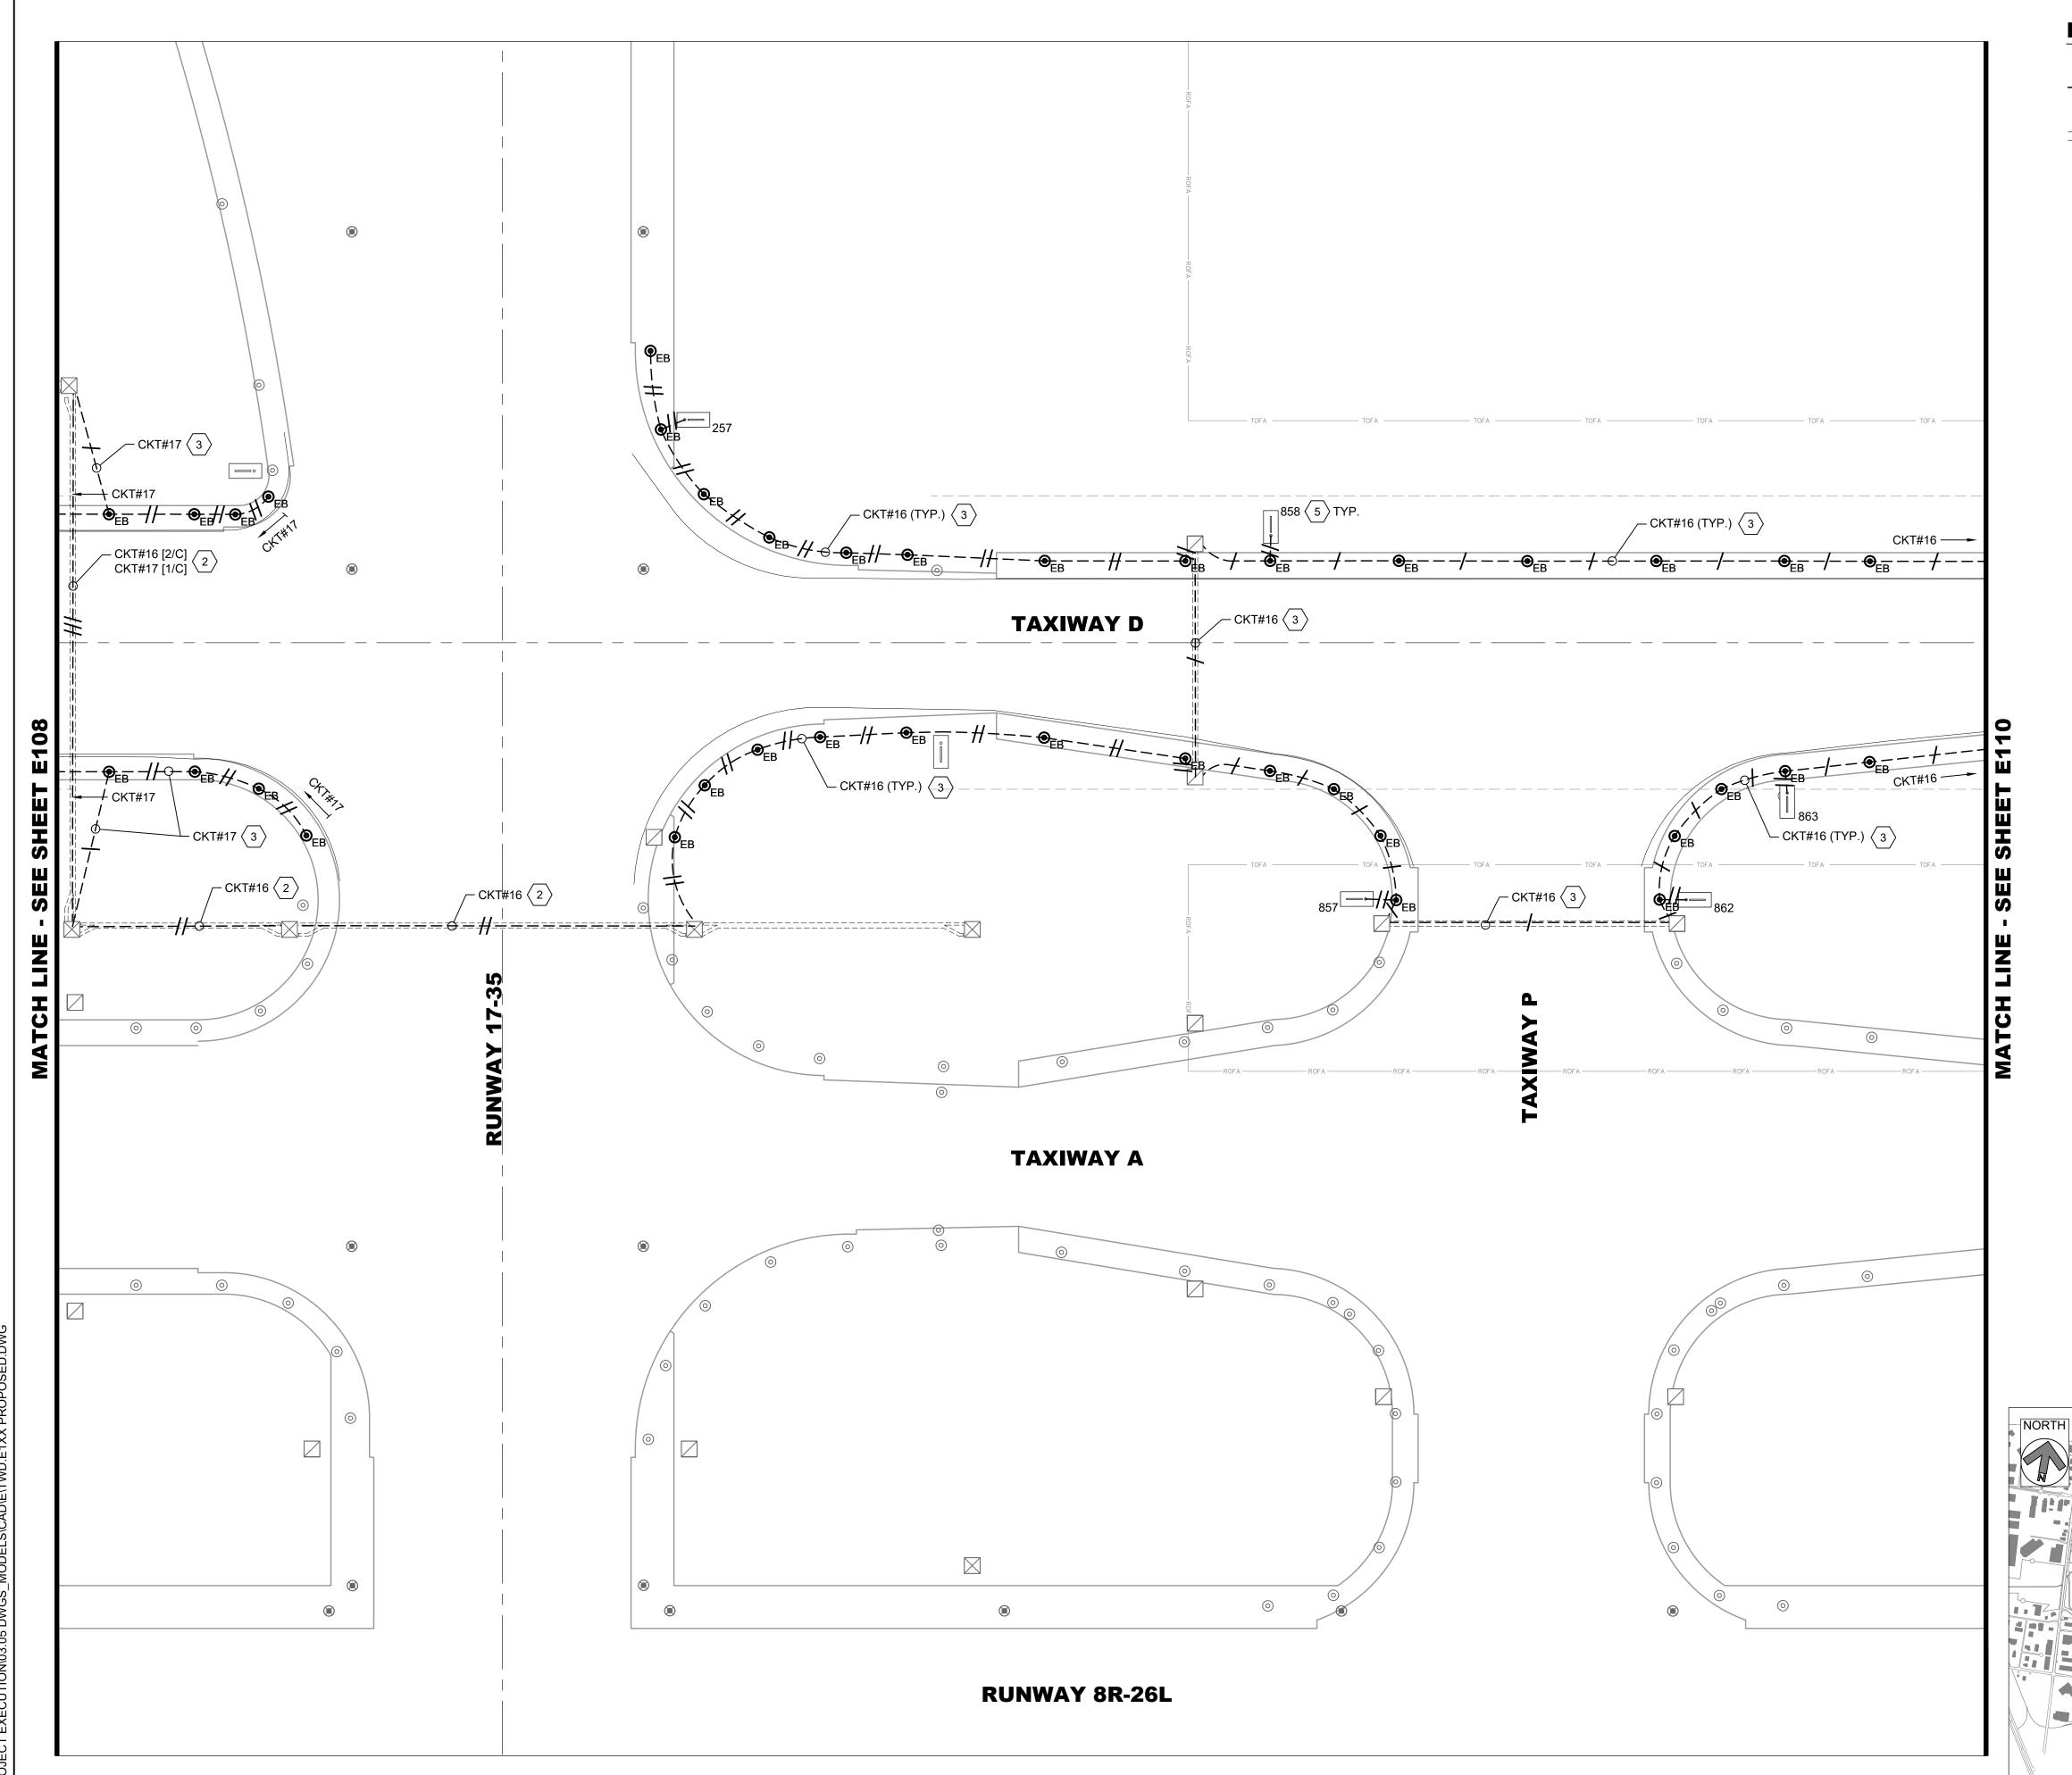

LEGEND: PROPOSED L-824 5KV CABLE IN EXISTING CONDUIT /-- CKT# HASH MARKS INDICATE NUMBER OF NEW L-824 CABLES INSTALLED IN EXISTING CONDUIT, CKT # = CIRCUIT DESIGNATOR EXISTING ELECTRICAL DUCT BANK EXISTING RUNWAY EDGE LIGHT TO REMAIN EXISTING TAXIWAY EDGE LIGHT TO REMAIN PROPOSED L-861T(L) ELEVATED OMNI-DIRECTIONAL MEDIUM INTENSITY TAXIWAY EDGE LIGHT (MITL) INSTALLED ON EXISTING BASE CAN EXISTING AIRFIELD GUIDANCE SIGN TO REMAIN EXISTING AIRFIELD GUIDANCE SIGN, PROVIDE NEW ISOLATION TRANSFORMER, SIGN TO REMAIN. XXX = SIGN NUMBER EXISTING WINDCONE TO REMAIN, PROVIDE NEW ISOLATION TRANSFORMER EXISTING SINGLE JUNCTION CAN TO REMAIN EXISTING ELECTRICAL HANDHOLE TO REMAIN EXISTING ELECTRICAL MANHOLE TO REMAIN

CKT #12 = TAXIWAY DELTA WEST

CKT #16 = TAXIWAY DELTA EAST

CKT #17 = TAXIWAY DELTA CENTER

GENERAL NOTES:


- 1. SEE E001 FOR GENERAL ELECTRICAL NOTES.
- 2. PROVIDE NEW ISOLATION TRANSFORMERS CONNECTED TO CIRCUITS #12, #16 AND #17, AT TAXIWAY EDGE LIGHTS, GUIDANCE SIGNS AND WINDCONES, AS APPLICABLE.

EXISTING COMMUNICATIONS MANHOLE TO REMAIN

- 3. EXACT ROUTING OF CABLES THROUGH EXISTING INFRASTRUCTURE SHALL BE FIELD VERIFIED.
- 4. ALL CIRCUIT FEEDERS TO GUIDANCE SIGNS SHALL CONSIST OF 2/C L-824 5KV CABLES.

KEYED NOTES:

- (1) APPROXIMATE LOCATION OF EXISTING AIRFIELD LIGHTING ELECTRICAL VAULT. SEE SHEET E201 FOR PROPOSED SCOPE OF WORK. EXACT ROUTING OF "HOMERUN" CONDUITS AND DUCTBANKS TO VAULT SHALL BE FIELD DETERMINED.
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- \langle 5 \rangle EXISTING GUIDANCE SIGNS AND CONCRETE PADS TO REMAIN ON CIRCUITS #12, #16 AND #17. PROVIDE NEW ISOLATION TRANSFORMER AND CONNECTIONS. SIZE ISOLATION TRANSFORMER PER EACH SIGN LOAD, PER MANUFACTURER'S RECOMMENDATION.

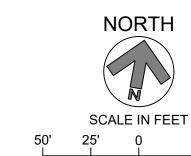

3 4 5 6 7 8 9 10 11 12

KEY PLAN

DESIGNED BY: EE RS&H PROJECT NUMBER

DRAWN BY: AZ

DATE ISSUED: MAY 2025 REVIEWED BY: MAR

1010-5865-001

RS&H Michigan, Inc.

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1-800-482-7171

NO. DESCRIPTION DATE

REVISIONS


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SHEET TITLE **PROPOSED**

AIRFIELD LIGHTING PLAN-AREA 9

SHEET NUMBER

E109

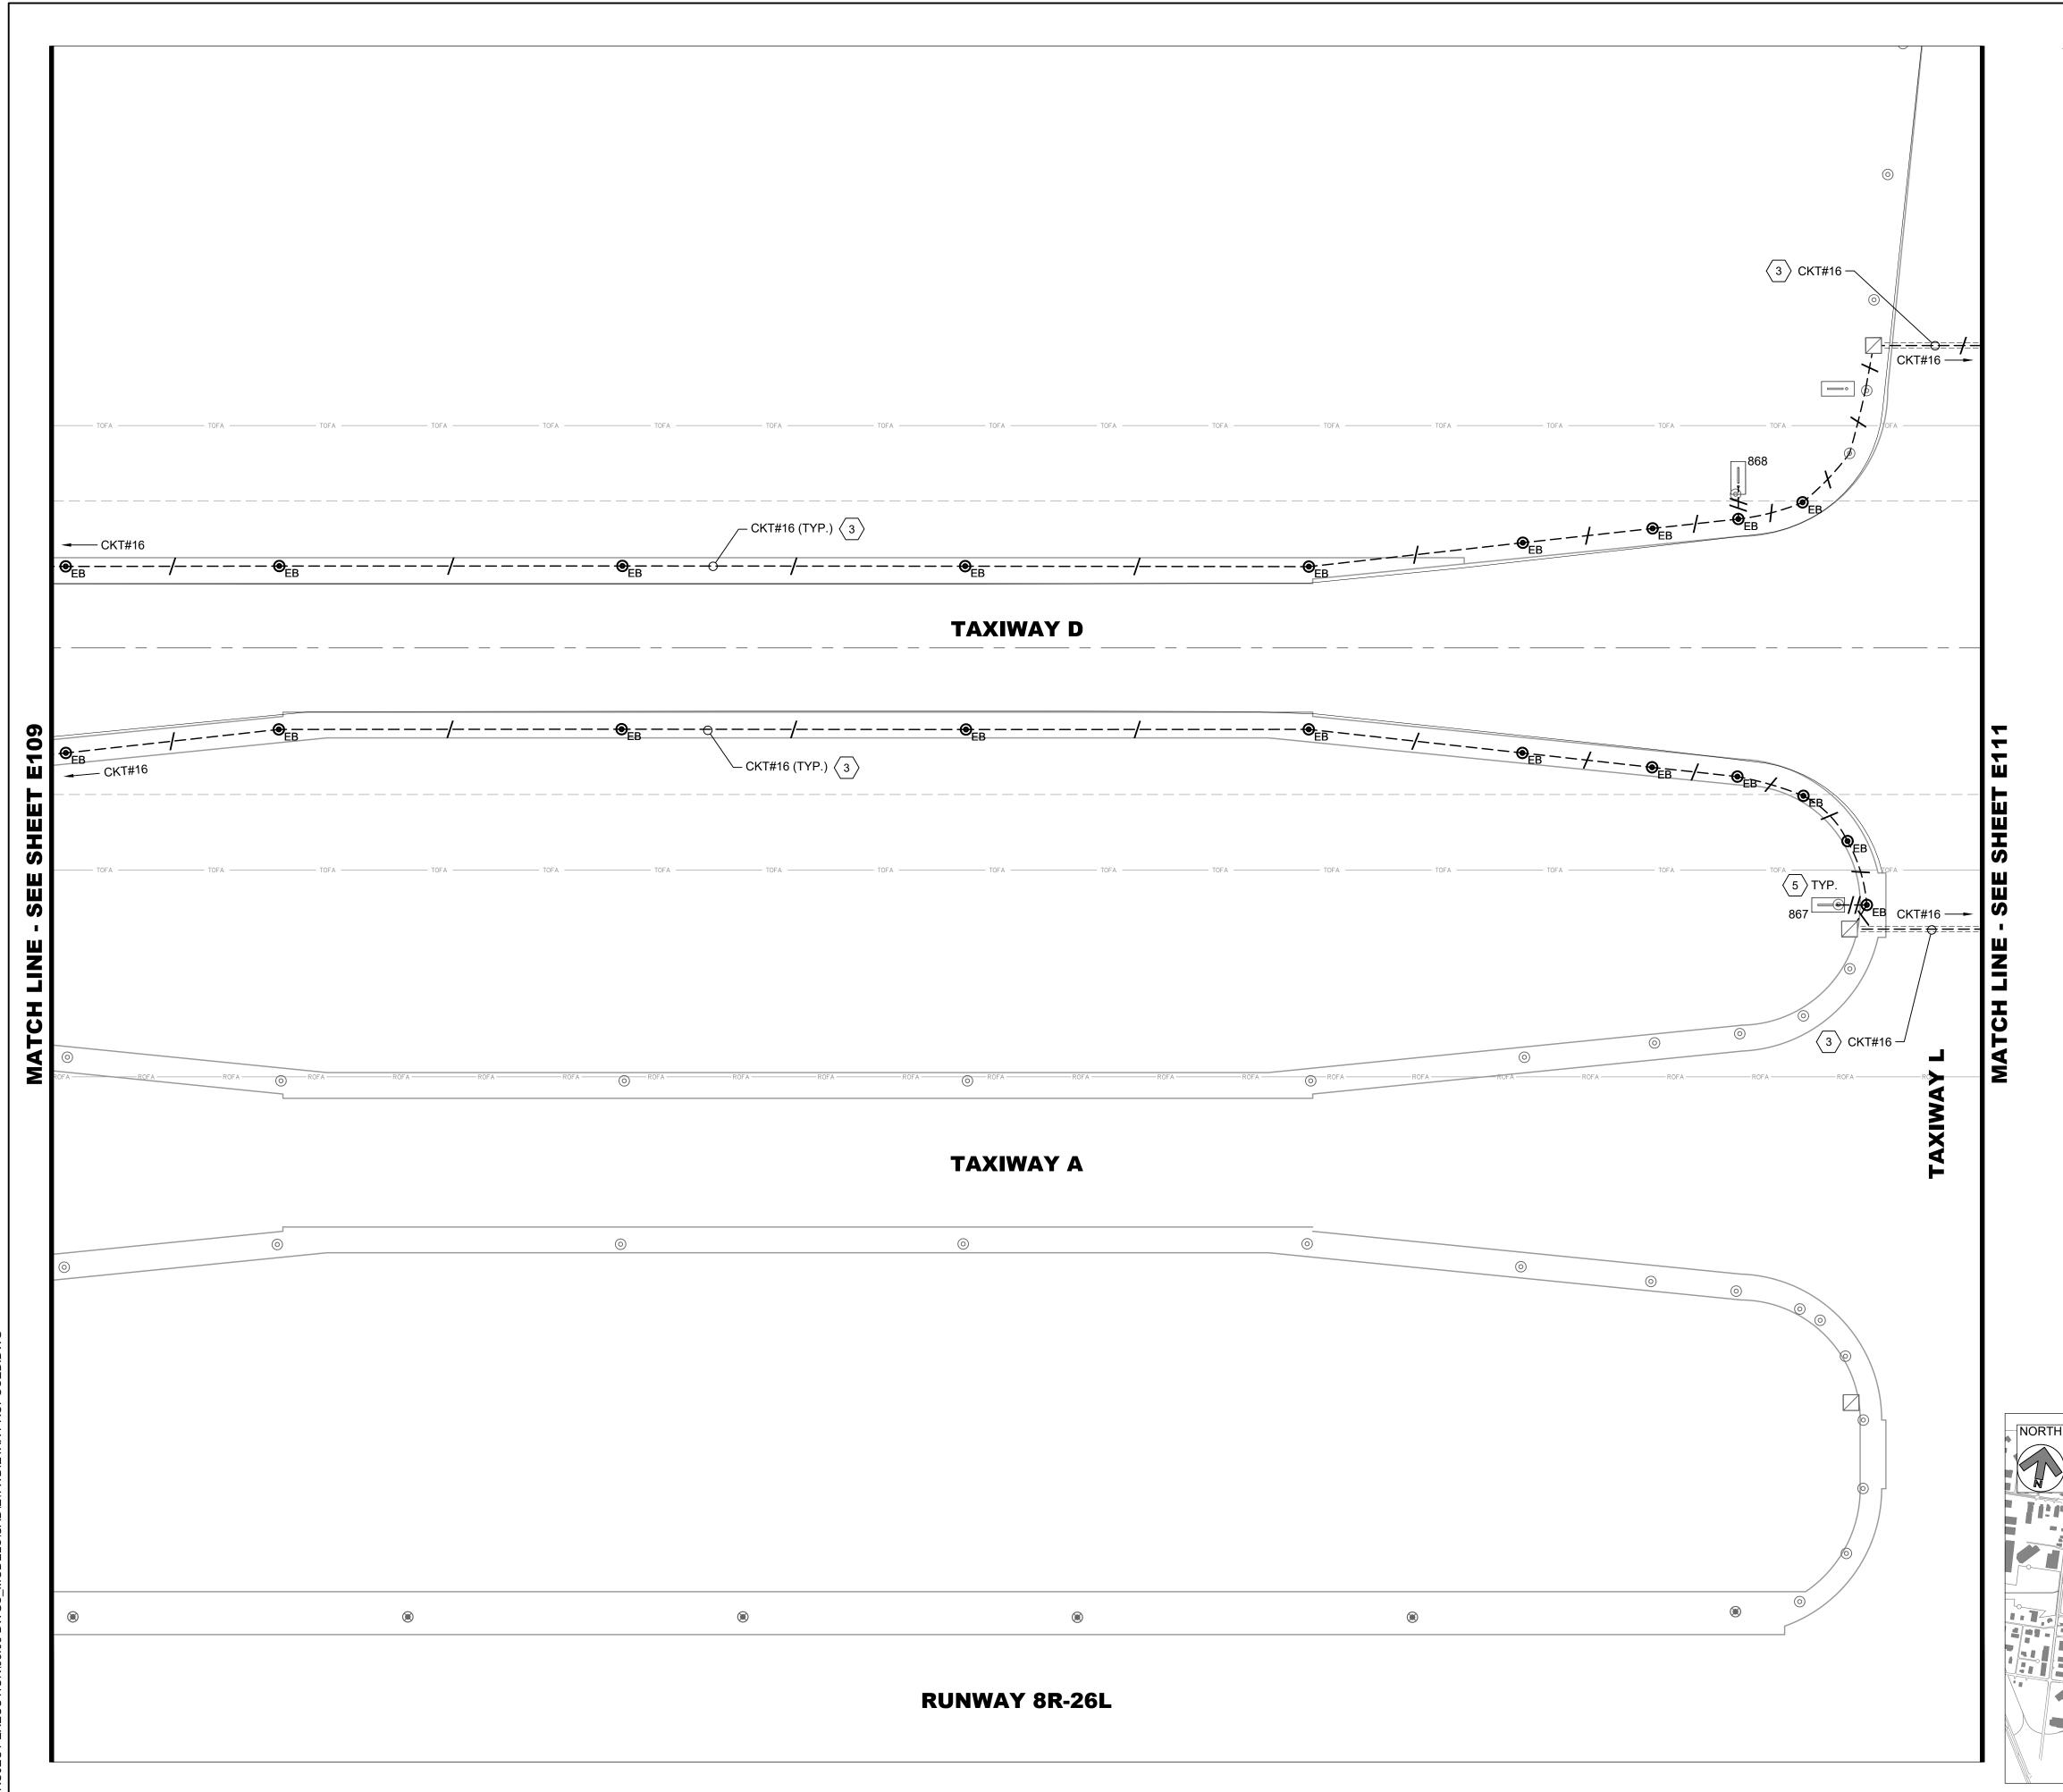

LEGEND: PROPOSED L-824 5KV CABLE IN EXISTING CONDUIT /-- CKT# HASH MARKS INDICATE NUMBER OF NEW L-824 CABLES INSTALLED IN EXISTING CONDUIT, CKT # = CIRCUIT DESIGNATOR EXISTING ELECTRICAL DUCT BANK EXISTING RUNWAY EDGE LIGHT TO REMAIN EXISTING TAXIWAY EDGE LIGHT TO REMAIN PROPOSED L-861T(L) ELEVATED OMNI-DIRECTIONAL MEDIUM INTENSITY TAXIWAY EDGE LIGHT (MITL) INSTALLED ON EXISTING BASE CAN EXISTING AIRFIELD GUIDANCE SIGN TO REMAIN EXISTING AIRFIELD GUIDANCE SIGN, PROVIDE NEW ISOLATION TRANSFORMER, SIGN TO REMAIN. XXX = SIGN NUMBER EXISTING WINDCONE TO REMAIN, PROVIDE NEW ISOLATION TRANSFORMER EXISTING SINGLE JUNCTION CAN TO REMAIN EXISTING ELECTRICAL HANDHOLE TO REMAIN

EXISTING ELECTRICAL MANHOLE TO REMAIN

EXISTING COMMUNICATIONS MANHOLE TO REMAIN

CKT #12 = TAXIWAY DELTA WEST

CKT #16 = TAXIWAY DELTA EAST

CKT #17 = TAXIWAY DELTA CENTER

GENERAL NOTES:

- 1. SEE E001 FOR GENERAL ELECTRICAL NOTES.
- 2. PROVIDE NEW ISOLATION TRANSFORMERS CONNECTED TO CIRCUITS #12, #16 AND #17, AT TAXIWAY EDGE LIGHTS, GUIDANCE SIGNS AND WINDCONES, AS APPLICABLE.
- 3. EXACT ROUTING OF CABLES THROUGH EXISTING INFRASTRUCTURE SHALL BE FIELD VERIFIED.
- 4. ALL CIRCUIT FEEDERS TO GUIDANCE SIGNS SHALL CONSIST OF 2/C L-824 5KV CABLES.


KEYED NOTES:

- (1) APPROXIMATE LOCATION OF EXISTING AIRFIELD LIGHTING ELECTRICAL VAULT. SEE SHEET E201 FOR PROPOSED SCOPE OF WORK. EXACT ROUTING OF "HOMERUN" CONDUITS AND DUCTBANKS TO VAULT SHALL BE FIELD DETERMINED.
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3 4 5 6 7 8 9 10 11 12

KEY PLAN

 \langle 5 \rangle EXISTING GUIDANCE SIGNS AND CONCRETE PADS TO REMAIN ON CIRCUITS #12, #16 AND #17. PROVIDE NEW ISOLATION TRANSFORMER AND CONNECTIONS. SIZE ISOLATION TRANSFORMER PER EACH SIGN LOAD, PER MANUFACTURER'S RECOMMENDATION.

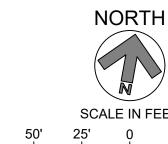

SCALE IN FEET

RS&H PROJECT NUMBER 1010-5865-001

SHEET TITLE

PROPOSED AIRFIELD LIGHTING PLAN-AREA 10

BID

DATE ISSUED: MAY 2025 REVIEWED BY: MAR

> DRAWN BY: AZ DESIGNED BY: EE

REVISIONS

RS&H Michigan, Inc.

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GERALD R. FORD

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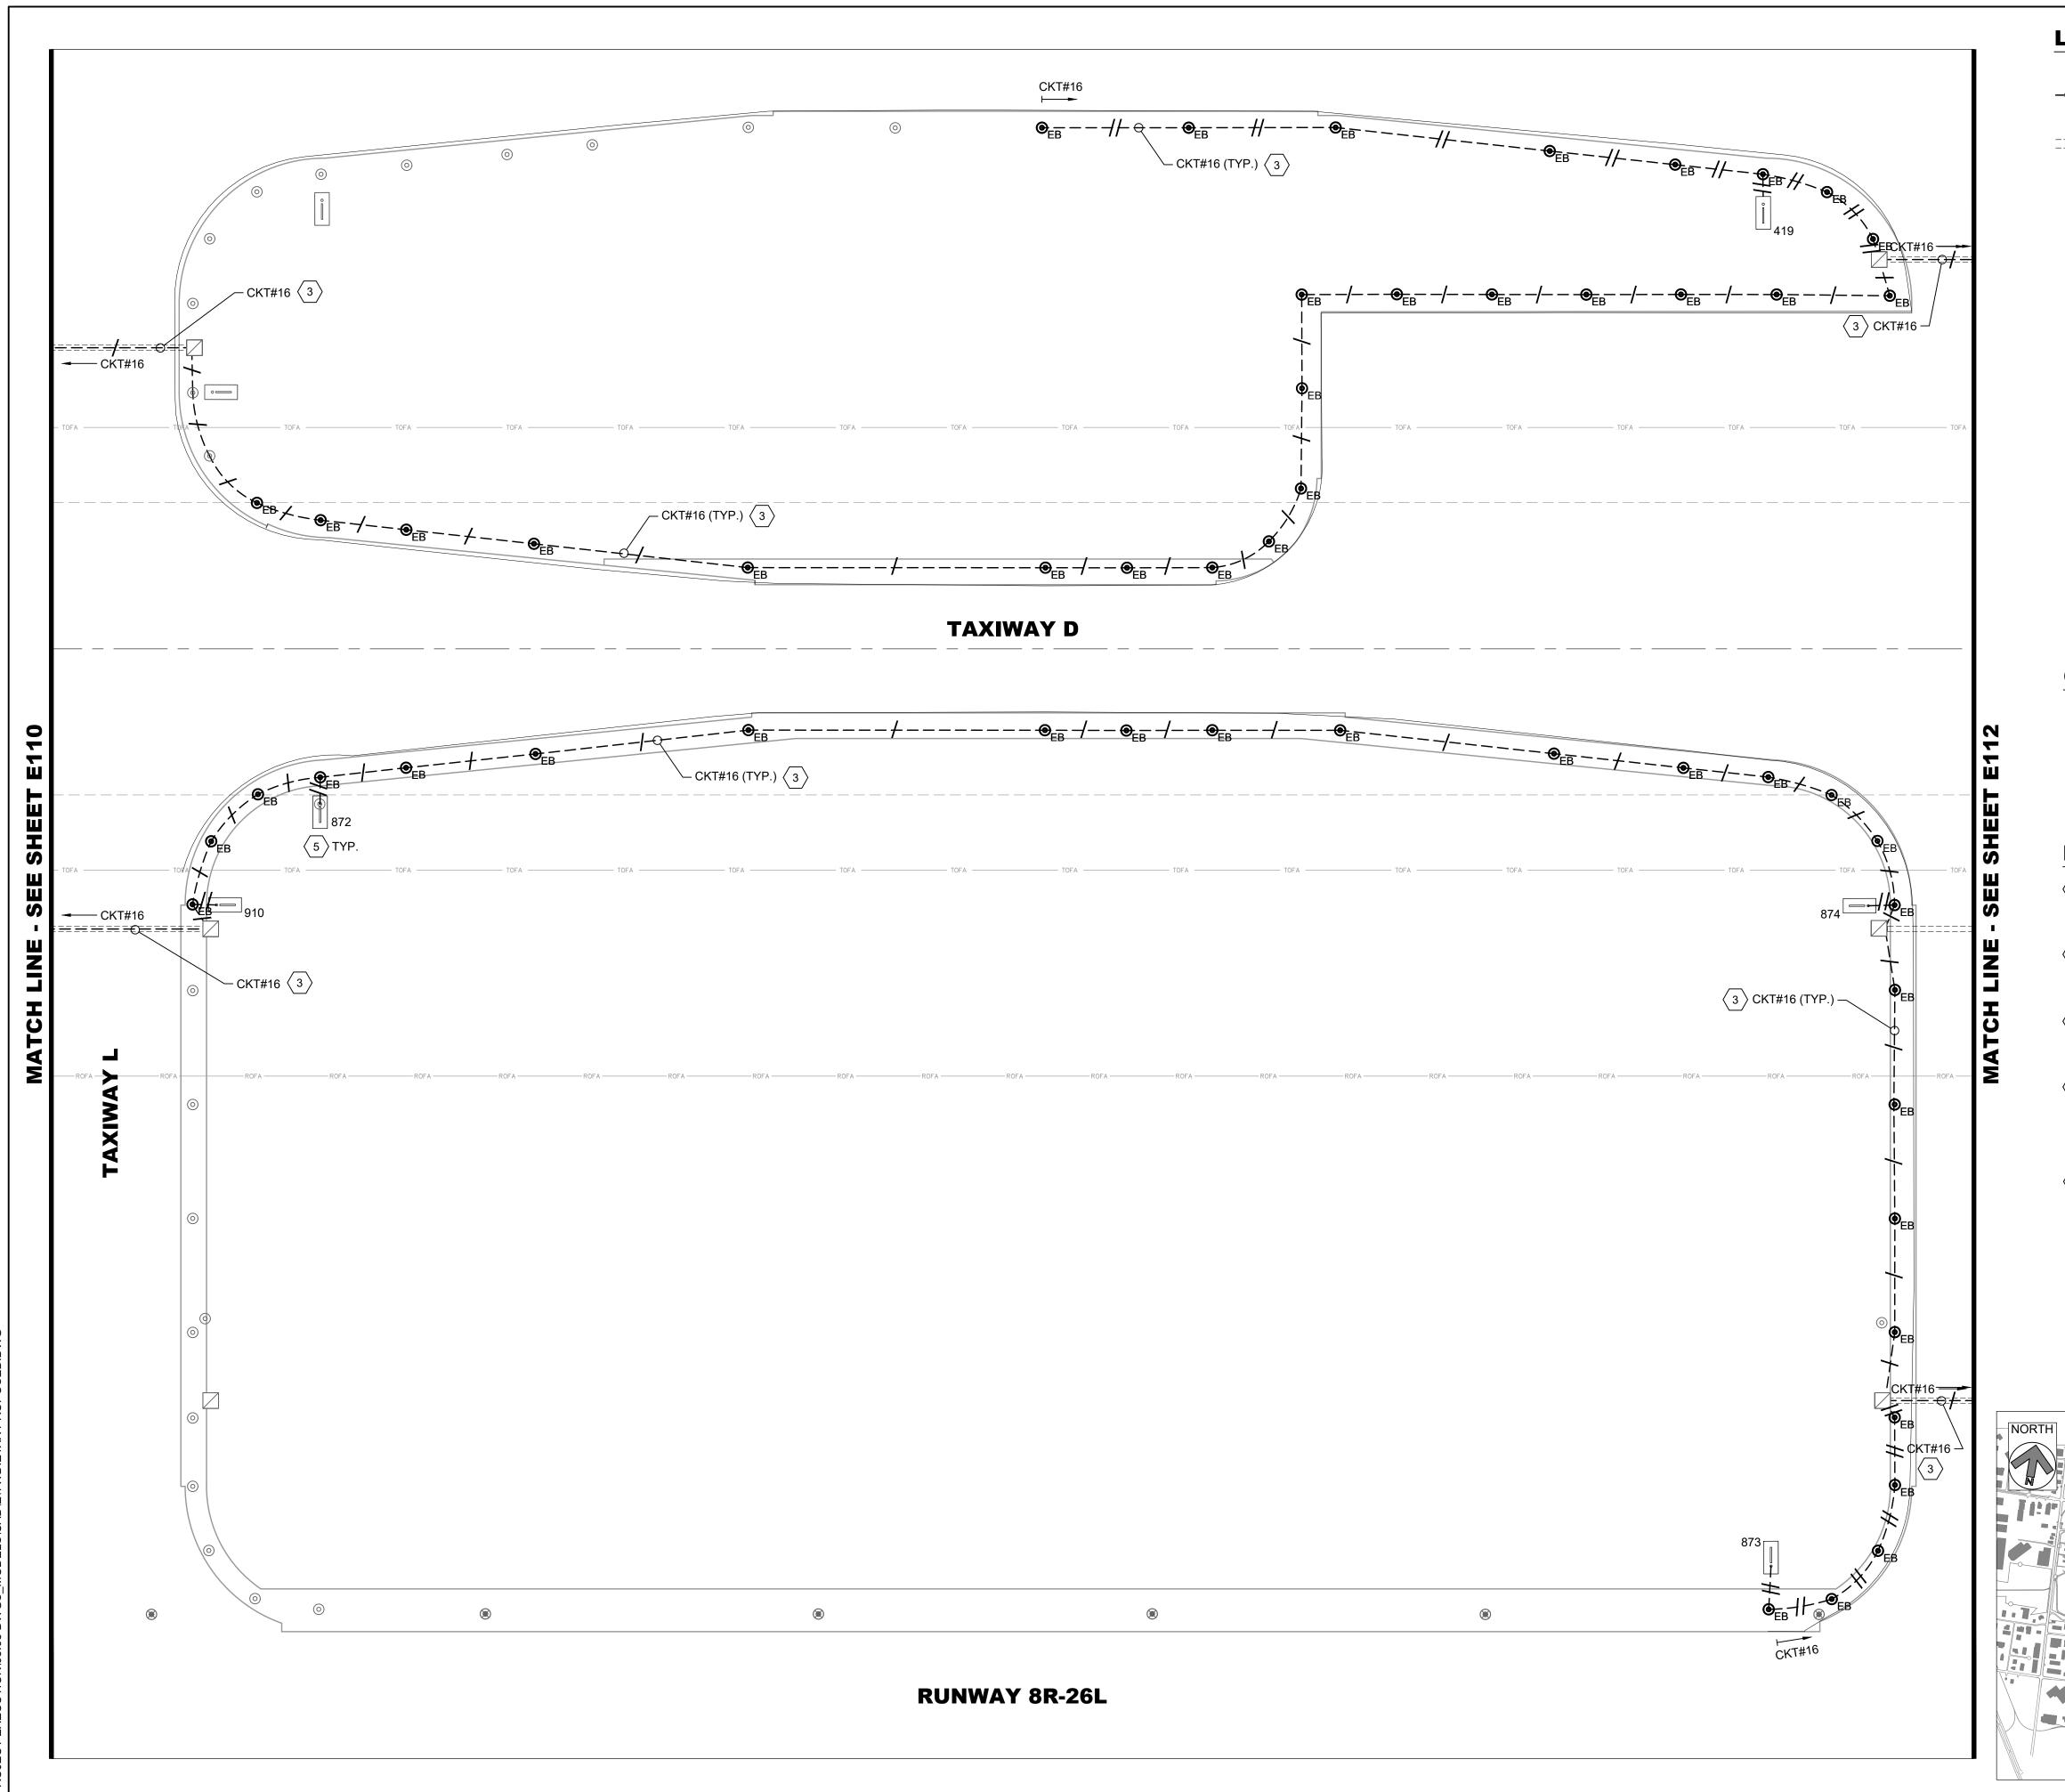
1-800-482-7171

NO. DESCRIPTION DATE

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SHEET NUMBER E110

ISSUED FOR



LEGEND: PROPOSED L-824 5KV CABLE IN EXISTING CONDUIT /-- CKT# HASH MARKS INDICATE NUMBER OF NEW L-824 CABLES INSTALLED IN EXISTING CONDUIT, CKT # = CIRCUIT DESIGNATOR EXISTING ELECTRICAL DUCT BANK EXISTING RUNWAY EDGE LIGHT TO REMAIN EXISTING TAXIWAY EDGE LIGHT TO REMAIN PROPOSED L-861T(L) ELEVATED OMNI-DIRECTIONAL MEDIUM INTENSITY TAXIWAY EDGE LIGHT (MITL) INSTALLED ON EXISTING BASE CAN EXISTING AIRFIELD GUIDANCE SIGN TO REMAIN EXISTING AIRFIELD GUIDANCE SIGN, PROVIDE NEW ISOLATION TRANSFORMER, SIGN TO REMAIN. XXX = SIGN NUMBER EXISTING WINDCONE TO REMAIN, PROVIDE NEW ISOLATION TRANSFORMER EXISTING SINGLE JUNCTION CAN TO REMAIN EXISTING ELECTRICAL HANDHOLE TO REMAIN EXISTING ELECTRICAL MANHOLE TO REMAIN

CKT #12 = TAXIWAY DELTA WEST

CKT #16 = TAXIWAY DELTA EAST

CKT #17 = TAXIWAY DELTA CENTER

GENERAL NOTES:

- 1. SEE E001 FOR GENERAL ELECTRICAL NOTES.
- 2. PROVIDE NEW ISOLATION TRANSFORMERS CONNECTED TO CIRCUITS #12, #16 AND #17, AT TAXIWAY EDGE LIGHTS, GUIDANCE SIGNS AND WINDCONES, AS APPLICABLE.

EXISTING COMMUNICATIONS MANHOLE TO REMAIN

- 3. EXACT ROUTING OF CABLES THROUGH EXISTING INFRASTRUCTURE SHALL BE FIELD VERIFIED.
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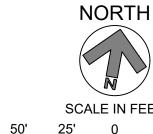
KEYED NOTES:

- (1) APPROXIMATE LOCATION OF EXISTING AIRFIELD LIGHTING ELECTRICAL VAULT. SEE SHEET E201 FOR PROPOSED SCOPE OF WORK. EXACT ROUTING OF "HOMERUN" CONDUITS AND DUCTBANKS TO VAULT SHALL BE FIELD DETERMINED.
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3 4 5 6 7 8 9 10 11 12

KEY PLAN

RUNWAY 8L-26R



SCALE IN FEET

RS&H PROJECT NUMBER 1010-5865-001

DRAWN BY: AZ DESIGNED BY: EE

DATE ISSUED: MAY 2025 REVIEWED BY: MAR

RS&H Michigan, Inc.

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LIGHTING

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1-800-482-7171

NO. DESCRIPTION DATE

REVISIONS

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PROPOSED AIRFIELD LIGHTING PLAN-

AREA 11

SHEET NUMBER

E111

PROPOSED L-824 5KV CABLE IN EXISTING CONDUIT /-- CKT# HASH MARKS INDICATE NUMBER OF NEW L-824 CABLES INSTALLED IN EXISTING CONDUIT, CKT # = CIRCUIT DESIGNATOR EXISTING ELECTRICAL DUCT BANK EXISTING RUNWAY EDGE LIGHT TO REMAIN

> EXISTING TAXIWAY EDGE LIGHT TO REMAIN PROPOSED L-861T(L) ELEVATED OMNI-DIRECTIONAL MEDIUM INTENSITY TAXIWAY EDGE LIGHT (MITL) INSTALLED ON EXISTING BASE CAN

EXISTING AIRFIELD GUIDANCE SIGN TO REMAIN EXISTING AIRFIELD GUIDANCE SIGN, PROVIDE

NEW ISOLATION TRANSFORMER, SIGN TO REMAIN. XXX = SIGN NUMBER EXISTING WINDCONE TO REMAIN, PROVIDE

NEW ISOLATION TRANSFORMER

EXISTING SINGLE JUNCTION CAN TO REMAIN

EXISTING ELECTRICAL HANDHOLE TO REMAIN

EXISTING ELECTRICAL MANHOLE TO REMAIN

EXISTING COMMUNICATIONS MANHOLE TO REMAIN

CKT #12 = TAXIWAY DELTA WEST

CKT #16 = TAXIWAY DELTA EAST

CKT #17 = TAXIWAY DELTA CENTER


GENERAL NOTES:

- 1. SEE E001 FOR GENERAL ELECTRICAL NOTES.
- 2. PROVIDE NEW ISOLATION TRANSFORMERS CONNECTED TO CIRCUITS #12, #16 AND #17, AT TAXIWAY EDGE LIGHTS, GUIDANCE SIGNS AND WINDCONES, AS APPLICABLE.
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KEYED NOTES:

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KEY PLAN



SCALE IN FEET

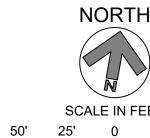RS&H PROJECT NUMBER 1010-5865-001

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DATE ISSUED: MAY 2025 REVIEWED BY: MAR

DRAWN BY: AZ DESIGNED BY: EE

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INTERNATIONAL **AIRPORT**

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LIGHTING

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NO. DESCRIPTION DATE

REVISIONS

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PROPOSED

AIRFIELD LIGHTING PLAN-AREA 12


SHEET NUMBER

ISSUED FOR BID

NORTH

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E112

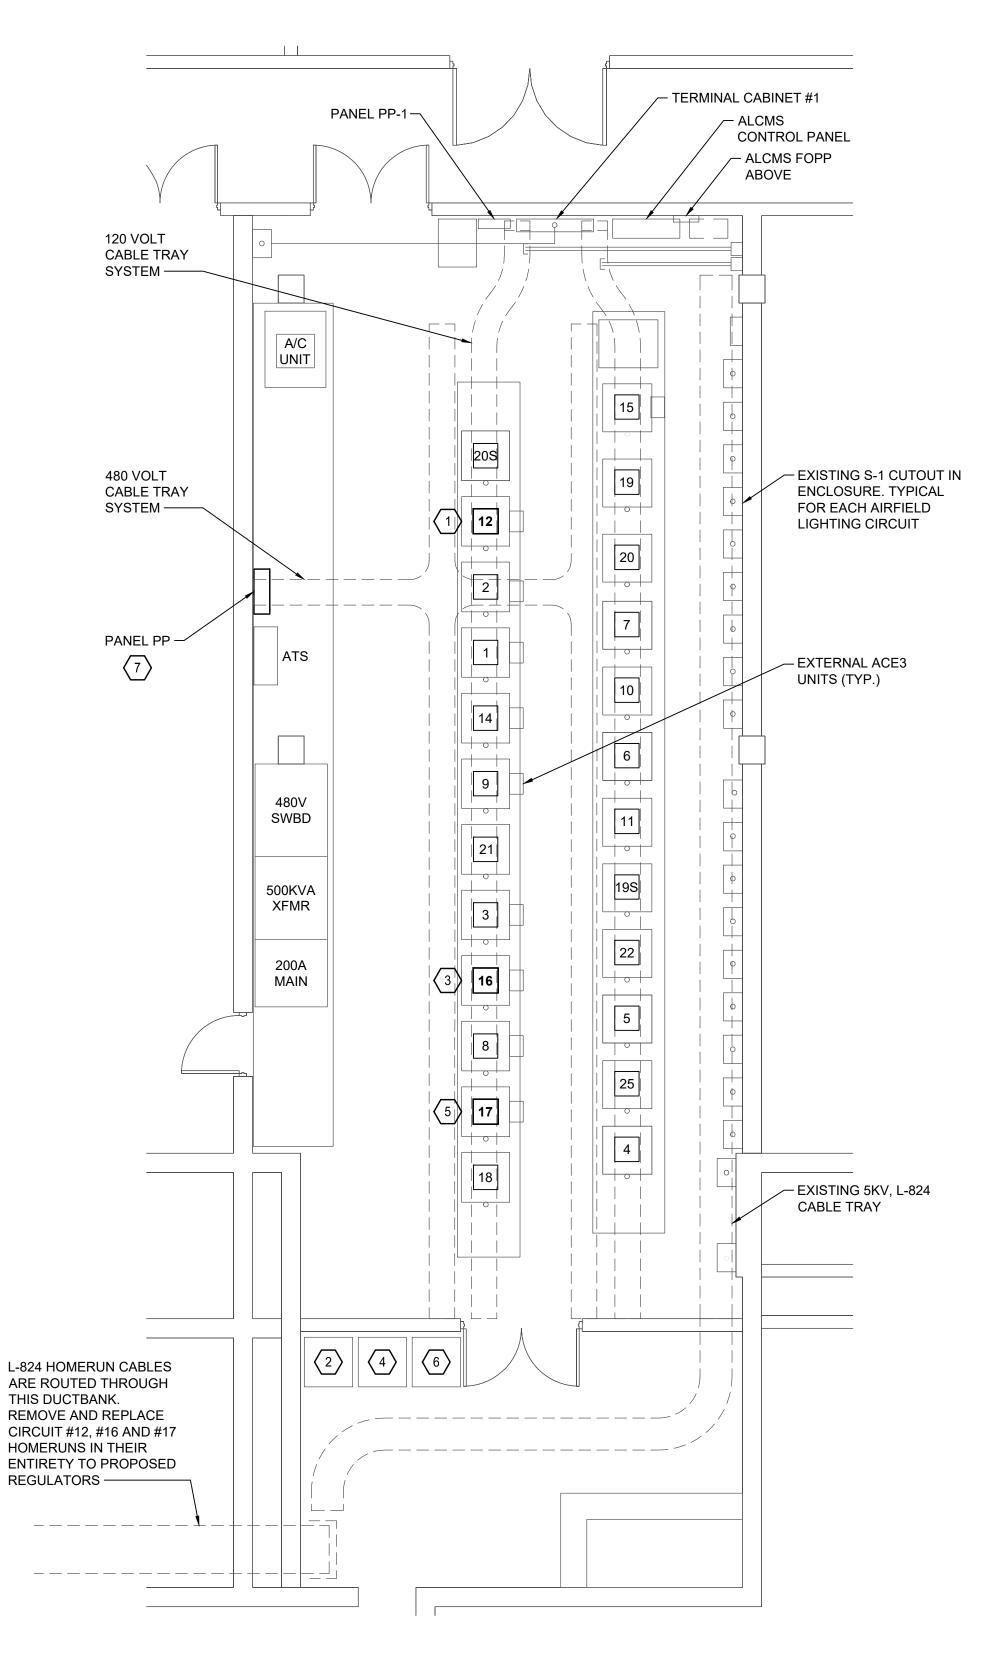


AIRFIELD LIGHTING ELECTRICAL VAULT DEMOLITION PLAN

IRCUIT #	CIRCUIT NAME	RATINGS	NOTES
1	TWY A - CENTER	15KW, 3-STEP, 6.6A, 480V, L-829	TO REMAIN
2	TWY A - EAST	15KW, 3-STEP, 6.6A, 480V, L-829	TO REMAIN
3	TWY A - WEST	15KW, 3-STEP, 6.6A, 480V, L-829	TO REMAIN
4	RWY 8R - 26L	15KW, 5-STEP, 6.6A, 480V, L-828	TO REMAIN
5	RWY 8R - 26L RGL'S	7.5KW, 3-STEP, 6.6A, 480V, L-828	TO REMAIN
6	RWY 17 - 35	15KW, 3-STEP, 6.6A, 480V, L-828	TO REMAIN
7	RWY 17 - 35 RGL'S	7.5KW, 3-STEP, 6.6A, 480V, L-828	TO REMAIN
8	TWY K	15KW, 3-STEP, 6.6A, 480V, L-829	TO REMAIN
9	TWY V & B	15KW, 3-STEP, 6.6A, 480V, L-829	TO REMAIN
10	TWY A - 1	4KW, 3-STEP, 6.6A, 480V, L-829	TO REMAIN
11	TWY A - 2	4KW, 3-STEP, 6.6A, 480V, L-829	TO REMAIN
<u></u>	TWY D - WEST	20KW, 3-STEP, 6.6A, 480V, L-829	TO BE REPLACED
13			
14	TWY B - SOUTH	15KW, 3-STEP, 6.6A, 480V, L-829	TO REMAIN
15	TWY F & G	15KW, 3-STEP, 6.6A, 480V, L-829	TO REMAIN
16	TWY D - EAST	15KW, 3-STEP, 6.6A, 480V, L-829	TO BE REPLACED
17	TWY D - CENTER	15KW, 3-STEP, 6.6A, 480V, L-829	TO BE REPLACED
18	TWY B - NORTH	7.5KW, 3-STEP, 6.6A, 480V, L-829	TO REMAIN
19	TWY J - WEST	10KW, 3-STEP, 6.6A, 480V, L-829	TO REMAIN
198	SPARE	30KW, 5-STEP, 6.6A, 480V, L-829	TO REMAIN
20	TWY J - EAST	10KW, 3-STEP, 6.6A, 240V, L-829	TO REMAIN
208	SPARE	30KW, 5-STEP, 6.6A, 480V, L-828	TO REMAIN
21	RWY 8L - 26R	20KW, 3-STEP, 6.6A, 240V, L-828	TO REMAIN
22	TWY B - 4	4KW, 3-STEP, 6.6A, 480V, L-829	TO REMAIN
23			
24			
25	TWY V - EAST, L, N	10KW, 3-STEP, 6.6A, 480V, L-829	TO REMAIN

REGULATOR SCHEDULE

				EXIS	STING PA	ANEL "PF	" SCHEI	DULE				
	DESIGNATION: LOCATION: VOLTAGE: PHASE:	BLDG	100, R0 7 VOL	ΓS	28			L MOU	ATING: NTING:	500 AM 600 AM SURFA 18 KAK	CE	
CKT.	LOAD		CKT.	BKR.		KVA		CKT.	BKR.		LOAD	CKT.
NO.	DESCRIPTION	KVA	AMPS	POLE	Α	В	С	AMPS	POLE	KVA	DESCRIPTION	NO.
1	CKT. 4 RUNWAY 8R-26L	16.62	80	2	33.24			80	2	16.62	CKT. 5 RUNWAY 8R-26L RGLS	2
3	CKT. 4 RUNWAY 8R-26L	16.62	80			33.24		80		16.62	CKT. 5 RUNWAY 8R-26L RGLS	4
5	CKT. 19 BACK-UP 30KW CCR	16.62	80	2			33.24	80	2	16.62	CKT. 6 RUNWAY 17-35	6
7	CKT. 19 BACK-UP 30KW CCR	16.62	80		33.24			80		16.62	CKT. 6 RUNWAY 17-35	8
9	CKT. 7 RUNWAY 17-35 RGLS	16.62	80	2		29.27		40	2	12.65	CKT. 17 TAXIWAY D-CENTER	10
11	CKT. 7 RUNWAY 17-35 RGLS	16.62	80				29.27	40		12.65	CKT. 17 TAXIWAY D-CENTER	12
13	CKT. 16 TAXIWAY D-EAST	13.1	40	2	27.91			60	2	14.81	CKT. 12 TAXIWAY D-WEST	14
15	CKT. 16 TAXIWAY D-EAST	13.1	40			27.91		60		14.81	CKT. 12 TAXIWAY D-WEST	16
17	CKT. 3 TAXIWAY A-WEST	8.86	40	2			17.72	40	2	8.86	CKT. 1 TAXIWAY A-CENTER	18
19	CKT. 3 TAXIWAY A-WEST	8.86	40		17.72			40		8.86	CKT. 1 TAXIWAY A-CENTER	20
21	CKT. 2 TAXIWAY A-EAST	8.86	40	2		13.29		20	2	4.43	SPARE	22
23	CKT. 2 TAXIWAY A-EAST	8.86	40				13.29	20		4.43	SPARE	24
25	CKT. 18 TAXIWAY B-NORTH	4.43	20	2	13.29			40	2	8.86	CKT. 14 TAXIWAY B-SOUTH	26
27	CKT. 18 TAXIWAY B-NORTH	4.43	20			13.29		40		8.86	CKT. 14 TAXIWAY B-SOUTH	28
29	CKT. 8 TAXIWAY K	8.86	40	2			17.72	40	2	8.86	CKT. 9 TAXIWAY V & B	30
31	CKT. 8 TAXIWAY K	8.86	40		17.72			40		8.86	CKT. 9 TAXIWAY V & B	32
33	CKT. 15 TAXIWAY F & G	8.86	40	2		17.72		40	2	8.86	SPARE	34
35	CKT. 15 TAXIWAY F & G	8.86	40				17.72	40		8.86	SPARE	36
37	NB WME ASOS	4.43	20	1	8.86			20	2	4.43	TOWER PANEL	38
39	NB WME ASOS	4.43	20	1		8.86		20		4.43	TOWER PANEL	40
41	CKT. 10 TAXIWAY A-1	4.43	20	1			8.86	20	2	4.43	CKT. 22 TAXIWAY B-4	42
43	CKT. 10 TAXIWAY A-1	4.43	20	1	8.86			20		4.43	CKT. 22 TAXIWAY B-4	44
45	CKT. 11 TAXIWAY A-2	4.43	20	1		11.07		30	2	6.64	CKT. 25 TAXIWAY V-EAST, L, N	46
47	CKT. 11 TAXIWAY A-2	4.43	20	1			11.07	30		6.64	CKT. 25 TAXIWAY V-EAST, L, N	48
49					0.00							50
51						0.00						52
53							0.00					54
55					0.00							56
57						0.00						58
59							0.00					60
	TOTAL CONNECTED	D LOAD:			160.84	154.65	148.89	TOT	AL =	464.38		

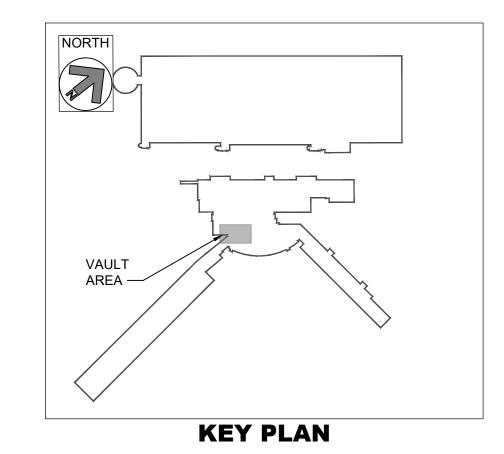

GENERAL NOTES:

- 1. EXISTING CONSTANT CURRENT REGULATORS BEING REPLACED SHALL BE RELOCATED AS SHOWN ON THE PLANS. EXACT LOCATION TO BE CONFIRMED WITH THE AIRPORT. REMOVAL AND REPLACEMENT SHALL BE DONE AT THE SAME TIME TO MINIMIZE DOWN TIME AND ONLY AFTER AIRFIELD CIRCUIT HAS BEEN COMPLETELY REPLACED WITH LED TRANSITION, TESTED, MEGGERED, AND ACCEPTED BY AIRPORT AND ENGINEER.
- 2. CONTRACTOR SHALL FOLLOW ALL AIRPORT LOCK-OUT-TAG-OUT PROCEDURES WHILE WORKING IN THE AIRFIELD LIGHTING ELECTRICAL VAULT.
- 3. ANY DOWN TIME FOR AIRFIELD CIRCUITS SHALL BE APPROVED IN ADVANCE, IN WRITING, AND SHALL BE COMPLETED WITHIN A SINGLE TIME PERIOD, WHICH SHALL BE ESTIMATED BY THE CONTRACTOR AND APPROVED BY THE AIRPORT AND ENGINEER.

KEYED NOTES:

- EXISTING CIRCUIT 12, TWY D-WEST CCR AND ACE3 UNIT TO BE DISCONNECTED FROM EXISTING POWER, CONTROLS AND GROUNDING AND RELOCATED TO $\left\langle 2 \right\rangle$
- 2 EXISTING CIRCUIT 12, TWY D-WEST CCR TO BE RELOCATED TO THIS LOCATION AND LEFT DISCONNECTED FROM POWER, CONTROLS AND GROUNDING.
- EXISTING CIRCUIT 16, TWY D-EAST CCR AND ACE3 UNIT TO BE DISCONNECTED FROM EXISTING POWER, CONTROLS AND GROUNDING AND RELOCATED TO $\sqrt{4}$
- EXISTING CIRCUIT 16, TWY D-EAST CCR TO BE RELOCATED TO THIS LOCATION AND LEFT DISCONNECTED FROM POWER, CONTROLS AND GROUNDING.
- 6 EXISTING CIRCUIT 17, TWY D-CENTER CCR TO BE RELOCATED TO THIS LOCATION AND LEFT DISCONNECTED FROM POWER, CONTROLS AND GROUNDING.
- (7) EXISTING PANEL "PP". RATED 277/480V, 3-PHASE, 4-WIRE, WITH 500A MCB. SEE SCHEDULE THIS SHEET.
- 8 EXISTING CIRCUIT BREAKERS AND WIRING FOR TAXIWAY CIRCUITS 12, 16, AND 17 TO INDIVIDUAL CCRS TO BE REPLACED. CONDUITS TO BE REUSED AND EXTENDED OR MODIFIED AS NEEDED FOR INSTALLATION OF NEW CCRS.



FORD International Airport

GERALD R. FORD INTERNATIONAL AIRPORT

TAXIWAY D LIGHTING REHABILITATION



NO.	DESCRI	PTION			
DATE	ISSUED:	MAY 20	25		
DEVIE	WFD RY:	MAR			

REVISIONS

REVIEWED BY: MAR
DRAWN BY: AZ
DESIGNED BY: EE

RS&H PROJECT NUMBER 1010-5865-001

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SHEET TITLE

AIRFIELD LIGHTING VAULT DEMOLITION PLAN


SHEET NUMBER

ED201

ISSUED FOR BID


ED201

SCALE: N.T.S

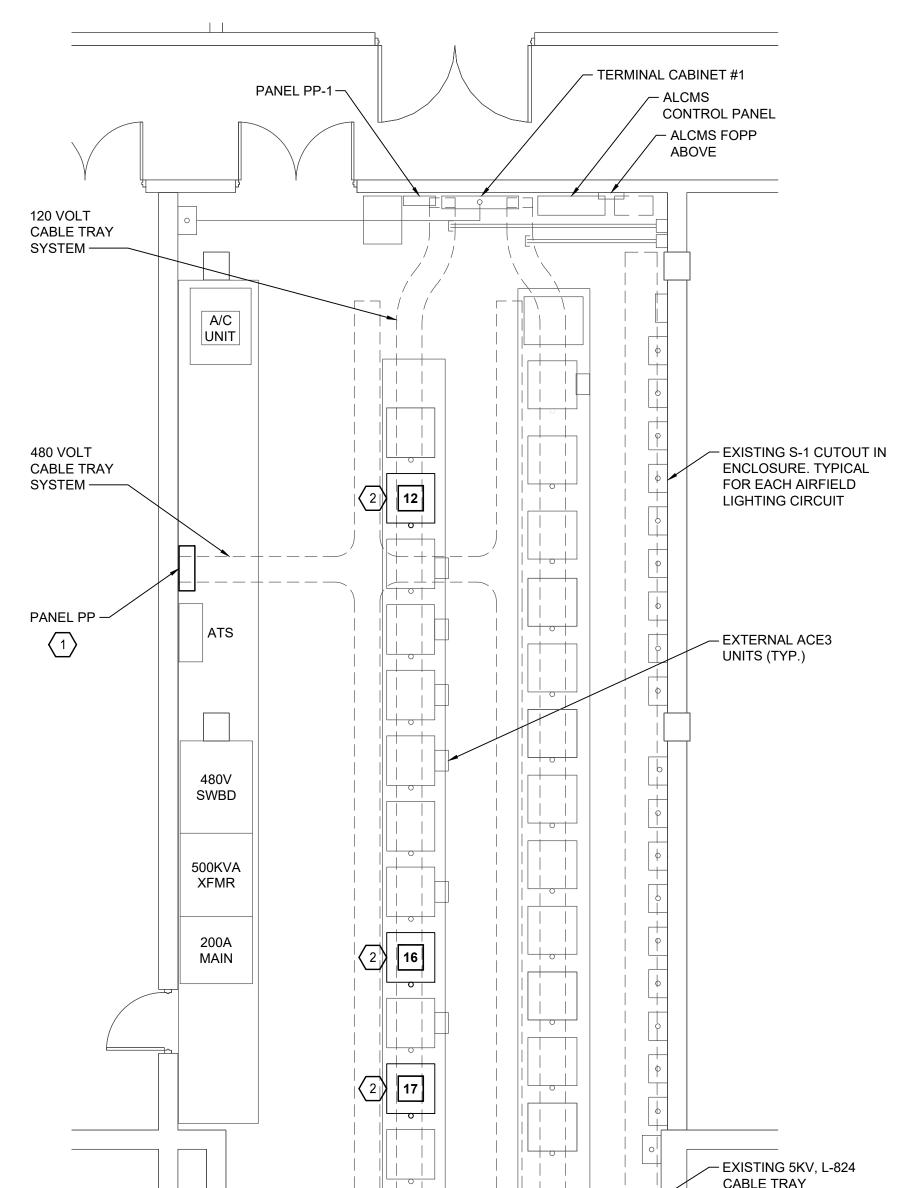

	PROPOSE	D REGULATOR SCHED	ULE
CIRCUIT#	CIRCUIT NAME	RATINGS	NOTES
12	TWY D - WEST	10KW, 3-STEP, 6.6A, 480V, L-829	1)3
16	TWY D - EAST	10KW, 3-STEP, 6.6A, 480V, L-829	1 3
17	TWY D - CENTER	10KW, 3-STEP, 6.6A, 480V, L-829	1 3

DESIGNATION: LOCATION: VOLTAGE: PHASE:	BLDG	100, R0 7 VOL	ΓS	28		1	L MOUI	ATING: NTING:	500 AM 600 AM SURFA 18 KAK	CE	
LOAD		CKT.	BKR.		KVA	•	CKT.	BKR.		LOAD	CKT.
DESCRIPTION	KVA	AMPS	POLE	Α	В	С	AMPS	POLE	KVA	DESCRIPTION	NO.
CKT. 4 RUNWAY 8R-26L	16.62	80	2	33.24			80	2	16.62	CKT. 5 RUNWAY 8R-26L RGLS	2
CKT. 4 RUNWAY 8R-26L	16.62	80			33.24		80		16.62	CKT. 5 RUNWAY 8R-26L RGLS	4
CKT. 19 BACK-UP 30KW CCR	16.62	80	2			33.24	80	2	16.62	CKT. 6 RUNWAY 17-35	6
CKT. 19 BACK-UP 30KW CCR	16.62	80		33.24			80		16.62	CKT. 6 RUNWAY 17-35	8
CKT. 7 RUNWAY 17-35 RGLS	16.62	80	2		24.27		40	2	7.65	CKT. 17 TAXIWAY D-CENTER	10
CKT. 7 RUNWAY 17-35 RGLS	16.62	80				24.27	40		7.65	CKT. 17 TAXIWAY D-CENTER	12
CKT. 16 TAXIWAY D-EAST	7.91	40	2	16.97			40	2	9.06	CKT. 12 TAXIWAY D-WEST	14
CKT. 16 TAXIWAY D-EAST	7.91	40			16.97		40		9.06	CKT. 12 TAXIWAY D-WEST	16
CKT. 3 TAXIWAY A-WEST	8.86	40	2			17.72	40	2	8.86	CKT. 1 TAXIWAY A-CENTER	18
CKT. 3 TAXIWAY A-WEST	8.86	40		17.72			40		8.86	CKT. 1 TAXIWAY A-CENTER	20
CKT. 2 TAXIWAY A-EAST	8.86	40	2		13.29		20	2	4.43	SPARE	22
CKT. 2 TAXIWAY A-EAST	8.86	40				13.29	20		4.43	SPARE	24
CKT. 18 TAXIWAY B-NORTH	4.43	20	2	13.29			40	2	8.86	CKT. 14 TAXIWAY B-SOUTH	26
CKT. 18 TAXIWAY B-NORTH	4.43	20			13.29		40		8.86	CKT. 14 TAXIWAY B-SOUTH	28
CKT. 8 TAXIWAY K	8.86	40	2			17.72	40	2	8.86	CKT. 9 TAXIWAY V & B	30
CKT. 8 TAXIWAY K	8.86	40		17.72			40		8.86	CKT. 9 TAXIWAY V & B	32
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CKT. 11 TAXIWAY A-2	4.43	20	1		11.07		30	2	6.64	CKT. 25 TAXIWAY V-EAST, L, N	46
CKT. 11 TAXIWAY A-2	4.43	20	1			11.07	30		6.64	CKT. 25 TAXIWAY V-EAST, L, N	48
				0.00							50
					0.00						52
						0.00					54
				0.00							56
					0.00						58
						0.00					60
	TOTAL CONNECTE	TOTAL CONNECTED LOAD:	TOTAL CONNECTED LOAD:	TOTAL CONNECTED LOAD:		0.00	0.00 0.00 0.00 0.00	0.00 0.00 0.00 0.00	0.00 0.00 0.00 0.00 0.00 0.00 0.00 0.0	0.00 0.00 0.00 0.00 0.00 0.00 0.00 0.0	0.00 0.00 0.00 0.00 0.00 0.00 0.00 0.0

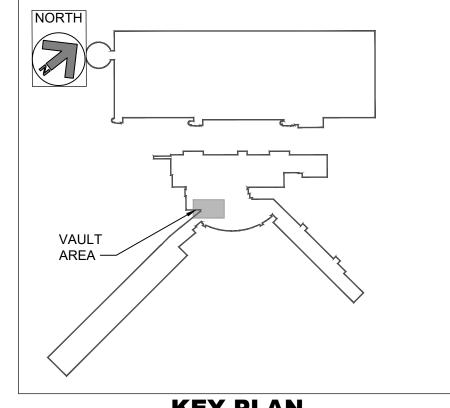


GENERAL NOTES:

- 1. EXISTING CONSTANT CURRENT REGULATORS BEING REPLACED SHALL BE RELOCATED AS SHOWN ON THE PLANS. EXACT LOCATION TO BE CONFIRMED WITH THE AIRPORT. REMOVAL AND REPLACEMENT SHALL BE DONE AT THE SAME TIME TO MINIMIZE DOWN TIME AND ONLY AFTER AIRFIELD CIRCUIT HAS BEEN COMPLETELY REPLACED WITH LED TRANSITION, TESTED, MEGGERED, AND ACCEPTED BY AIRPORT AND ENGINEER.
- 2. CONTRACTOR SHALL FOLLOW ALL AIRPORT LOCK-OUT-TAG-OUT PROCEDURES WHILE WORKING IN THE AIRFIELD LIGHTING ELECTRICAL VAULT.
- 3. ANY DOWN TIME FOR AIRFIELD CIRCUITS SHALL BE APPROVED IN ADVANCE, IN WRITING, AND SHALL BE COMPLETED WITHIN A SINGLE TIME PERIOD, WHICH SHALL BE ESTIMATED BY THE CONTRACTOR AND APPROVED BY THE AIRPORT AND ENGINEER.

KEYED NOTES:

- \langle 1 \rangle REPLACE EXISTING 2-POLE CIRCUIT BREAKERS FOR TAXIWAY CIRCUITS 12, 16, AND 17 WITH NEW 40A, 2-POLE CIRCUIT BREAKERS (EVEN IF SAME SIZE). REPLACE WIRING BETWEEN PANEL "PP" TO EACH CCR WITH 2#8 THWN, 1#10G IN EXISTING CONDUITS (EVEN IF SAME SIZE). EXTEND CONDUITS (RIGID AND FLEXIBLE) AS NEEDED FOR INSTALLATION OF NEW CCR. REPLACE GROUND WIRE BETWEEN CCR AND GROUND BUS TO MATCH EXISTING.
- 2 PROPOSED 10KW, 480V, 6.6A, 3-STEP CCR SHALL BE ADB SAFEGATE (WITH ACE3, IRMS, INPUT POWER MONITOR) OR EQUAL. CONTRACTOR SHALL REESTABLISH PRIMARY POWER, CONTROLS AND 5KV "HOMERUN" COMPLETE AND OPERATIONAL. ANY ITEMS REQUIRED FOR REPLACEMENT SHALL BE PROVIDED. NO MODIFICATIONS TO THE EXISTING ALCMS ARE ANTICIPATED. TRANSFER NAMEPLATES FROM OLD CCRS TO NEW CCRS. NEW CCRS SHALL BE COMPLETELY COMPATIBLE WITH EXISTING ALCMS AND SHALL MATCH ALL EXISTING CONTROLS, TESTING AND MONITORING CAPABILITIES.
- (3) EXISTING CONTROL WIRING AND CONDUITS SHALL BE REUSED AND EXTENDED, AS NEEDED, TO ACCOMMODATE NEW CCR CONNECTION POINTS.

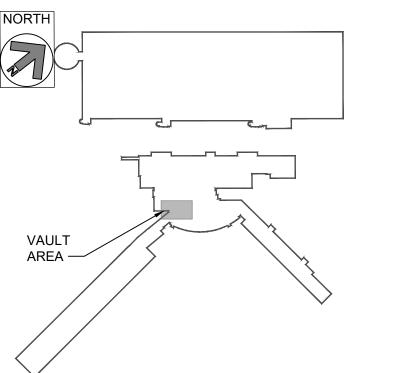

KEY PLAN



RS&H Michigan, Inc.

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www.rsandh.com

GERALD R. FORD INTERNATIONAL **AIRPORT**

TAXIWAY D

LIGHTING

REHABILITATION

REVISIONS NO. DESCRIPTION DATE

DATE ISSUED: MAY 2025 REVIEWED BY: MAR DRAWN BY: AZ DESIGNED BY: EE

> **RS&H PROJECT NUMBER** 1010-5865-001

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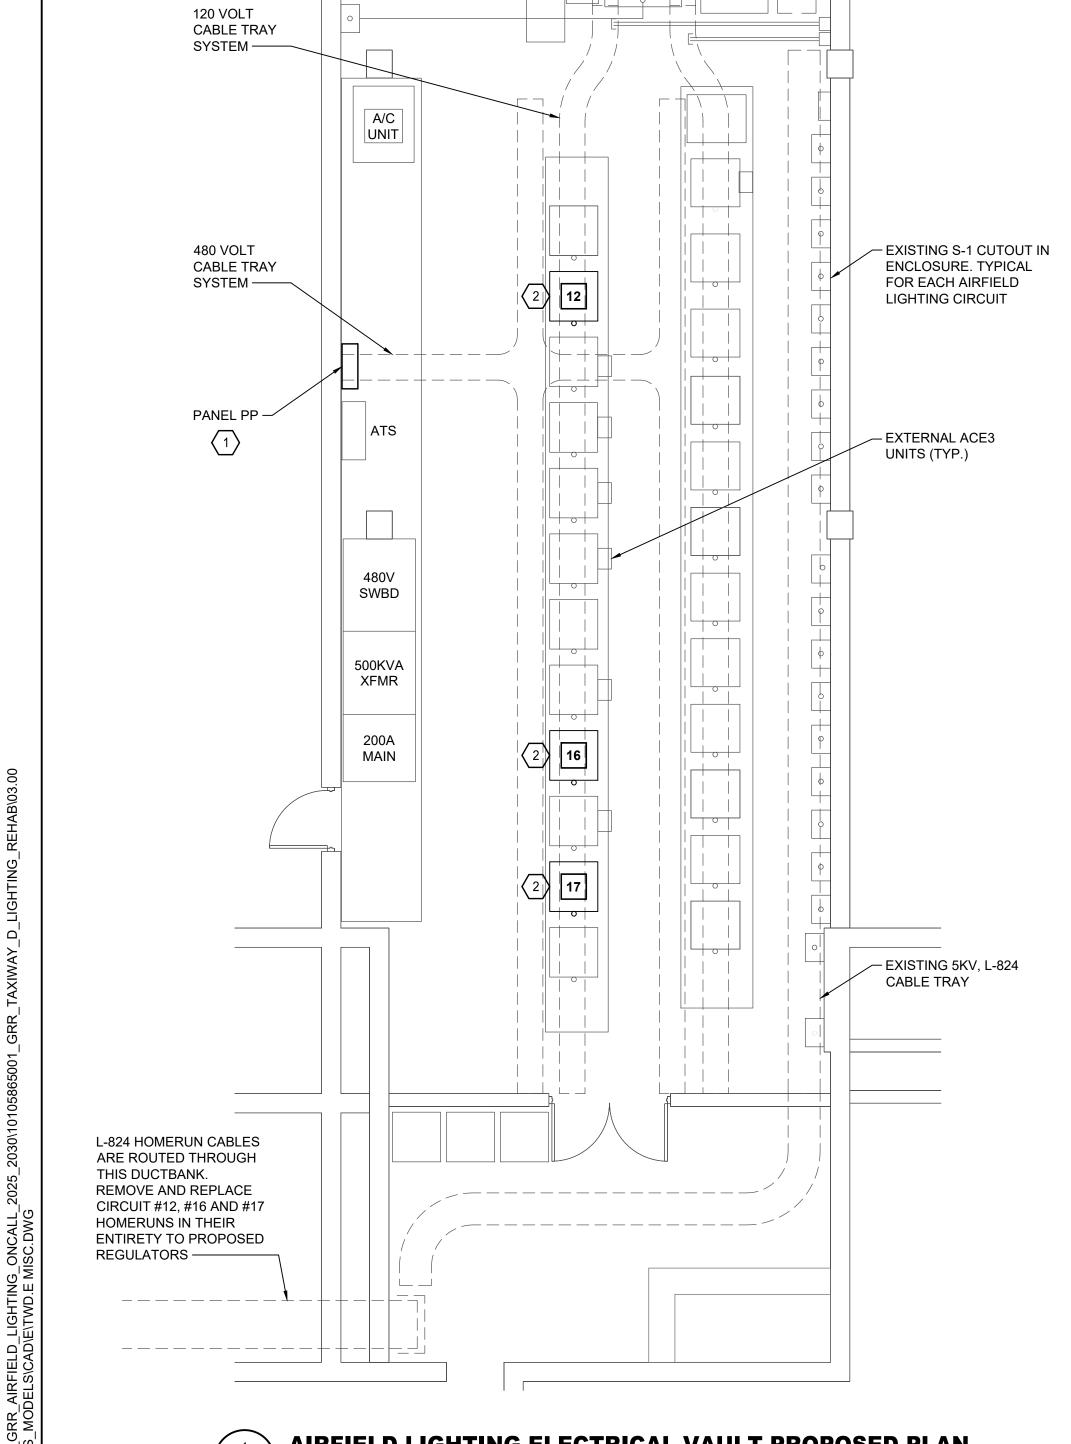
SHEET TITLE

AIRFIELD LIGHTING VAULT PROPOSED PLAN

SHEET NUMBER

E201

ISSUED FOR BID



E201


AIRFIELD LIGHTING ELECTRICAL VAULT PROPOSED PLAN SCALE: N.T.S

TAXIWAY CABLE TAGGING SCHEDULE									
EXISTING CIRCUIT DESIGNATION	PROPOSED CIRCUIT NAME								
TAXIWAY D - WEST	TW-D CKT. 12								
TAXIWAY D - CENTER	TW-D CKT. 17								
TAXIWAY D - EAST	TW-D CKT. 16								

CABLE ID TAG AND TAGGING SCHEDULE DETAIL E301 SCALE: N.T.S SNOW WAND SEE NOTE 13 -PROPOSED 30" HIGH LED ELEVATED TAXIWAY PROPOSED FIXTURE STEM -**EDGE LIGHT** PROPOSED LIGHT FIXTURE COVER PLATE -- PROPOSED FRANGIBLE COUPLING AND DISCONNECT PLUG PROPOSED COVER PLATE ANCHOR BOLTS -PROPOSED L-823 SECONDARY CONNECTOR - EXISTING 12" DIAMETER, 24" DEEP L-867 LIGHT BASE CAN - EXISTING 6" CONCRETE ENCASEMENT AROUND BASE PROPOSED L-823 PRIMARY CONNECTOR (TYP) -PROPOSED ISOLATION TRANSFORMER SIZED BY LIGHT FIXTURE MANUFACTURER -EXISTING L-824, 5KV WIRING TO - SEE NOTE 12 BE REMOVED AND REPLACED — EXISTING 2" PVC CONDUIT WITH PVC END BELLS AT BASE CAN ENTRANCE -**EXISTING NEOPRENE GROMMET -**



EXISTING 6" BASE #57 CRUSHED AGGREGATE

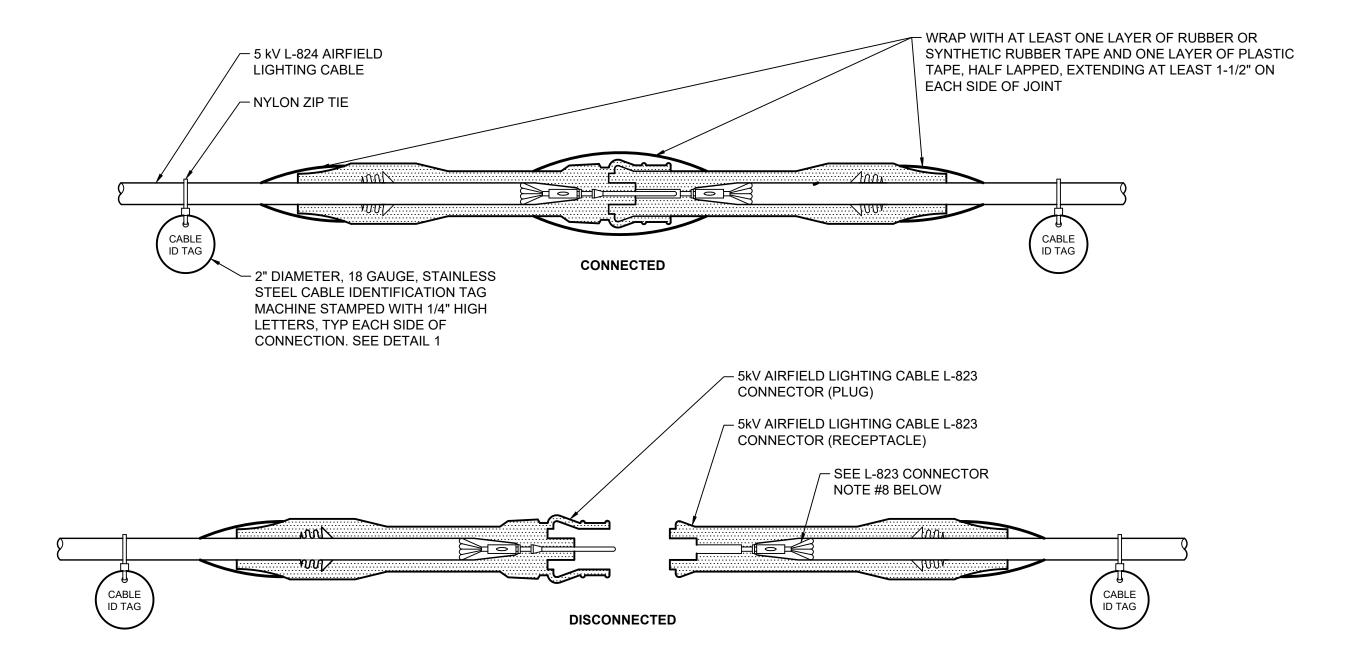

L-823 CONNECTOR NOTES:

- 1. L-823 CONNECTOR MUST BE INTEGRO "COMPLETE KIT" (PART 11805-01) OR EQUIVALENT.
- 2. COORDINATE OUTSIDE DIAMETER OF EACH CABLE TYPE WITH ITS RESPECTIVE CONNECTOR KIT IN ORDER TO ASSURE WATERTIGHT CONNECTION BETWEEN CABLES AND CONNECTOR BOOTS.
- 3. FOLLOW ALL CONNECTOR MANUFACTURER'S CABLE CLEANING, CABLE PREPARATION, AND CONNECTOR INSTALLATION INSTRUCTIONS.
- 4. CONTRACTOR MUST USE CRIMPING TOOL MANUFACTURED BY, OR SPECIFICALLY RECOMMENDED BY, CONNECTOR MANUFACTURER WHEN INSTALLING CONNECTOR PINS AND CONNECTOR RECEPTACLES, TURN OVER CRIMPING TOOL TO AIRPORT AT PROJECT COMPLETION.
- 5. ATTACH CABLE IDENTIFICATION TAGS ON BOTH SIDES OF CONNECTION.

- 6. ATTACH CABLE IDENTIFICATION TAG TO CABLE WITH NYLON ZIP TIE, TIGHTEN ZIP TIE TO HOLD CABLE IDENTIFICATION TAG IN PLACE WITHOUT COMPRESSING CABLE INSULATION, TRIM OFF EXCESS ZIP TIE AFTER TIGHTENING.
- 7. COORDINATE CIRCUIT NAMING CONVENTION OF CABLE IDENTIFICATION TAGS, ALONG WITH SIZE OF CABLE IDENTIFICATION TAGS, WITH OWNER PRIOR TO ORDERING AND INSTALLING CABLE IDENTIFICATION TAGS.
- 8. USE PROPERLY SIZED AIRFIELD LIGHTING CABLE INSULATION STRIPPER/PENCILER (RIPLEY UTILITY TOOL WS 49 SERIES OR APPROVED EQUIVALENT) TO REMOVE INSULATION, KNIVES OR BOX CUTTERS MUST NOT BE USED.



L-823 5kV AIRFIELD LIGHTING CABLE CONNECTOR DETAIL

SCALE: N.T.S

ELEVATED TAXIWAY LIGHT LED UPGRADE NOTES:

- 1. ALL HARDWIRED TO BE REPLACED
- 2. ANY BROKEN BOLTS SHALL BE REMOVED AND BASES SHALL BE DRILLED AND TAPPED, AS NEEDED FOR NEW HARDWARE.
- 3. FIXTURE STEMS SHALL BE PROVIDED WITH RETRO-REFLECTIVE TAPE, TO MATCH EXISTING FIXTURES.
- 4. ALL NEW BOLTS TO BE STAINLESS STEEL.
- 5. USE ANTI-SIEZE COMPOUND ON ALL BOLTS.
- EXISTING FIXTURES AND TRANSFORMERS THAT ARE REMOVED SHALL BE TURNED OVER TO THE AIRPORT.
- 7. EXISTING WIRING THAT IS REMOVED SHALL BE DISPOSED OFF SITE.
- 8. EXISTING GROUNDING AND COUNTERPOISE TO REMAIN AND SHALL BE PROTECTED DURING CONSTRUCTION. ANY DAMAGED GROUNDING OR COUNTERPOISE SHALL BE REPAIRED TO MATCH ORIGINAL INSTALLATION.
- 9. NEW ISOLATION TRANSFORMER SHALL BE PLACED ON EXISTING BRICK. IF BRICK IS MISSING, PROVIDE NEW BRICK.
- 10. NOT ALL BASE CANS HAVE DRAINS. IF DRAINS EXIST, CLEAN OUT DRAIN AND DO NOT BLOCK WITH CONCRETE BRICK.
- 11. NEW LED LIGHTING SHALL NOT HAVE ARCTIC KITS.
- 12. WRAP WITH AT LEAST ONE LAYER OF RUBBER OR SYNTHETIC RUBBER TAPE AND ONE LAYER OF PLASTIC TAPE, HALF LAPPED, EXTENDED AT LEAST 1 1/2" ON EACH SIDE OF FIELD SPLICE.
- 13. SNOW WANDS SHALL BE TURNED OVER TO THE AIRPORT AND INSTALLED AT A LATER TIME.



RS&H Michigan, Inc.

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GERALD R. FORD INTERNATIONAL AIRPORT

TAXIWAY D LIGHTING REHABILITATION



DESCRIPTION	
	DESCRIPTION

DATE ISSUED: MAY 2025
REVIEWED BY: MAR
DRAWN BY: AZ
DESIGNED BY: EE

RS&H PROJECT NUMBER 1010-5865-001

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SHEET TITLE

GENERAL ELECTRICAL DETAILS

SHEET NUMBER

E301

ISSUED FOR BID

EXISTING CONCRETE BRICK -

EXISTING 1" PVC DRAIN PIPE WITH

OF BASE CAN. SEE NOTE 10 -

NEOPRENE GROMMET AT BOTTOM



EXISTING PANEL "PP"

SCALE: N.T.S

 EXISTING BREAKERS FOR TWY D-EAST, D-WEST, AND D-CENTER TO BE REPLACED





EXISTING TWY D-EAST REGULATOR

SCALE: N.T.S

 EXISTING TWY D-EAST, CIRCUIT #16 REGULATOR TO BE REPLACED. EXISTING ACE3 UNIT TO BE REMOVED.



2 E S02 S0

EXISTING TWY D-WEST REGULATOR

SCALE: N.T.S

EXISTING TWY D-WEST, CIRCUIT #12
 REGULATOR TO BE REPLACED. EXISTING ACE3
 UNIT TO BE REMOVED.





EXISTING TWY D-CENTER, CIRCUIT #17
 REGULATOR TO BE REPLACED. EXISTING ACE3
 UNIT TO BE REMOVED.



RS&H Michigan, Inc.

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GERALD R. FORD INTERNATIONAL AIRPORT

TAXIWAY D LIGHTING REHABILITATION



REVISIONS

NO. DESCRIPTION DATE

DATE ISSUED: MAY 2025
REVIEWED BY: MAR
DRAWN BY: AZ
DESIGNED BY: EE

RS&H PROJECT NUMBER 1010-5865-001

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SHEET TITLE

EXISTING INSTALLATION PHOTOS

SHEET NUMBER

E302